
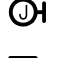

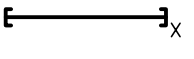
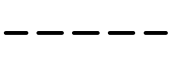
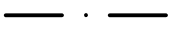





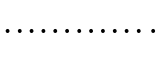
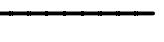



ELECTRICAL SYMBOLS

DESCRIPTIONS	MH (UON)	SYMBOL
 JUNCTION BOX		
 JUNCTION BOX – WALL MOUNTED	18" CTR	
 JUNCTION BOX – FLOOR MOUNTED FOR CABLE ROUTING IN FURNITURE AND CABINETS		
 CONDUIT, 4-IN EMT, UON. X DENOTES QUANTITY.		
 WIRING INSIDE ENCLOSURE		
 FIELD WIRING		

TELECOMMUNICATIONS DRAWING





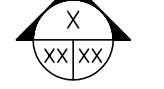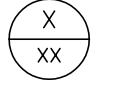







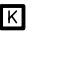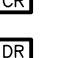







PRESENTATION

SYMBOL	DESCRIPTIONS
	REVISION NUMBER 2
	DRAWING NOTE NUMBER 2
	SECTION/ELEVATION IDENTIFICATION
	PART PLAN AND DETAIL IDENTIFICATION
	EXISTING LINE TYPE
	NEW TELECOMMUNICATIONS WORK LINE TYPE
	FUTURE TELECOMMUNICATIONS WORK LINE TYPE
	DEMOLITION LINE TYPE ON DEMOLITION DRAWINGS

GENERAL NOTES:

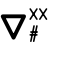- THIS IS A STANDARD SYMBOL LIST. SOME SYMBOLS MAY NOT APPEAR ON THE ACCOMPANYING DRAWINGS.
- REFER TO SPECIFICATIONS FOR DETAILED REQUIREMENTS.
- PLAN & SECTION SYMBOLS MAY ALSO BE USED ON RISER DIAGRAMS.
- UNLESS OTHERWISE NOTED ALL INTERIOR CONDUITS AND BOXES SHALL BE CONCEALED.
- LINE TYPES APPLY TO LINES AND SYMBOLS.

TELECOMMUNICATIONS SYMBOLS

DESCRIPTIONS	MH (UON)	SYMBOL
 KEYPAD	48" TOD	
 CARD READER	48" TOD	
 DOOR RELEASE BUTTON		
 DOOR CONTACT		
 REQUEST TO EXIT DEVICE, MOUNTED ABOVE DOOR		
 CCTV CAMERA		
 DURESS BUTTON		
 DATA CEILING OUTLET, FOR WIRELESS ACCESS POINT, BLUE CATEGORY 6 CABLES AND MODULES.		
 DATA CEILING OUTLET, FOR BAGGAGE INFORMATION DISPLAY SYSTEM. TWO (2) BLUE CATEGORY 6 CABLES AND MODULES.		
 DATA CEILING OUTLET, FOR BAGGAGE SCREENING, ONE (1) 6-STRAND OM3 OMFP CABLE AND THREE (3) AQUA LC FIBER MODULES.	18" CTR	
 DATA WALL OUTLET, BLUE CATEGORY 6 CABLES AND MODULES.	18" CTR	
 DATA WALL OUTLET, FOR BAGGAGE INFORMATION DISPLAY SYSTEM. TWO (2) BLUE CATEGORY 6 CABLES AND MODULES.	84" CTR	
 DATA WALL OUTLET, FOR FLIGHT INFORMATION DISPLAY SYSTEM. TWO (2) BLUE CATEGORY 6 CABLES AND MODULES.	84" CTR	
 DATA WALL OUTLET, FOR TELEVISION. TWO (2) BLUE CATEGORY 6 CABLES AND MODULES.	72" CTR	
 DATA OUTLET, COUNTER HEIGHT, 6-IN ABOVE BACKSPLASH OR COUNTERTOP. BLUE CATEGORY 6 CABLES AND MODULES.		
 DATA OUTLET, WALL MOUNTED WITH MOUNTING STUDS, FOR WALL PHONE. BLUE CATEGORY 6 CABLE AND BLACK MODULE.	54" CTR	
 DATA FLOOR OUTLET, BLUE CATEGORY 6 CABLES AND MODULES.		
 DATA FLOOR OUTLET, 4-STR OM3 MULTIMODE FIBER CABLE AND BLUE CATEGORY 6 CABLES AND MODULES.		
 DATA FLOOR OUTLET, 4-STR OM3 MULTIMODE FIBER CABLE AND BLUE CATEGORY 6 CABLES AND MODULES.		
 CABLE TELEVISION OUTLET, F-CONNECTOR AND COAXIAL CABLE		

TELECOMMUNICATIONS ABBREVIATIONS

A, AMP	– AMPERE	KVAR	– KILOVOLT AMPERES REACTIVE
AC	– ALTERNATING CURRENT	KW	– KILOWATTS
A/C	– AIR CONDITIONING	KWH	– KILOWATT HOUR
AFF	– ABOVE FINISHED FLOOR	LA	– LIGHTNING ARRESTOR
AFG	– ABOVE FINAL GRADE	LC	– LIGHTING CONTACTOR
AHU	– AIR HANDLING UNIT	LG	– LIGHTING
AIC	– AMPS INTERRUPTING CAPACITY	LTNG	– LIGHTNING
ALT	– ALTERNATE	LP	– LIGHTING PANEL
ANN	– ANNUNCIATOR	LRA	– LOCKED ROTOR AMPERES
APPROX	– APPROXIMATELY	MATV	– MAIN CIRCUIT BREAKER
ARCH	– ARCHITECT	MCB	– MOTOR CONTROL CENTER
ATC	– AUTOMATIC TEMPERATURE CONTROL	MCC	– METAL HALIDE
ATS	– AUTOMATIC TRANSFER SWITCH	MEH	– MANHOLE, MOUNTING HEIGHT
AWG	– AMERICAN WIRE GAUGE	MH	– MAIN LUGS ONLY
BAS	– BUILDING AUTOMATION SYSTEM	MLO	– MOTOR STARTER PANEL
BFC	– BELOW FINISHED CEILING	MTD	– MOUNTED
BFG	– BELOW FINISHED GRADE	MV	– MERCURY VAPOR
BLDG	– BUILDING	NC	– NORMALLY CLOSED
BOD	– BOTTOM OF DEVICE	NEC	– NATIONAL ELECTRICAL CODE
C, CND	– CONDUIT	NFSS	– NON-FUSED SAFETY SWITCH
CATV	– CABLE TELEVISION	NO	– NUMBER, NORMALLY OPEN
CB	– CIRCUIT BREAKER	OC	– ON CENTER
CCTV	– CLOSED CIRCUIT TELEVISION	OFCI	– OWNER FURNISHED CONTRACTOR INSTALLED
CKT	– CIRCUIT	OFOI	– OWNER FURNISHED OWNER INSTALLED
CL	– CURRENT LIMITING	OH	– OVERHEAD
CLG	– CEILING	Ø, PH	– PHASE
CONN	– CONNECT	P	– POLE
CPT	– CONTROL POWER TRANSFORMER	PB	– PUSHBUTTON
CT	– CURRENT TRANSFORMER	PF	– POWER FACTOR
CTR	– CENTER	PFCC	– POWER FACTOR CORRECTION CAPACITOR
CU,CO	– COPPER	PL	– PILOT LIGHT
CX	– CONNECT TO EXISTING	PLC	– PROGRAMMABLE LIGHTING CONTROL
DC	– DIRECT CURRENT	PNL	– PANEL
DISC	– DISCONNECT	PP	– POWER PANEL
DN	– DOWN	PR	– PAIR
DP	– DISTRIBUTION PANEL	PT	– POTENTIAL TRANSFORMER
DPST	– DOUBLE POLE SINGLE THROW	PVC	– POLYVINYL CHLORIDE
DPDT	– DOUBLE POLE DOUBLE THROW	Pp	– PUMP
DT	– DOUBLE THROW	QTY	– QUANTITY
DWG	– DRAWING	RCS	– REMOTE CONTROL SWITCH
E, EMERG	– EMERGENCY	REC, RECP	– RECEPTACLE
EA	– EACH	REQ'D	– REQUIRED
EC	– EMPTY CONDUIT	RFI	– RADIO FREQUENCY INTERFERENCE
EF	– EXHAUST FAN	RGS	– RIGID GALVANIZED STEEL
EH	– ELECTRIC HEATER	RLA	– RUNNING LOAD AMPERES
ELEC	– ELECTRIC	RM	– ROOM
ELEV	– ELEVATION	RVAT	– REDUCED VOLTAGE AUTO TRANSFORMER
ETR	– EXISTING TO REMAIN	RX	– REMOVE EXISTING
EX	– EXISTING	SC	– SURGE CAPACITOR
EXP	– EXPOSED	SEC	– SECONDARY
EW	– ELECTRIC WATER COOLER	SN, S/N	– SOLID NEUTRAL
FR	– FRAME	SP	– SURGE PROTECTION
FA	– FIRE ALARM	SPDT	– SINGLE POLE DOUBLE THROW
FAAP	– FIRE ALARM ANNUNCIATOR PANEL	SS	– SAFETY SWITCH
FACP	– FIRE ALARM CONTROL PANEL	SST	– SOLID STATE
FBO	– FURNISHED BY OTHERS	ST	– SINGLE THROW
FC	– FAN COIL	SW	– SWITCH
FDR	– FEEDER	SWBD	– SWITCHBOARD
FLA	– FULL LOAD AMPERES	TBR	– TO BE REMOVED
FLR	– FLOOR	TC	– TIME CLOCK
FJ	– FUSED AND FUSIBLE	TEL, TELE	– TELEPHONE
FUSS	– FUSED SAFETY SWITCH	TOD	– TOP OF DEVICE
FVR	– FULL VOLTAGE REVERSING	TRANS/XMR	– TRANSFORMER
FVNR	– FULL VOLTAGE NON-REVERSING	TH	– TUNGSTEN HALOGEN
GEN	– GENERATOR, GENERAL	TTB	– TELEPHONE TERMINAL BOARD
GFI	– GROUND FAULT INTERRUPTER	TW	– TWISTED
GFR	– GROUND FAULT RELAY	TYP	– TYPICAL
GRD	– GROUND	UO	– UNDERGROUND
GRS	– GALVANIZED RIGID STEEL	UH	– UNIT HEATER
HID	– HIGH INTENSITY DISCHARGE	UON	– UNLESS OTHERWISE NOTED
HGA	– HAND-OFF-AUTOMATIC	V	– VOLTS
HP	– HORSEPOWER	VFC	– VARIABLE FREQUENCY CONTROLLER
HPS	– HIGH PRESSURE SODIUM	W	– WATTS, WIRE
HTR	– HEATER	W/	– WITH
HV	– HIGH VOLTAGE	WP	– WEATHER-PROOF
HZ	– HERTZ	XP	– EXPLOSION PROOF
IG	– ISOLATED GROUND	2S1W	– 2 SPEED SINGLE WINDING
JB	– JUNCTION BOX	2S2W	– 2 SPEED DOUBLE WINDING
KCMIL	– THOUSAND CIRCULAR MILS		
KV	– KILOVOLTS		
KVA	– KILOVOLT AMPERES		

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


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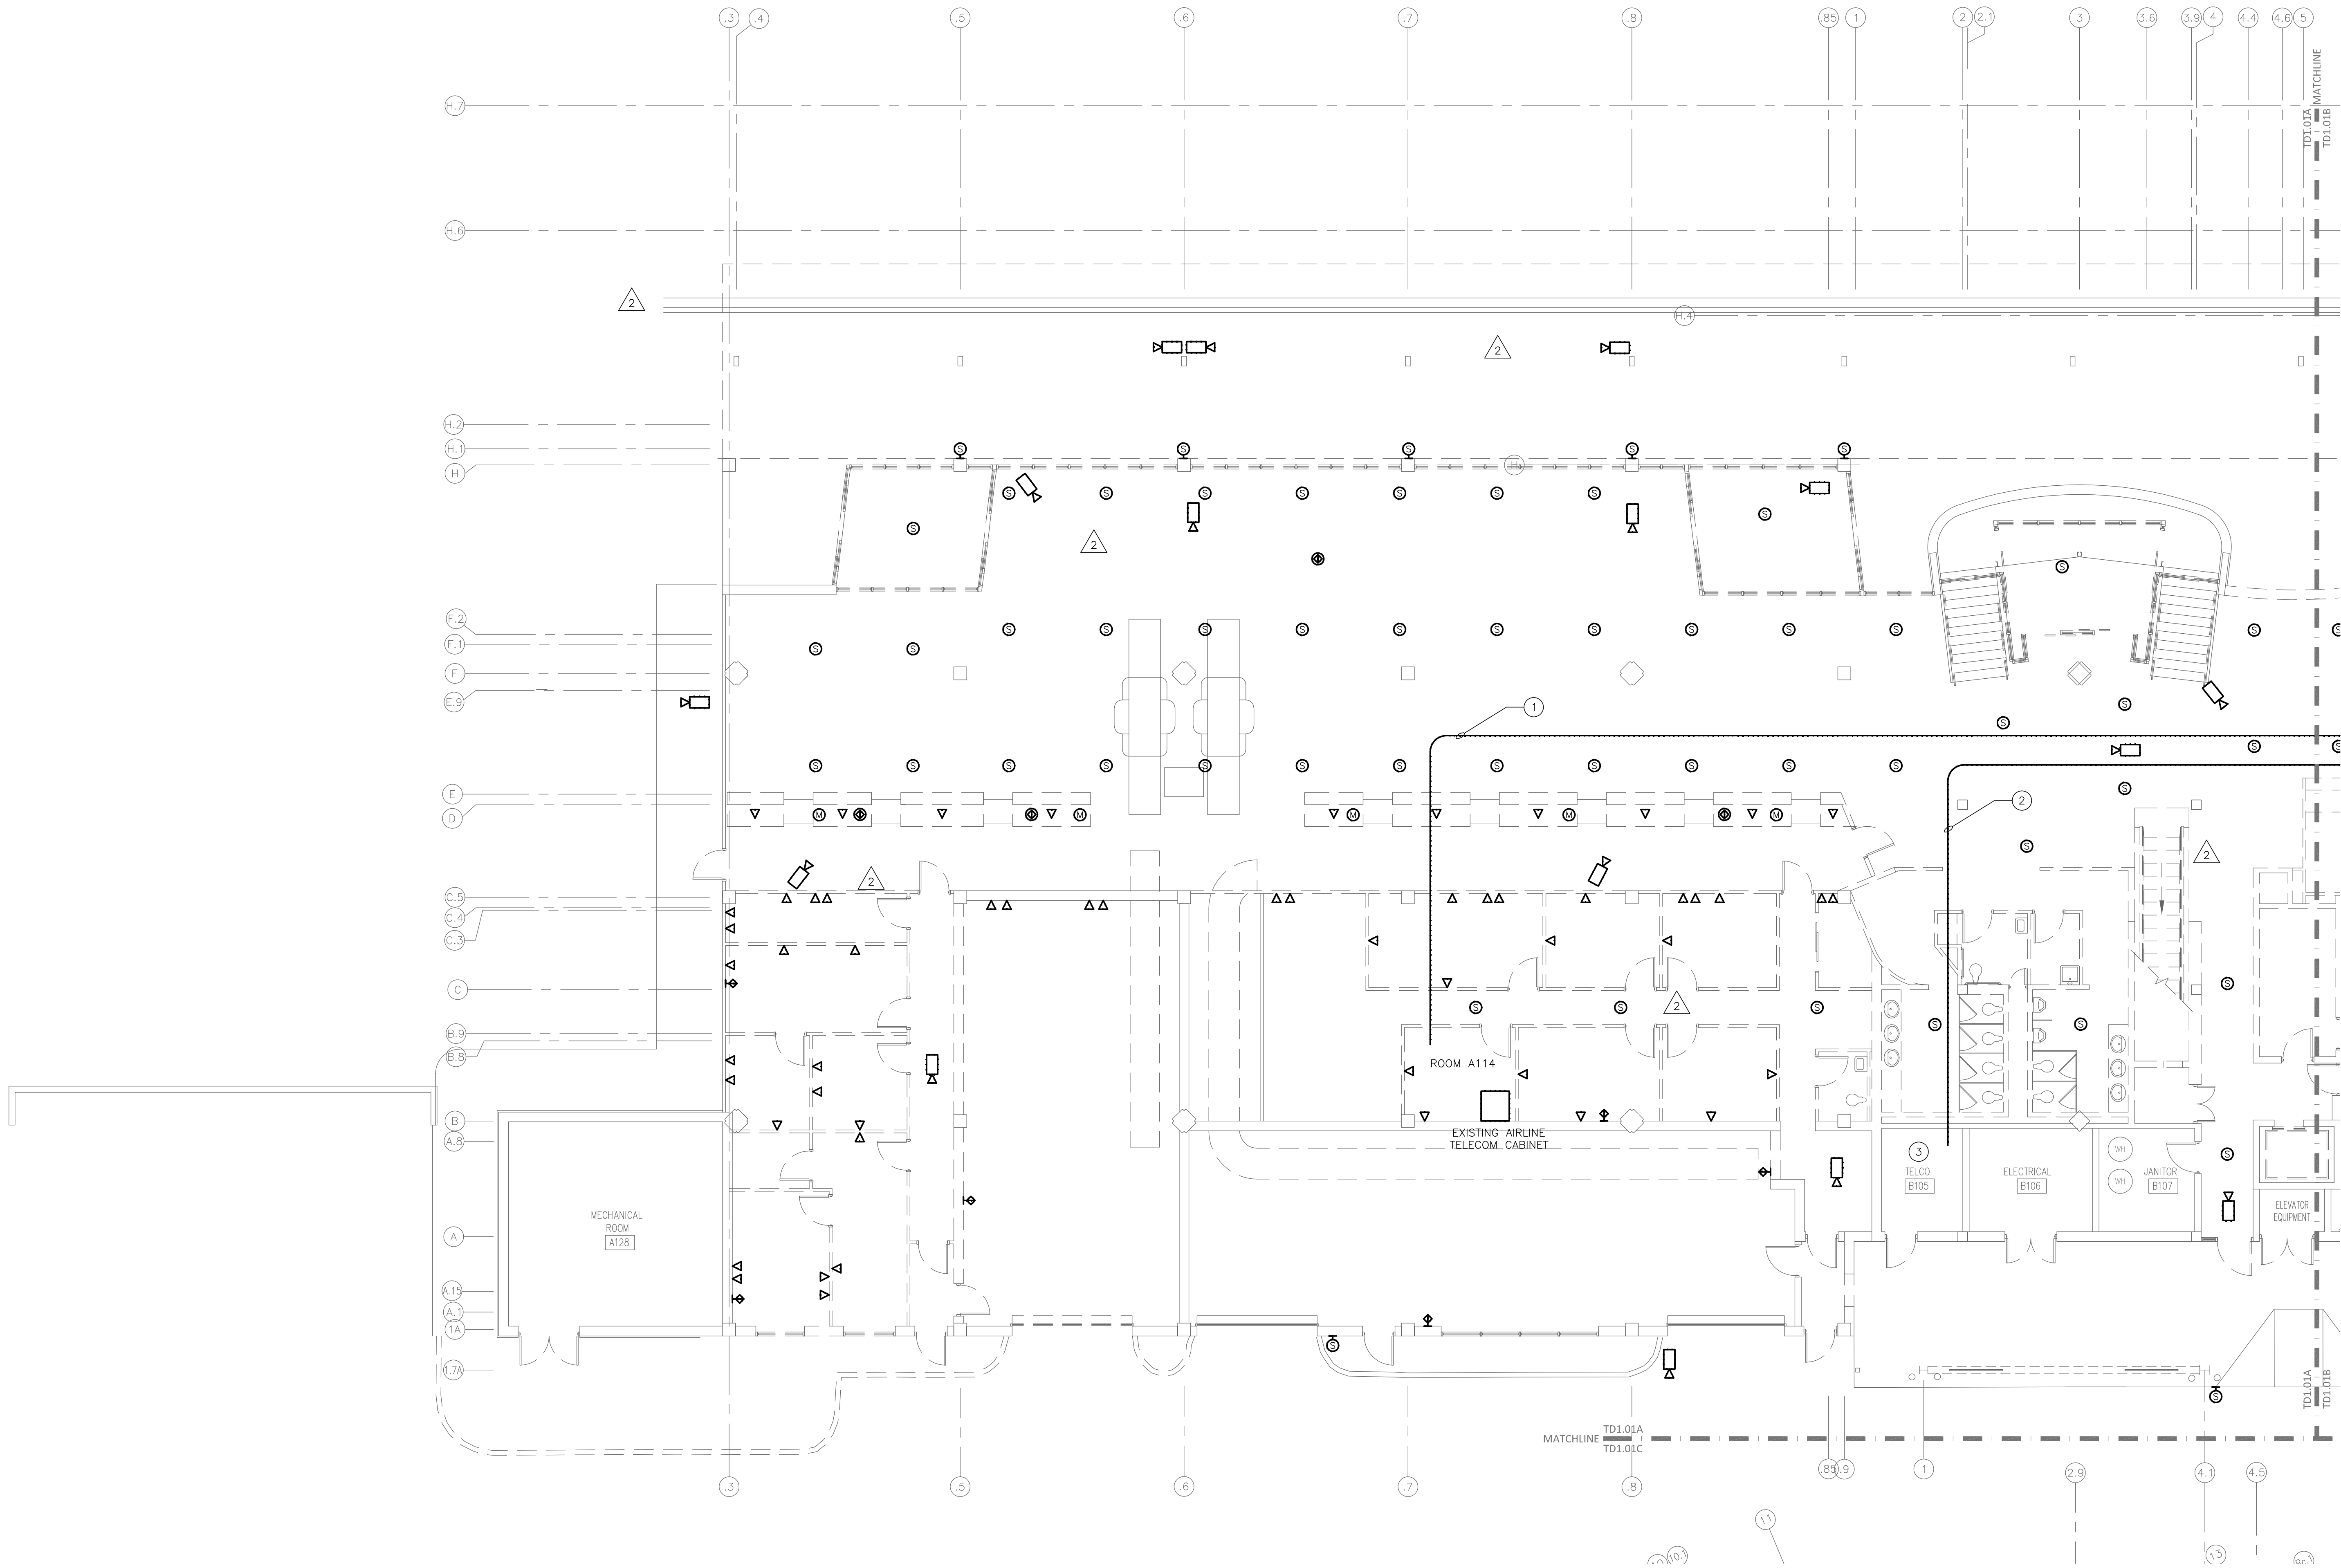
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DRAWN BY: MT
REVIEWED BY: MT
DATE: 07-19-19
PROJECT NO.: 1808

REVISIONS	
	08E-09 10/02/20
	08E-11 11/30/20
	08E-17 04/16/21

SHEET NUMBER
T0.01




FIRST FLOOR PLAN – AREA A – TELECOMMUNICATIONS DEMOLITION
SCALE: 1/8" = 1'-0"

GENERAL DEMOLITION NOTES

- A. NOTIFY THE OWNER, IN WRITING, AT LEAST SEVEN (7) DAYS IN ADVANCE OF ALL REQUIRED SHUTDOWNS OF ELECTRICAL SERVICE, OR OTHER UTILITIES. UPON WRITTEN RECEIPT OF APPROVAL FROM OWNER, SHUTDOWNS SHALL BE PERFORMED DURING HOURS AS DIRECTED BY THE OWNER AND SHALL BE ACCOMPLISHED AT NO ADDITIONAL CONTRACT COST. AT THE END OF EACH SHUT DOWN ALL SERVICES SHALL BE RESTORED.
- B. WHEN WORKING IN AND AROUND THE EXISTING BUILDING, EXTREME CARE SHALL BE EXERCISED WITH REGARD TO PROTECTION OF THE EXISTING STRUCTURE AND MECHANICAL AND ELECTRICAL SERVICES WHICH WILL REMAIN. REPAIR, REPLACE, OR RESTORE TO THE SATISFACTION OF THE OWNER ALL EXISTING WORK DAMAGED IN THE PERFORMANCE OF DEMOLITION AND/OR NEW WORK.
- C. ALL EXISTING WIRING, EQUIPMENT, CONDUITS, AND MATERIALS NOT REQUIRED FOR RE-USE OR RE-INSTALLATION (SHOWN OR OTHERWISE) SHALL BE REMOVED. ALL EXISTING MATERIALS AND EQUIPMENT WHICH ARE REMOVED AND ARE DESIRED BY THE OWNER, OR ARE INDICATED TO REMAIN THE PROPERTY OF THE OWNER, SHALL BE DELIVERED TO HIM ON THE PREMISES BY THE CONTRACTOR WHERE DIRECTED BY THE ENGINEER. ALL OTHER MATERIALS AND EQUIPMENT WHICH ARE REMOVED SHALL BECOME THE PROPERTY OF THE CONTRACTOR AND SHALL BE REMOVED BY THE CONTRACTOR FROM THE PREMISES.
- D. EXISTING CONDITIONS, I.E., PRESENCE AND LOCATION OF PANELBOARDS, LIGHTING FIXTURES, RECEPTACLES, EQUIPMENT, AND MATERIALS, INDICATED ARE BASED ON INFORMATION OBTAINED FROM AVAILABLE RECORD DRAWINGS AND FIELD SURVEYS AND ARE NOT WARRANTED TO BE COMPLETE OR CORRECT. CONTRACTOR SHALL FIELD VERIFY EXACT LOCATION OF ALL CONDUITS, EQUIPMENT, AND MATERIALS IN THE FIELD PRIOR TO STARTING ALL WORK.
- E. EXISTING EQUIPMENT SIZES NOTED ARE FOR THE CONVENIENCE OF THE CONTRACTOR ONLY AND ARE NOT WARRANTED TO BE CORRECT. CONTRACTOR SHALL VERIFY ALL SIZES IN THE FIELD IF THEY EFFECT HIS WORK.
- F. WHEN EXISTING MECHANICAL AND ELECTRICAL WORK IS REMOVED, ALL CONDUITS, WIRING AND MATERIALS SHALL BE REMOVED TO A POINT BELOW THE FINISHED FLOORS OR BEHIND FINISHED WALLS AND CAPPED. SUCH POINTS SHALL BE FAR ENOUGH BEHIND FINISHED SURFACES TO ALLOW FOR THE INSTALLATION OF THE NORMAL THICKNESS OF FINISHED MATERIAL.
- G. EXISTING WIRING & CONDUIT NO LONGER REQUIRED TO REMAIN IN SERVICE (SHOWN OR OTHERWISE) SHALL BE DISCONNECTED AND REMOVED BACK TO PANELBOARD UNLESS OTHERWISE INDICATED OR NOTED ON THE PLANS. REMOVE EXISTING PIPE HANGERS, SUPPORTS, CONDUIT, ETC. UNDERGROUND CONDUIT TO BE REMOVED SHALL BE LIMITED TO PIPING IN THE AREAS OCCUPIED BY THE NEW CONSTRUCTION AND FIVE FEET (5') BEYOND THE NEW CONSTRUCTION. EXISTING CONDUIT INDICATED OR REQUIRED TO REMAIN IN SERVICE OR IN PLACE SHALL BE CAPPED, PLUGGED, OTHERWISE SEALED. NO EXISTING CONDUIT SHALL BE LEFT OPEN END.
- H. EXISTING MECHANICAL AND ELECTRICAL EQUIPMENT, CONDUIT, WIRING, DEVICES, AND MATERIALS AFFECTED BY DEMOLITION OR NEW WORK INSTALLATION AND REQUIRED TO REMAIN IN SERVICE SHALL BE REINSTALLED OR SUPPORTED AS REQUIRED IN ACCORDANCE WITH NEW WORK SPECIFICATION. ALL WORK SHALL BE COMPLETED TO THE SATISFACTION OF THE ENGINEER AND AT NO ADDITIONAL CONTRACT COST.
- I. PATCH TO MATCH EXISTING ALL NEW AND EXISTING OPENINGS AND WALLS, CEILINGS, ROOF, AND FLOOR SURFACES DAMAGED OR CREATED BY DEMOLITION WORK. PATCHING WHERE POSSIBLE SHALL MATCH EXISTING ADJACENT SURFACES AS TO THICKNESS, TEXTURES, MATERIALS, AND COLOR. ALL PATCHING SHALL BE PERFORMED TO THE SATISFACTION OF THE ARCHITECT AND AT NO ADDITIONAL CONTRACT COST.
- J. IN GENERAL ALL EQUIPMENT AND MATERIALS SHOWN "LIGHT" IS EXISTING TO REMAIN. ALL EQUIPMENT AND MATERIALS SHOWN "HEAVY AND HATCHED" IS EXISTING AND SHALL BE DEMOLISHED.

DRAWING NOTES:

- 1 DEMO CABLE AND PATHWAY AFTER AIRLINE TELECOMMUNICATIONS EQUIPMENT HAS BEEN RELOCATED TO NEW TELECOM ROOM B129.
- 2 DEMO CABLE AND PATHWAY AFTER SERVICES HAVE BEEN CUT OVER TO NEW SERVICES IN TELECOM ROOM B130.
- 3 REMOVE ALL EQUIPMENT, CABLING, PATHWAY, AND BACKBOARD AFTER ALL SERVICES HAVE BEEN CUT OVER TO TELECOM ROOM B130. REPURPOSE ROOM AS STORAGE.

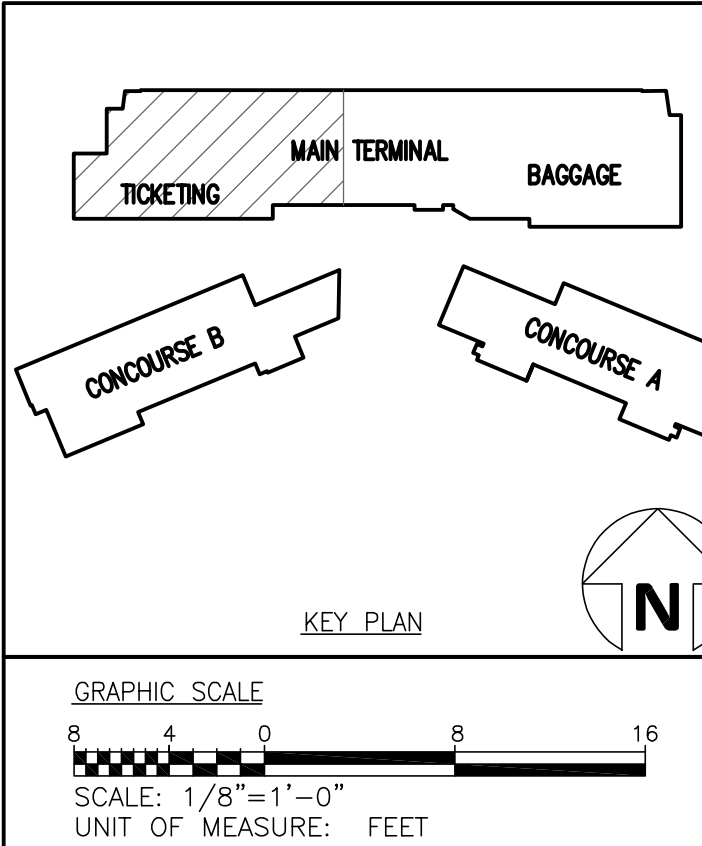

DRAWN BY: JMT
REVIEWED BY: JMT
DATE: 07-18-19
PROJECT NO.: 1808

REVISIONS	
1	MODIFIED 2 08/09/19
2	CSE-6 07/31/20

SHEET NUMBER

TD1.01A

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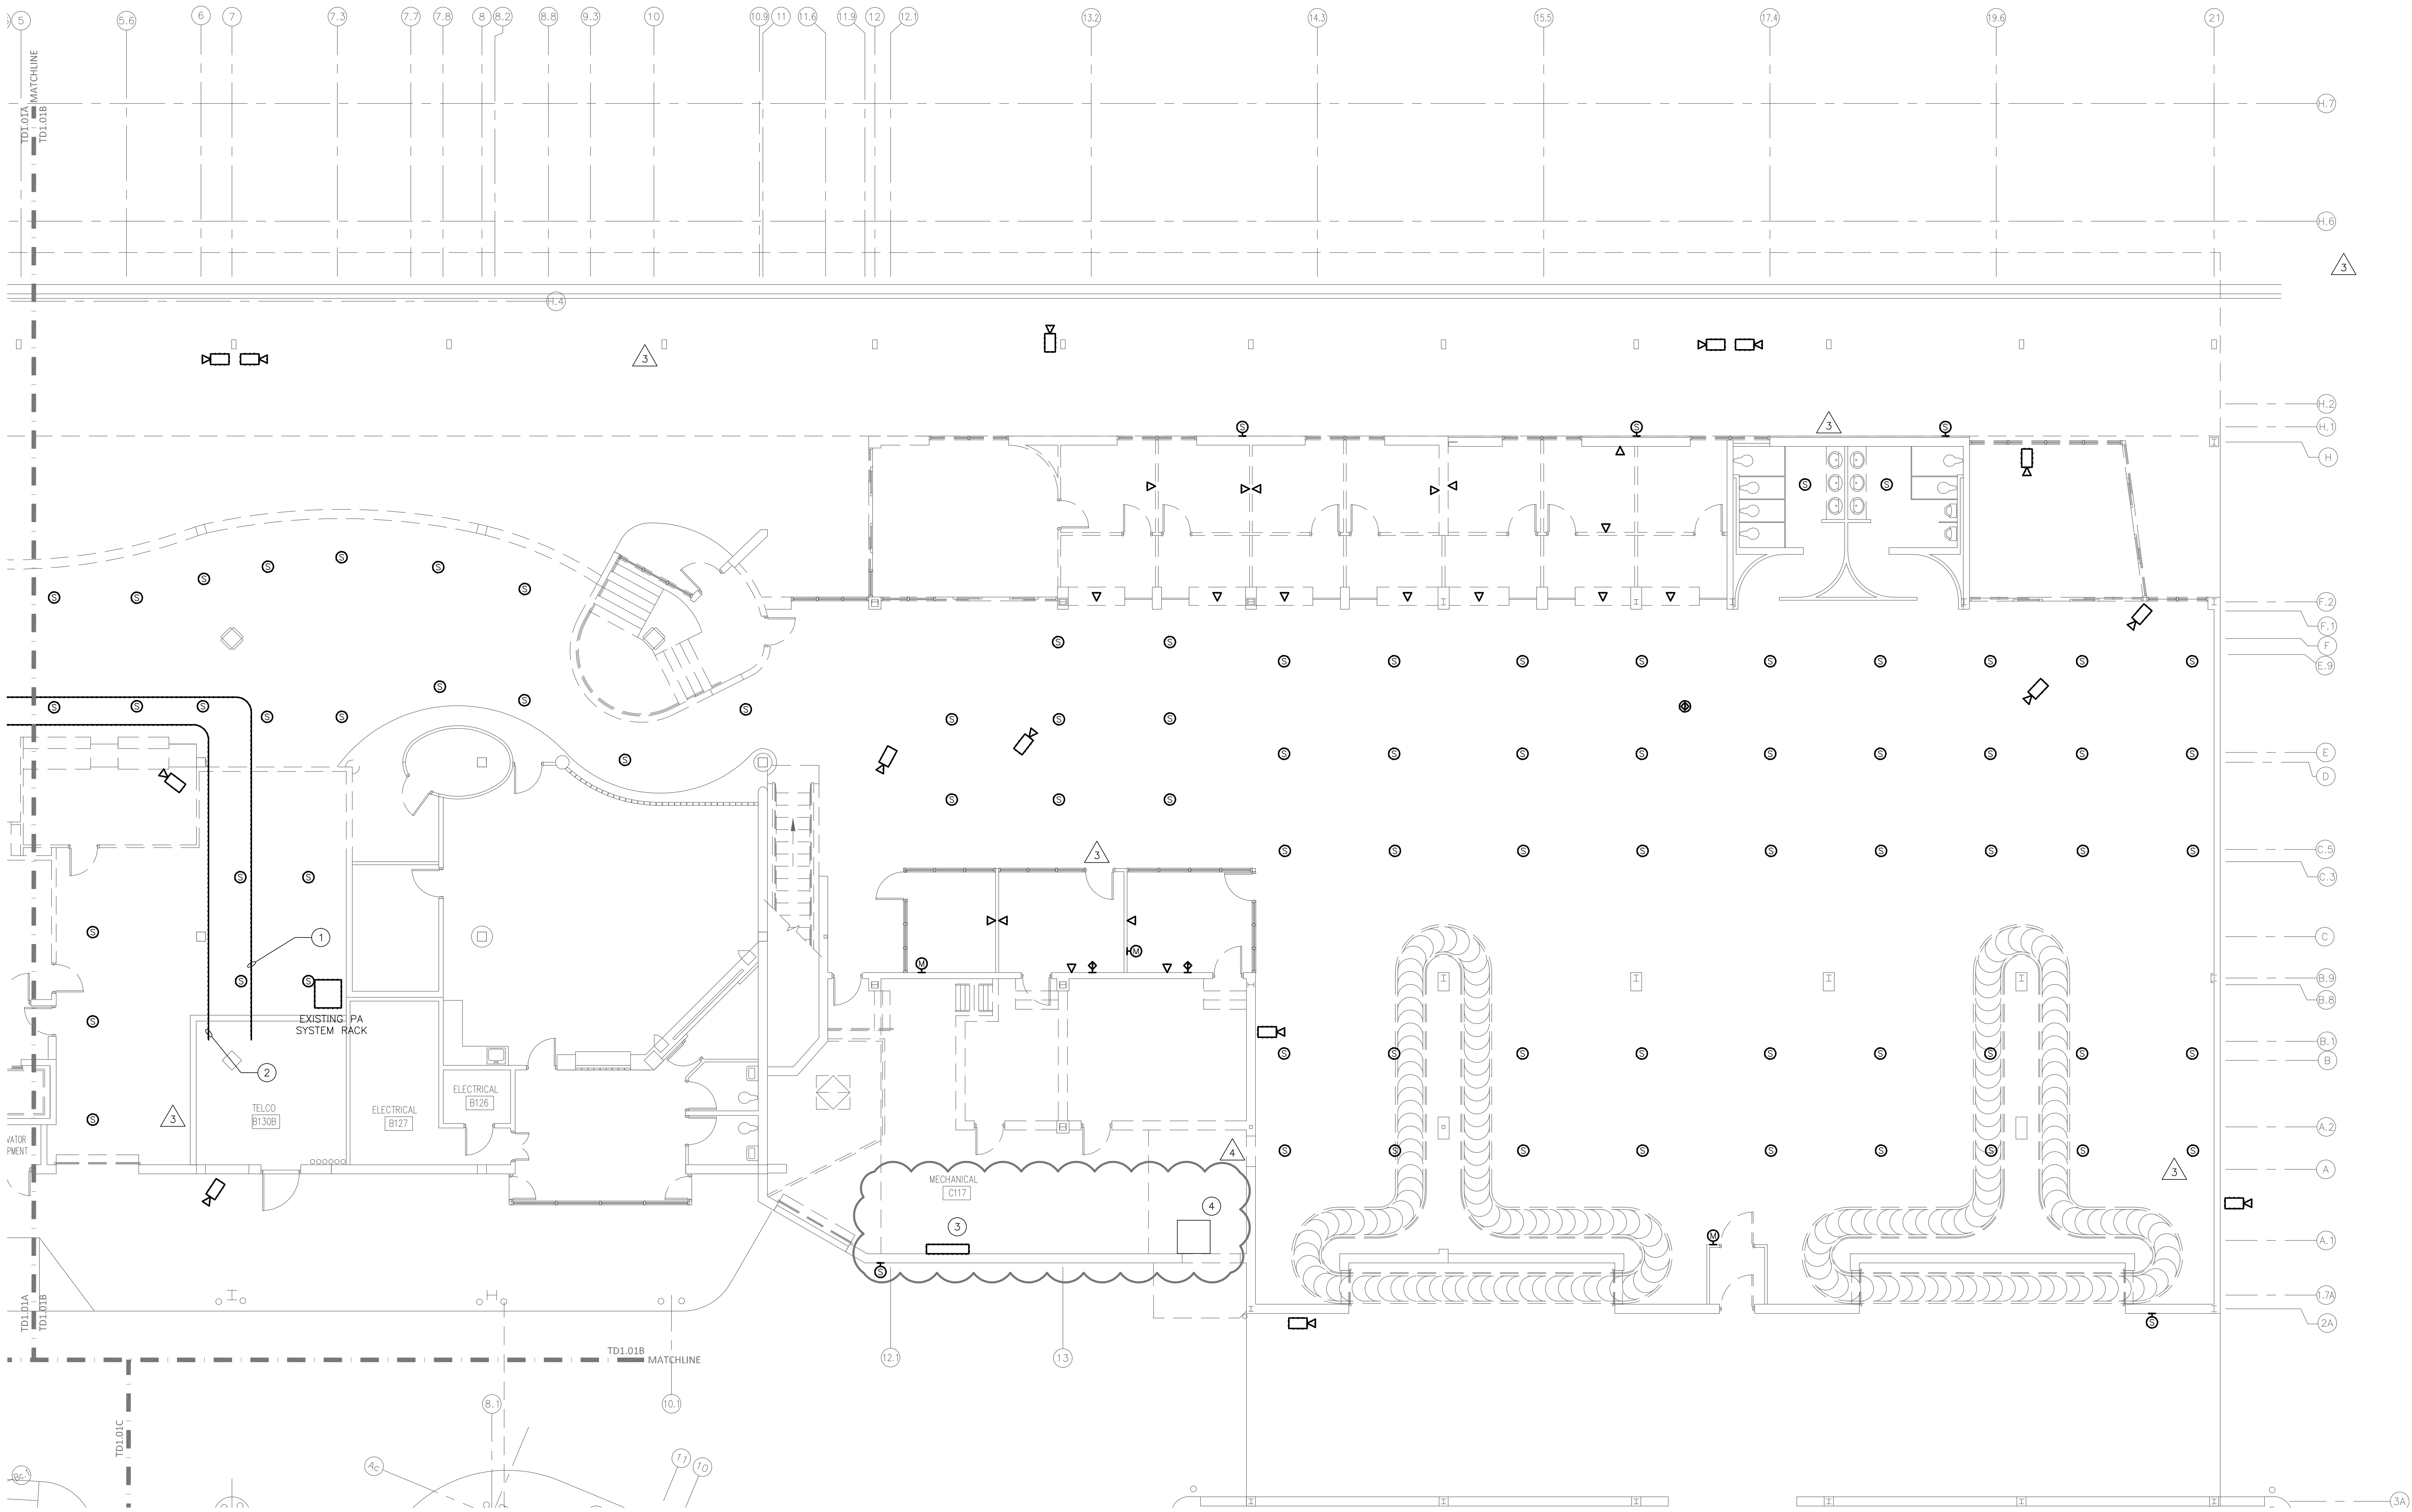
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RMF Project No: 2153223.F0

Fayetteville Regional Airport – Airline Terminal Improvements Part 2
FIRST FLOOR PLAN – AREA A – TELECOMMUNICATIONS
DEMOLITION

400 Airport Road
Fayetteville, North Carolina 28306





FIRST FLOOR PLAN – AREA B – TELECOMMUNICATIONS DEMOLITION
SCALE: 1/8" = 1'-0"

GENERAL DEMOLITION NOTES

- A. NOTIFY THE OWNER, IN WRITING, AT LEAST SEVEN (7) DAYS IN ADVANCE OF ALL REQUIRED SHUTDOWNS OF ELECTRICAL SERVICE, OR OTHER UTILITIES. UPON WRITTEN RECEIPT OF APPROVAL FROM OWNER, SHUTDOWNS SHALL BE PERFORMED DURING HOURS AS DIRECTED BY THE OWNER AND SHALL BE ACCOMPLISHED AT NO ADDITIONAL CONTRACT COST. AT THE END OF EACH SHUT DOWN ALL SERVICES SHALL BE RESTORED.
- B. WHEN WORKING IN AND AROUND THE EXISTING BUILDING, EXTREME CARE SHALL BE EXERCISED WITH REGARD TO PROTECTION OF THE EXISTING STRUCTURE AND MECHANICAL AND ELECTRICAL SERVICES WHICH WILL REMAIN. REPAIR, REPLACE, OR RESTORE TO THE SATISFACTION OF THE OWNER ALL EXISTING WORK DAMAGED IN THE PERFORMANCE OF DEMOLITION AND/OR NEW WORK.
- C. ALL EXISTING WIRING, EQUIPMENT, CONDUITS, AND MATERIALS NOT REQUIRED FOR RE-USE OR RE-INSTALLATION (SHOWN OR OTHERWISE) SHALL BE REMOVED. ALL EXISTING MATERIALS AND EQUIPMENT WHICH ARE REMOVED AND ARE DESIRED BY THE OWNER, OR ARE INDICATED TO REMAIN THE PROPERTY OF THE OWNER, SHALL BE DELIVERED TO HIM ON THE PREMISES BY THE CONTRACTOR WHERE DIRECTED BY THE ENGINEER. ALL OTHER MATERIALS AND EQUIPMENT WHICH ARE REMOVED SHALL BECOME THE PROPERTY OF THE CONTRACTOR AND SHALL BE REMOVED BY THE CONTRACTOR FROM THE PREMISES.
- D. EXISTING CONDITIONS, I.E., PRESENCE AND LOCATION OF PANELBOARDS, LIGHTING FIXTURES, RECEPTACLES, EQUIPMENT, AND MATERIALS, INDICATED ARE BASED ON INFORMATION OBTAINED FROM AVAILABLE RECORD DRAWINGS AND FIELD SURVEYS AND ARE NOT WARRANTED TO BE COMPLETE OR CORRECT. CONTRACTOR SHALL FIELD VERIFY EXACT LOCATION OF ALL CONDUITS, EQUIPMENT, AND MATERIALS IN THE FIELD PRIOR TO STARTING ALL WORK.
- E. EXISTING EQUIPMENT SIZES NOTED ARE FOR THE CONVENIENCE OF THE CONTRACTOR ONLY AND ARE NOT WARRANTED TO BE CORRECT. CONTRACTOR SHALL VERIFY ALL SIZES IN THE FIELD IF THEY EFFECT HIS WORK.
- F. WHEN EXISTING MECHANICAL AND ELECTRICAL WORK IS REMOVED, ALL CONDUITS, WIRING AND MATERIALS SHALL BE REMOVED TO A POINT BELOW THE FINISHED FLOORS OR BEHIND FINISHED WALLS AND CAPPED. SUCH POINTS SHALL BE FAR ENOUGH BEHIND FINISHED SURFACES TO ALLOW FOR THE INSTALLATION OF THE NORMAL THICKNESS OF FINISHED MATERIAL.
- G. EXISTING WIRING & CONDUIT NO LONGER REQUIRED TO REMAIN IN SERVICE (SHOWN OR OTHERWISE) SHALL BE DISCONNECTED AND REMOVED BACK TO PANELBOARD UNLESS OTHERWISE INDICATED OR NOTED ON THE PLANS. REMOVE EXISTING PIPE HANGERS, SUPPORTS, CONDUIT, ETC. UNDERGROUND CONDUIT TO BE REMOVED SHALL BE LIMITED TO PIPING IN THE AREAS OCCUPIED BY THE NEW CONSTRUCTION AND FIVE FEET (5') BEYOND THE NEW CONSTRUCTION. EXISTING CONDUIT INDICATED OR REQUIRED TO REMAIN IN SERVICE OR IN PLACE SHALL BE CAPPED, PLUGGED, OTHERWISE SEALED. NO EXISTING CONDUIT SHALL BE LEFT OPEN END.
- H. EXISTING MECHANICAL AND ELECTRICAL EQUIPMENT, CONDUIT, WIRING, DEVICES, AND MATERIALS AFFECTED BY DEMOLITION OR NEW WORK INSTALLATION AND REQUIRED TO REMAIN IN SERVICE SHALL BE REINSTALLED OR SUPPORTED AS REQUIRED IN ACCORDANCE WITH NEW WORK SPECIFICATION. ALL WORK SHALL BE COMPLETED TO THE SATISFACTION OF THE ENGINEER AND AT NO ADDITIONAL CONTRACT COST.
- I. PATCH TO MATCH EXISTING ALL NEW AND EXISTING OPENINGS AND WALLS, CEILINGS, ROOF, AND FLOOR SURFACES DAMAGED OR CREATED BY DEMOLITION WORK. PATCHING WHERE POSSIBLE SHALL MATCH EXISTING ADJACENT SURFACES AS TO THICKNESS, TEXTURES, MATERIALS, AND COLOR. ALL PATCHING SHALL BE PERFORMED TO THE SATISFACTION OF THE ARCHITECT AND AT NO ADDITIONAL CONTRACT COST.
- J. IN GENERAL ALL EQUIPMENT AND MATERIALS SHOWN "LIGHT" IS EXISTING TO REMAIN. ALL EQUIPMENT AND MATERIALS SHOWN "HEAVY AND HATCHED" IS EXISTING AND SHALL BE DEMOLISHED.

DRAWING NOTES:

- 1 DEMO CABLE AND PATHWAY AFTER AIRLINE TELECOMMUNICATIONS EQUIPMENT HAS BEEN RELOCATED TO NEW TELECOM ROOM B129.
- 2 DEMO CABLE AND PATHWAY AFTER SERVICES HAVE BEEN CUT OVER TO NEW SERVICES IN TELECOM ROOM B130.
- 3 REMOVE CABLES AND HARDWARE, RELOCATE HARDWARE AND CABLES TO TELECOM ROOM B130. TERMINATE AND TEST CABLES. SEE SHEET TN1.01B FOR NEW LOCATION.
- 4 EXISTING FAA ANTENNA RECEIVER, RELOCATE UNDER NEW WORK. SEE SHEET TN1.02D FOR NEW LOCATION.

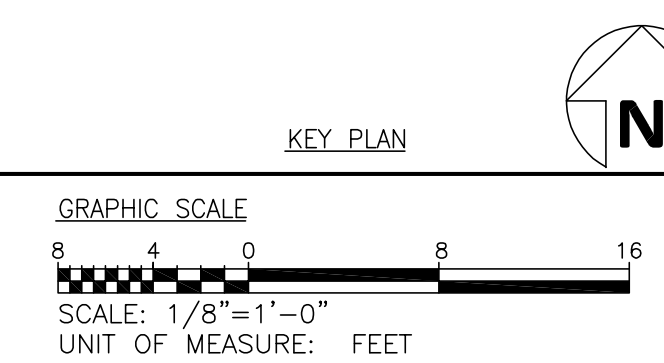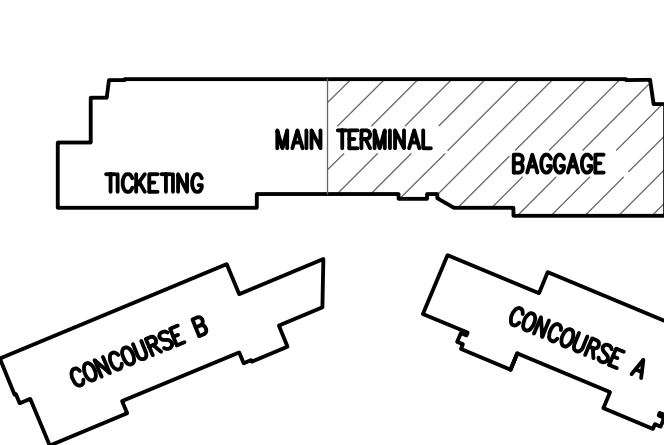

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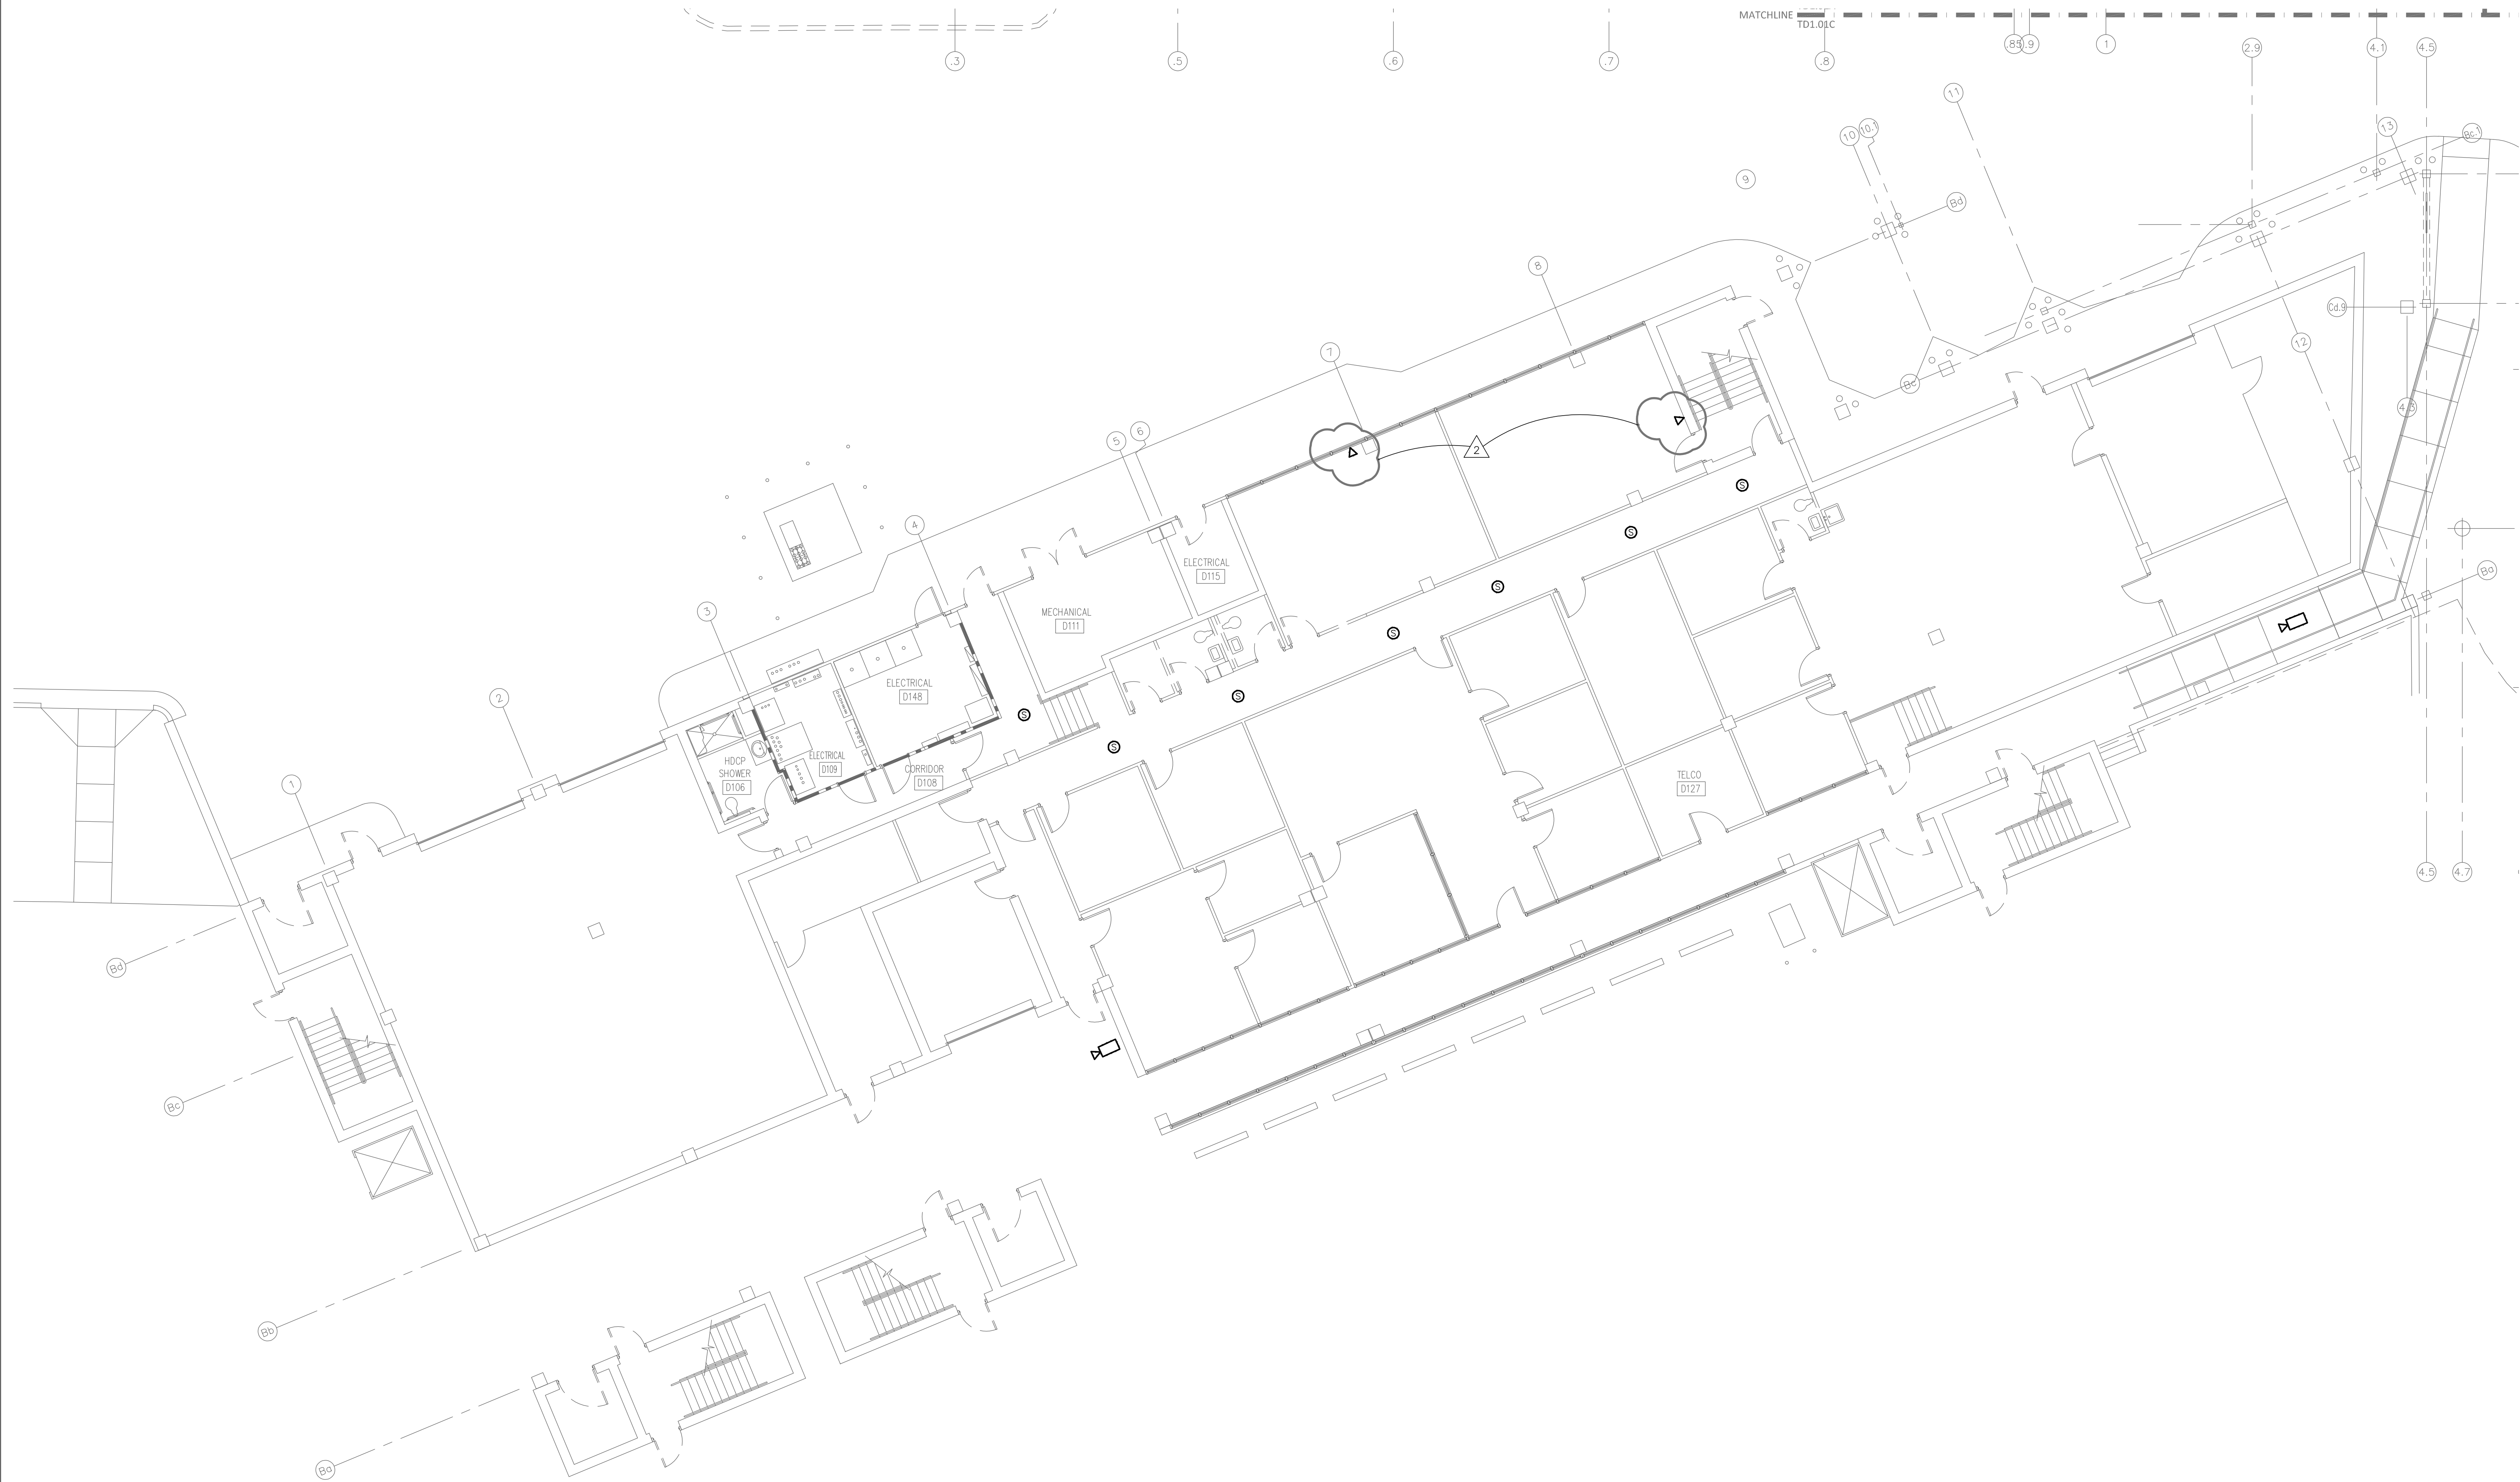
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RMF Project No: 2153223.F0

Fayetteville Regional Airport – Airline Terminal Improvements Part 2
FIRST FLOOR PLAN – AREA B – TELECOMMUNICATIONS
DEMOLITION
400 Airport Road
Fayetteville, North Carolina 28306

DRAWN BY: JMT
REVIEWED BY: JMT
DATE: 07-18-19
PROJECT NO.: 1808

REVISIONS		
A	PRE-6	07/31/20
A	PRE-7	08/10/20


SHEET NUMBER
TD1.01B




FIRST FLOOR PLAN — AREA C — TELECOMMUNICATIONS DEMOLITION
SCALE: 1/8" = 1'-0"

GENERAL DEMOLITION NOTES

- A. NOTIFY THE OWNER, IN WRITING, AT LEAST SEVEN (7) DAYS IN ADVANCE OF ALL REQUIRED SHUTDOWNS OF ELECTRICAL SERVICE, OR OTHER UTILITIES. UPON WRITTEN RECEIPT OF APPROVAL FROM OWNER, SHUTDOWNS SHALL BE PERFORMED DURING HOURS AS DIRECTED BY THE OWNER AND SHALL BE ACCOMPLISHED AT NO ADDITIONAL CONTRACT COST. AT THE END OF EACH SHUT DOWN ALL SERVICES SHALL BE RESTORED.
- B. WHEN WORKING IN AND AROUND THE EXISTING BUILDING, EXTREME CARE SHALL BE EXERCISED WITH REGARD TO PROTECTION OF THE EXISTING STRUCTURE AND MECHANICAL AND ELECTRICAL SERVICES WHICH WILL REMAIN. REPAIR, REPLACE, OR RESTORE TO THE SATISFACTION OF THE OWNER ALL EXISTING WORK DAMAGED IN THE PERFORMANCE OF DEMOLITION AND/OR NEW WORK.
- C. ALL EXISTING WIRING, EQUIPMENT, CONDUITS, AND MATERIALS NOT REQUIRED FOR RE-USE OR RE-INSTALLATION (SHOWN OR OTHERWISE) SHALL BE REMOVED. ALL EXISTING MATERIALS AND EQUIPMENT WHICH ARE REMOVED AND ARE DESIRED BY THE OWNER, OR ARE INDICATED TO REMAIN THE PROPERTY OF THE OWNER, SHALL BE DELIVERED TO HIM ON THE PREMISES BY THE CONTRACTOR WHERE DIRECTED BY THE ENGINEER. ALL OTHER MATERIALS AND EQUIPMENT WHICH ARE REMOVED SHALL BECOME THE PROPERTY OF THE CONTRACTOR AND SHALL BE REMOVED BY THE CONTRACTOR FROM THE PREMISES.
- D. EXISTING CONDITIONS, I.E., PRESENCE AND LOCATION OF PANELBOARDS, LIGHTING FIXTURES, RECEPTACLES, EQUIPMENT, AND MATERIALS, INDICATED ARE BASED ON INFORMATION OBTAINED FROM AVAILABLE RECORD DRAWINGS AND FIELD SURVEYS AND ARE NOT WARRANTED TO BE COMPLETE OR CORRECT. CONTRACTOR SHALL FIELD VERIFY EXACT LOCATION OF ALL CONDUITS, EQUIPMENT, AND MATERIALS IN THE FIELD PRIOR TO STARTING ALL WORK.
- E. EXISTING EQUIPMENT SIZES NOTED ARE FOR THE CONVENIENCE OF THE CONTRACTOR ONLY AND ARE NOT WARRANTED TO BE CORRECT. CONTRACTOR SHALL VERIFY ALL SIZES IN THE FIELD IF THEY EFFECT HIS WORK.
- F. WHEN EXISTING MECHANICAL AND ELECTRICAL WORK IS REMOVED, ALL CONDUITS, WIRING AND MATERIALS SHALL BE REMOVED TO A POINT BELOW THE FINISHED FLOORS OR BEHIND FINISHED WALLS AND CAPPED. SUCH POINTS SHALL BE FAR ENOUGH BEHIND FINISHED SURFACES TO ALLOW FOR THE INSTALLATION OF THE NORMAL THICKNESS OF FINISHED MATERIAL.
- G. EXISTING WIRING & CONDUIT NO LONGER REQUIRED TO REMAIN IN SERVICE (SHOWN OR OTHERWISE) SHALL BE DISCONNECTED AND REMOVED BACK TO PANELBOARD UNLESS OTHERWISE INDICATED OR NOTED ON THE PLANS. REMOVE EXISTING PIPE HANGERS, SUPPORTS, CONDUIT, ETC. UNDERGROUND CONDUIT TO BE REMOVED SHALL BE LIMITED TO PIPING IN THE AREAS OCCUPIED BY THE NEW CONSTRUCTION AND FIVE FEET (5') BEYOND THE NEW CONSTRUCTION. EXISTING CONDUIT INDICATED OR REQUIRED TO REMAIN IN SERVICE OR IN PLACE SHALL BE CAPPED, PLUGGED, OTHERWISE SEALED. NO EXISTING CONDUIT SHALL BE LEFT OPEN END.
- H. EXISTING MECHANICAL AND ELECTRICAL EQUIPMENT, CONDUIT, WIRING, DEVICES, AND MATERIALS AFFECTED BY DEMOLITION OR NEW WORK INSTALLATION AND REQUIRED TO REMAIN IN SERVICE SHALL BE REINSTALLED OR SUPPORTED AS REQUIRED IN ACCORDANCE WITH NEW WORK SPECIFICATION. ALL WORK SHALL BE COMPLETED TO THE SATISFACTION OF THE ENGINEER AND AT NO ADDITIONAL CONTRACT COST.
- I. PATCH TO MATCH EXISTING ALL NEW AND EXISTING OPENINGS AND WALLS, CEILINGS, ROOF, AND FLOOR SURFACES DAMAGED OR CREATED BY DEMOLITION WORK. PATCHING WHERE POSSIBLE SHALL MATCH EXISTING ADJACENT SURFACES AS TO THICKNESS, TEXTURES, MATERIALS, AND COLOR. ALL PATCHING SHALL BE PERFORMED TO THE SATISFACTION OF THE ARCHITECT AND AT NO ADDITIONAL CONTRACT COST.
- J. IN GENERAL ALL EQUIPMENT AND MATERIALS SHOWN "LIGHT" IS EXISTING TO REMAIN. ALL EQUIPMENT AND MATERIALS SHOWN "HEAVY AND HATCHED" IS EXISTING AND SHALL BE DEMOLISHED.

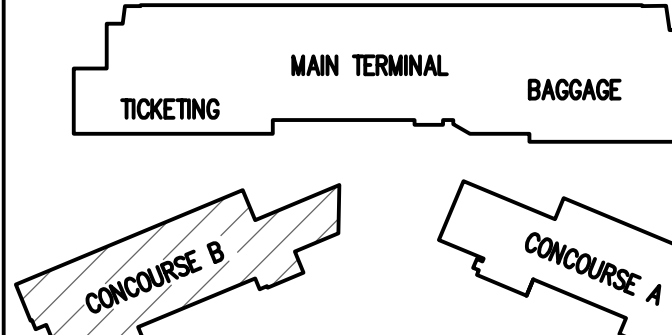

KEY PLAN

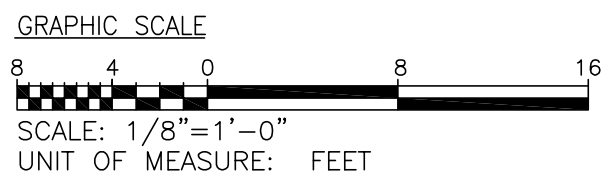

DRAWN BY: JMT
REVIEWED BY: JMT
DATE: 07-18-19
PROJECT NO.: 1808

REVISIONS		
Δ	DBE-6	07/31/20
Δ	DBE-19	05/13/21

SHEET NUMBER

TD1.01C

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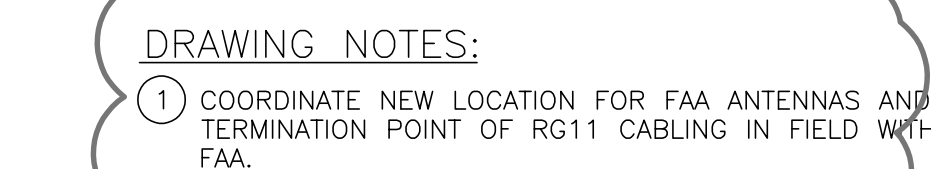
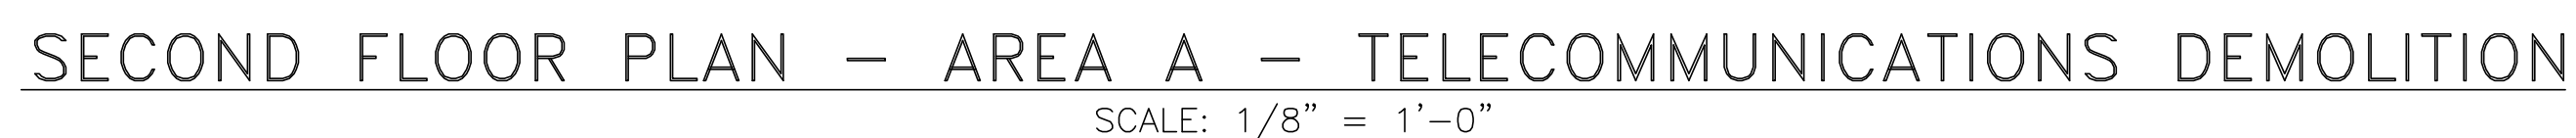
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NC license No: C-1126
RMF Project No: 2153223.F0


Fayetteville Regional Airport — Airline Terminal Improvements Part 2

FIRST FLOOR PLAN — AREA C — TELECOMMUNICATIONS
DEMOLITION

400 Airport Road
Fayetteville, North Carolina 28306



- ## GENERAL DEMOLITION NOTES
- A. NOTIFY THE OWNER, IN WRITING, AT LEAST SEVEN (7) DAYS IN ADVANCE OF ALL REQUIRED SHUTDOWNS OF ELECTRICAL SERVICE, OR OTHER UTILITIES, UPON WRITTEN REQUEST. APPROPRIATE REPAIRS AND RECONSTRUCTION SHALL BE PERFORMED DURING HOURS AS DIRECTED BY THE OWNER AND SHALL BE ACCOMPLISHED AT NO ADDITIONAL COST TO THE PROJECT. AFTER EACH SHUT DOWN ALL SERVICES SHALL BE RESTORED.
 - B. WHEN WORKING IN AND AROUND THE EXISTING BUILDING, EXTREME CARE SHALL BE EXERCISED WITH REGARD TO THE PROTECTION OF EXISTING UTILITIES, STRUCTURES, MECHANICAL AND ELECTRICAL SERVICES WHICH WILL BE REPAIRED, RECONSTRUCTED OR RELOCATED. THE SATISFACTION OF THE OWNER ALL EXISTING WORK DAMAGED IN THE PERFORMANCE OF DEMOLITION AND/OR NEW WORK SHALL BE THE RESPONSIBILITY OF THE CONTRACTOR.
 - C. ALL EXISTING WIRING, EQUIPMENT, CONDUITS, AND MATERIALS NOT REQUIRED FOR RE-INSTALLATION SHALL BE RE-INSTALLED (SHOWN OR OTHERWISE) SHALL BE REMOVED. ALL EXISTING WIRING AND EQUIPMENT WHICH ARE REMOVED AND NOT DESIRED BY THE OWNER, OR ARE INDICATED TO REMAIN THE PROPERTY OF THE OWNER, SHALL BE REMOVED AND DELIVERED TO THE OWNER. THE CONTRACTOR WHERE DIRECTED BY THE ENGINEER, ALL OTHER MATERIALS AND EQUIPMENT WHICH ARE REMOVED SHALL BE DESTROYED. THE CONTRACTOR AND SHALL BE REMOVED BY THE CONTRACTOR FROM THE PROJECT SITE.
 - D. EXISTING CONDUITS, LIGHTING FIXTURES, RECEPTACLES, PANELBOARDS, UTILITIES, AND MATERIALS, INCLUDING ALL EQUIPMENT, AND MATERIALS, INDICATED ARE BASED ON RECORDS OBTAINED FROM THE OWNER, FIELD DRAWINGS AND FIELD SURVEYS AND ARE NOT WARRANTED TO BE COMPLETE OR CORRECT. CONTRACTOR SHALL FIELD VERIFY THE LOCATION OF ALL UTILITIES AND MATERIALS AND MATERIALS IN THE FIELD PRIOR TO STARTING ALL WORK.
 - E. EXISTING EQUIPMENT SIZES NOTED ARE FOR THE CONVENIENCE OF THE CONTRACTOR ONLY AND ARE NOT WARRANTED TO BE CORRECT. CONTRACTOR SHALL VERIFY ALL SIZES IN THE FIELD IF THEY EFFECT HIS WORK.
 - F. WHEN EXISTING MECHANICAL AND ELECTRICAL WORK IS REMOVED, ALL CONDUITS, WIRING AND MATERIALS SHALL BE REMOVED TO A MINIMUM OF TWO (2) FEET ABOVE OR BEHIND FINISHED WALLS AND CAPPED. SUCH POINTS SHALL BE FAR ENOUGH BEHIND FINISHED SURFACES TO ALLOW FOR THE INSTALLATION OF THE NORMAL THICKNESS OF FINISHED MATERIAL.
 - G. EXISTING WIRING & CONDUIT NO LONGER REQUIRED TO REMAIN IN SERVICE (SHOWN OR OTHERWISE) SHALL BE REMOVED AND DESTROYED AND NOT RE-INSTALLED, UNLESS OTHERWISE INDICATED OR NOTED ON THE PLANS. REMOVE EXISTING PIPE HANGERS, SUPPORTS, CONDUIT, AND WIRING FROM THE BACKGROUND. WIRING SHALL BE LIMITED TO PIPING IN THE AREAS OCCUPIED BY THE NEW CONSTRUCTION AND SHALL BE LIMITED TO THE NEW CONSTRUCTION. EXISTING CONDUIT INDICATED OR REQUIRED TO REMAIN IN SERVICE OR FOR FUTURE USE SHALL BE CAPPED, AND OTHERWISE DESTROYED. EXISTING CONDUIT SHALL BE LEFT OPEN END.
 - H. EXISTING MECHANICAL AND ELECTRICAL EQUIPMENT, CONDUIT, WIRING, DEVICES, AND MATERIALS AFFECTED BY DEMOLITION OR NEW WORK SHALL BE REMOVED OR REMOVED TO REMAIN IN SERVICE SHALL BE REINSTALLED OR SUPPORTED AS REQUIRED IN ACCORDANCE WITH NEW APPROVED SPECIFICATIONS. CONTRACTOR SHALL BE HELD TO THE SATISFACTION OF THE ENGINEER AND AT NO ADDITIONAL CONTRACT COST.
 - I. PATCH TO MATCH EXISTING ALL NEW AND EXISTING WALLS AND WALLS AND WALLS AND WALLS AND WALLS SURFACES DAMAGED OR CREATED BY DEMOLITION WORK. PATCHING SHALL BE DONE TO MATCH EXISTING SURFACES ADJACENT SURFACES AS TO THICKNESS, TEXTURE, COLOR, MATERIALS, AND COLOR. ALL PATCHING SHALL BE PERFORMED TO THE SATISFACTION OF THE ARCHITECT AND AT NO ADDITIONAL CONTRACT COST.
 - J. IN GENERAL ALL EQUIPMENT AND MATERIALS SHOWN "LIGHT" IS EXISTING TO REMAIN, ALL EQUIPMENT AND MATERIALS SHOWN "HEAVY AND HATCHED" IS EXISTING AND TO BE REMOVED.

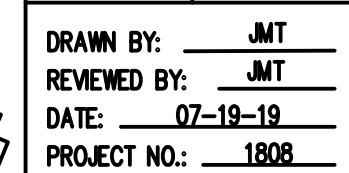

REVISIONS		
1	CBE-6	07/31/20
2	CBE-7	08/10/20
3		


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TD1 02A

11107A

101.027A



SECOND FLOOR PLAN – AREA B – TELECOMMUNICATIONS DEMOLITION
SCALE: 1/8" = 1'-0"

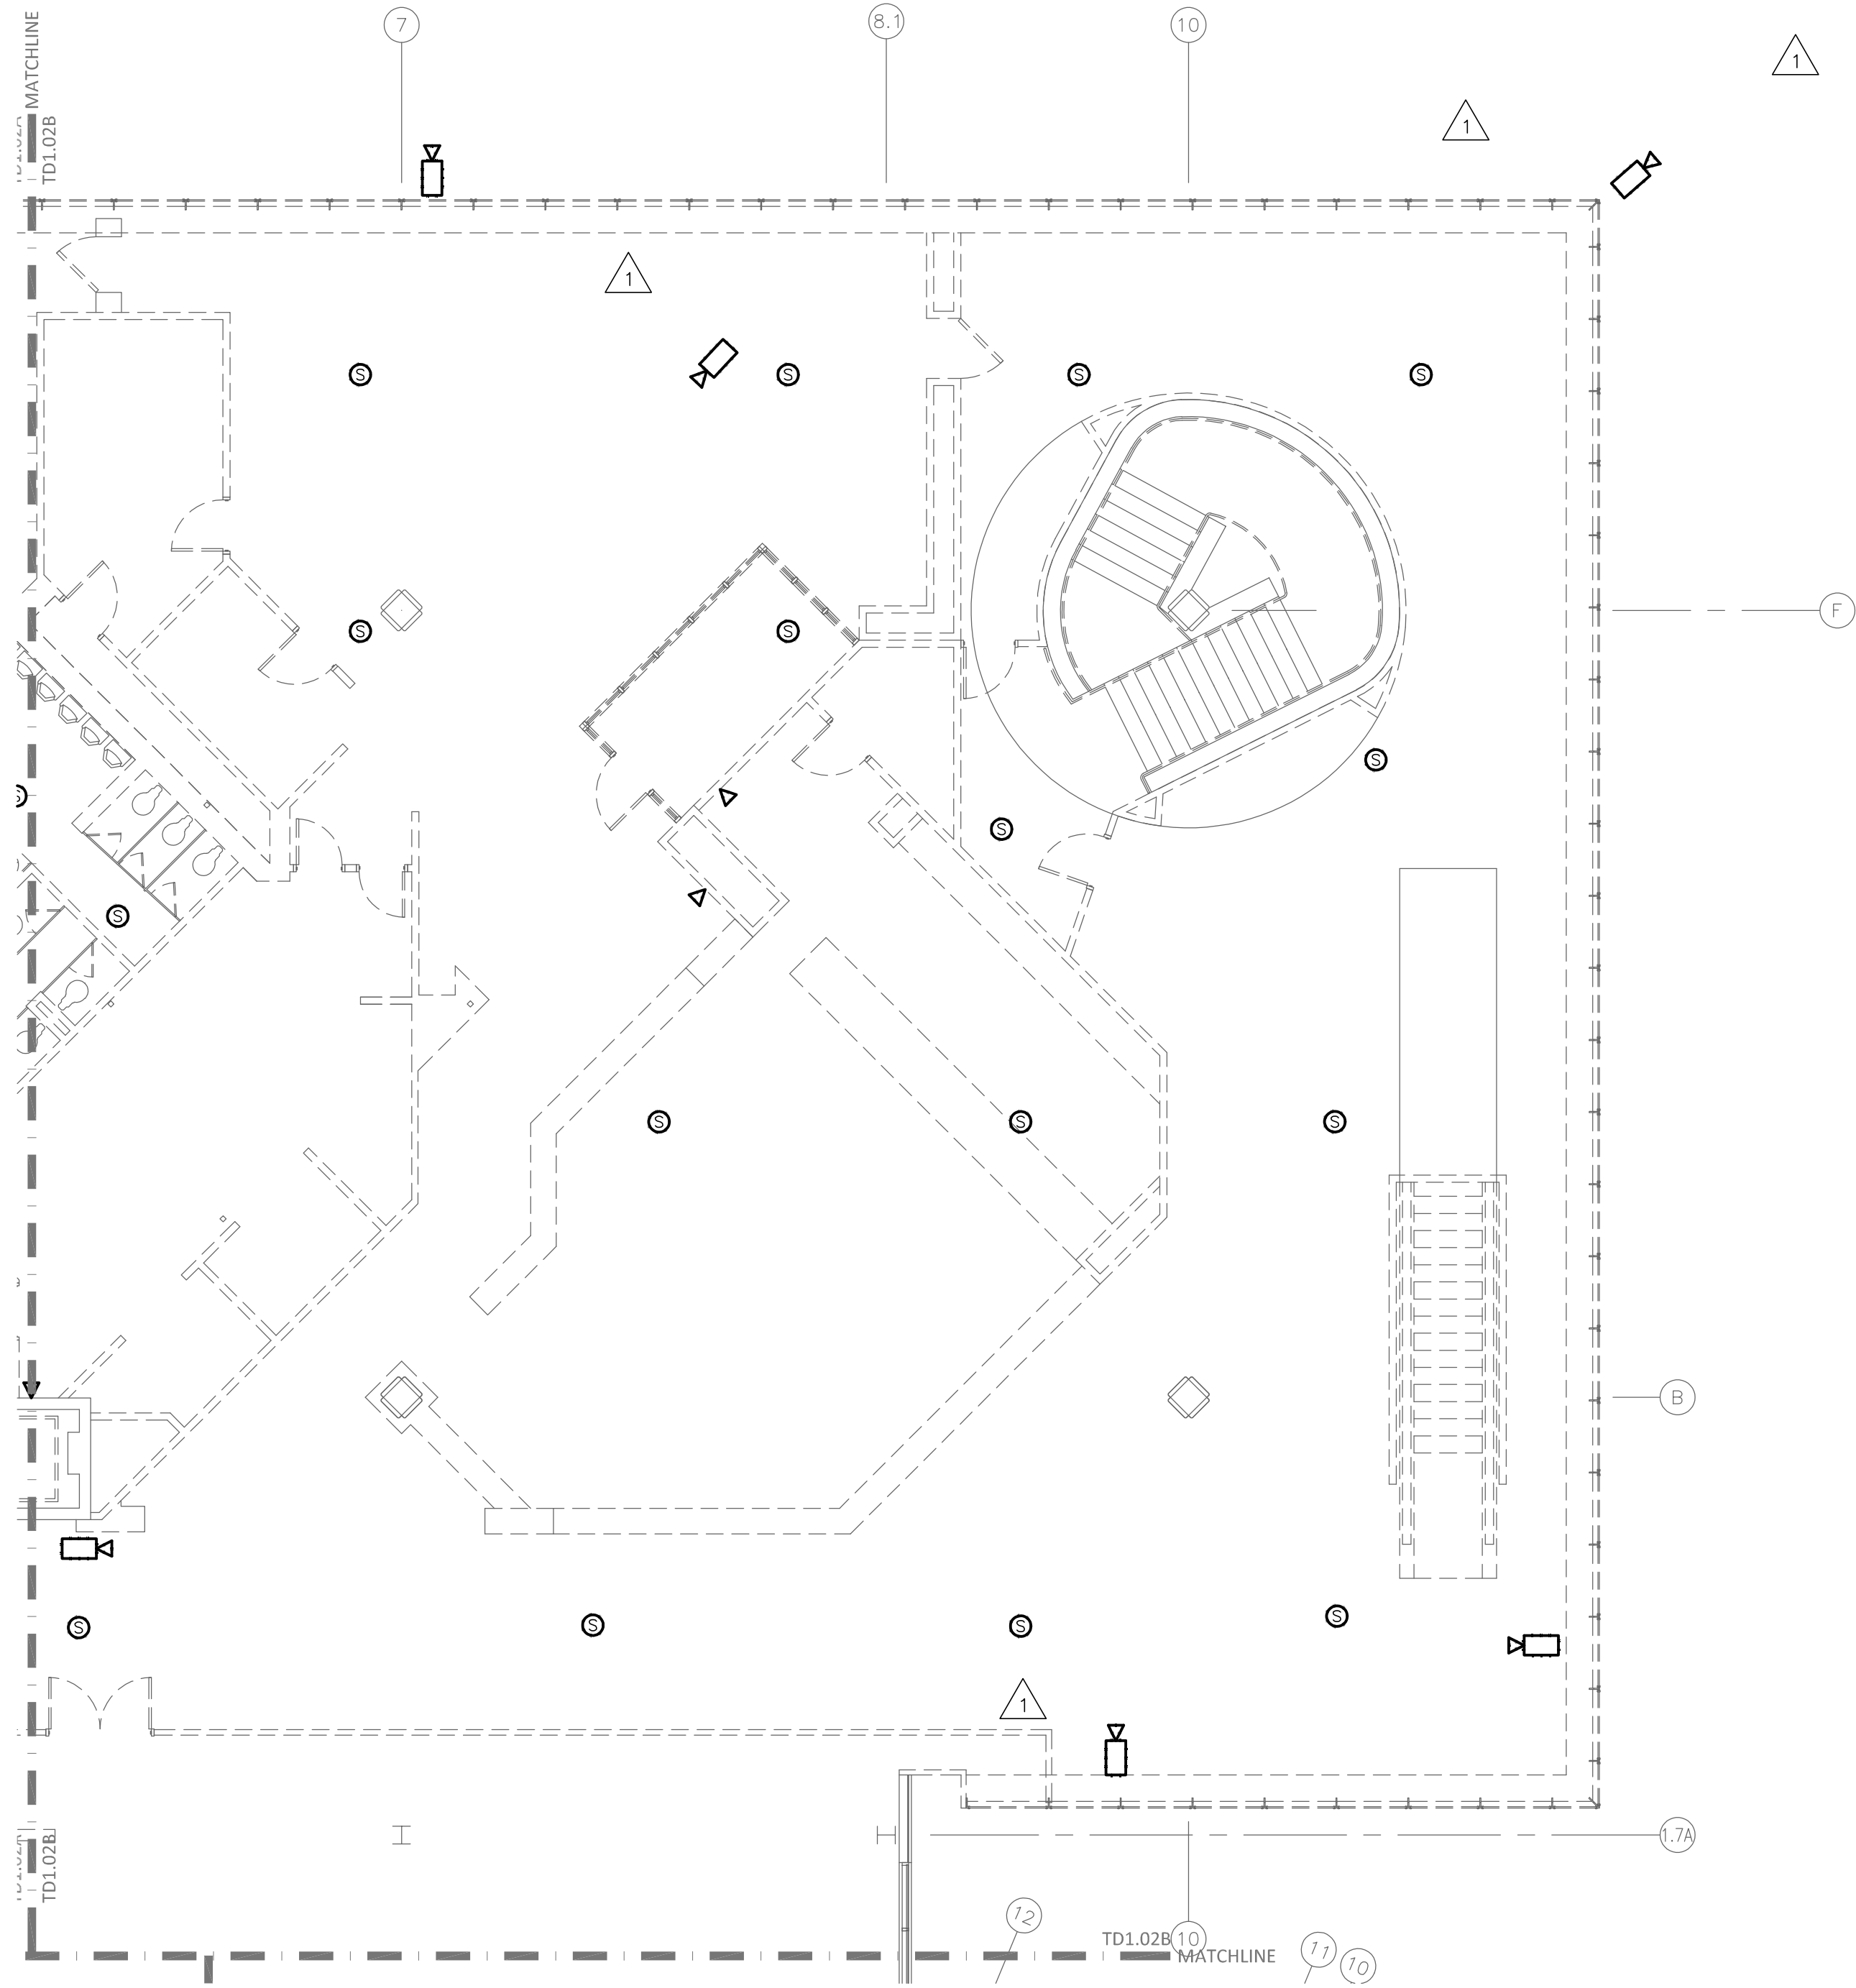GENERAL DEMOLITION NOTES

- A. NOTIFY THE OWNER, IN WRITING, AT LEAST SEVEN (7) DAYS IN ADVANCE OF ALL REQUIRED SHUTDOWNS OF ELECTRICAL SERVICE, OR OTHER UTILITIES. UPON WRITTEN RECEIPT OF APPROVAL FROM OWNER, SHUTDOWNS SHALL BE PERFORMED DURING HOURS AS DIRECTED BY THE OWNER AND SHALL BE ACCOMPLISHED AT NO ADDITIONAL CONTRACT COST. AT THE END OF EACH SHUT DOWN ALL SERVICES SHALL BE RESTORED.
- B. WHEN WORKING IN AND AROUND THE EXISTING BUILDING, EXTREME CARE SHALL BE EXERCISED WITH REGARD TO PROTECTION OF THE EXISTING STRUCTURE AND MECHANICAL AND ELECTRICAL SERVICES WHICH WILL REMAIN. REPAIR, REPLACE, OR RESTORE TO THE SATISFACTION OF THE OWNER ALL EXISTING WORK DAMAGED IN THE PERFORMANCE OF DEMOLITION AND/OR NEW WORK.
- C. ALL EXISTING WIRING, EQUIPMENT, CONDUITS, AND MATERIALS NOT REQUIRED FOR RE-USE OR RE-INSTALLATION (SHOWN OR OTHERWISE) SHALL BE REMOVED. ALL EXISTING MATERIALS AND EQUIPMENT WHICH ARE REMOVED AND ARE DESIRED BY THE OWNER, OR ARE INDICATED TO REMAIN THE PROPERTY OF THE OWNER, SHALL BE DELIVERED TO HIM ON THE PREMISES BY THE CONTRACTOR WHERE DIRECTED BY THE ENGINEER. ALL OTHER MATERIALS AND EQUIPMENT WHICH ARE REMOVED SHALL BECOME THE PROPERTY OF THE CONTRACTOR AND SHALL BE REMOVED BY THE CONTRACTOR FROM THE PREMISES.
- D. EXISTING CONDITIONS, I.E., PRESENCE AND LOCATION OF PANELBOARDS, LIGHTING FIXTURES, RECEPTACLES, EQUIPMENT, AND MATERIALS, INDICATED ARE BASED ON INFORMATION OBTAINED FROM AVAILABLE RECORD DRAWINGS AND FIELD SURVEYS AND ARE NOT WARRANTED TO BE COMPLETE OR CORRECT. CONTRACTOR SHALL FIELD VERIFY EXACT LOCATION OF ALL CONDUITS, EQUIPMENT, AND MATERIALS IN THE FIELD PRIOR TO STARTING ALL WORK.
- E. EXISTING EQUIPMENT SIZES NOTED ARE FOR THE CONVENIENCE OF THE CONTRACTOR ONLY AND ARE NOT WARRANTED TO BE CORRECT. CONTRACTOR SHALL VERIFY ALL SIZES IN THE FIELD IF THEY EFFECT HIS WORK.
- F. WHEN EXISTING MECHANICAL AND ELECTRICAL WORK IS REMOVED, ALL CONDUITS, WIRING AND MATERIALS SHALL BE REMOVED TO A POINT BELOW THE FINISHED FLOORS OR BEHIND FINISHED WALLS AND CAPPED. SUCH POINTS SHALL BE FAR ENOUGH BEHIND FINISHED SURFACES TO ALLOW FOR THE INSTALLATION OF THE NORMAL THICKNESS OF FINISHED MATERIAL.
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- H. EXISTING MECHANICAL AND ELECTRICAL EQUIPMENT, CONDUIT, WIRING, DEVICES, AND MATERIALS AFFECTED BY DEMOLITION OR NEW WORK INSTALLATION AND REQUIRED TO REMAIN IN SERVICE SHALL BE REINSTALLED OR SUPPORTED AS REQUIRED IN ACCORDANCE WITH NEW WORK SPECIFICATION. ALL WORK SHALL BE COMPLETED TO THE SATISFACTION OF THE ENGINEER AND AT NO ADDITIONAL CONTRACT COST.
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- J. IN GENERAL ALL EQUIPMENT AND MATERIALS SHOWN "LIGHT" IS EXISTING TO REMAIN. ALL EQUIPMENT AND MATERIALS SHOWN "HEAVY AND HATCHED" IS EXISTING AND SHALL BE DEMOLISHED.

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JOHNSON**
Architecture


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RMF Project No: 2153223.F0

Fayetteville Regional Airport – Airline Terminal Improvements Part 2
SECOND FLOOR PLAN – AREA B – TELECOMMUNICATIONS
DEMOLITION

400 Airport Road
Fayetteville, North Carolina 28306




DRAWN BY: JMT
REVIEWED BY: JMT
DATE: 07-18-19
PROJECT NO.: 1808
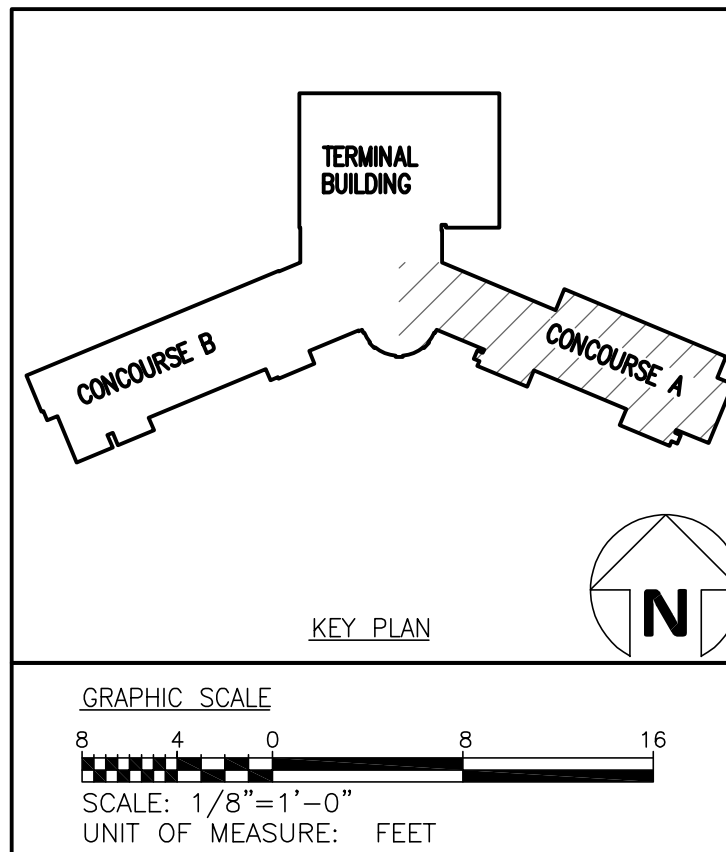
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KEY PLAN
GRAPHIC SCALE
SCALE: 1/8" = 1'-0"
UNIT OF MEASURE: FEET

SHEET NUMBER
TD1.02B

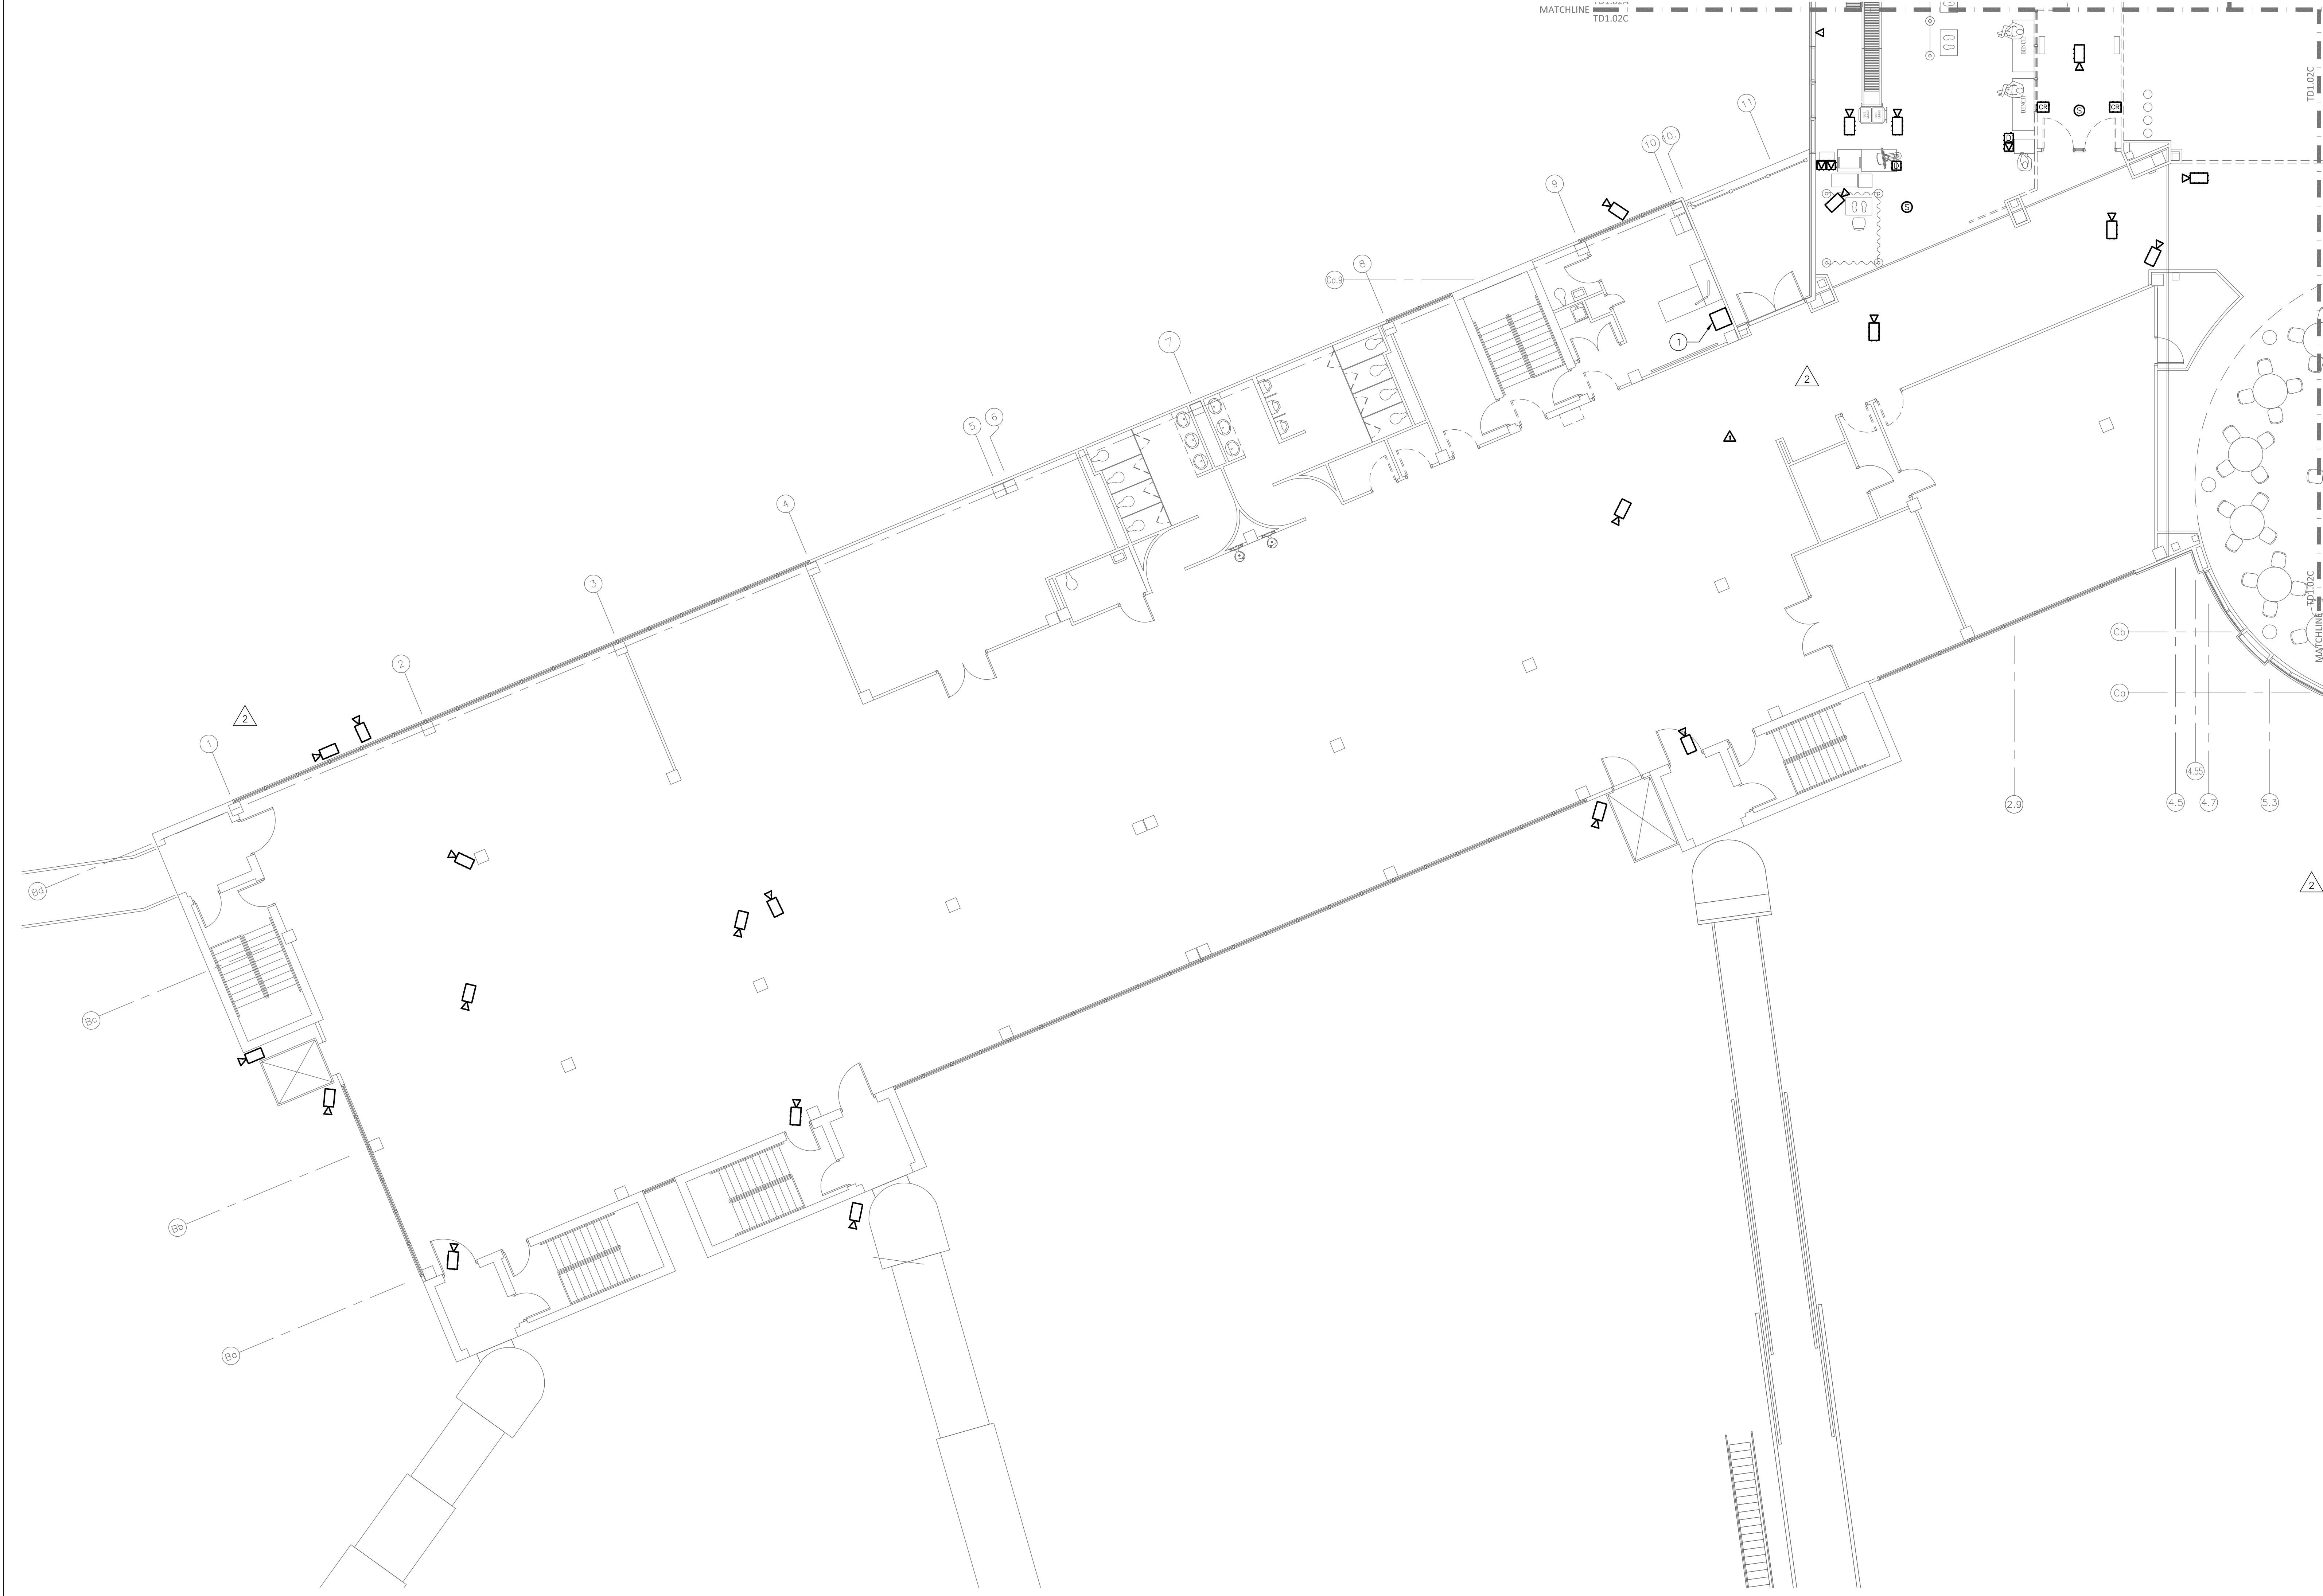

- GENERAL DEMOLITION NOTES**
- A. NOTIFY THE OWNER, IN WRITING, AT LEAST SEVEN (7) DAYS IN ADVANCE OF ALL REQUIRED SHUTDOWNS OF ELECTRICAL SERVICE, OR OTHER UTILITIES. UPON WRITTEN RECEIPT OF APPROVAL FROM OWNER, SHUTDOWNS SHALL BE PERFORMED DURING HOURS AS DIRECTED BY THE OWNER AND SHALL BE ACCOMPLISHED AT NO ADDITIONAL CONTRACT COST. AT THE END OF EACH SHUT DOWN ALL SERVICES SHALL BE RESTORED.
- B. WHEN WORKING IN AND AROUND THE EXISTING BUILDING, EXTREME CARE SHALL BE EXERCISED WITH REGARD TO PROTECTION OF THE EXISTING STRUCTURE AND MECHANICAL AND ELECTRICAL SERVICES WHICH WILL REMAIN. REPAIR, REPLACE, OR RESTORE TO THE SATISFACTION OF THE OWNER ALL EXISTING WORK DAMAGED IN THE PERFORMANCE OF DEMOLITION AND/OR NEW WORK.
- C. ALL EXISTING WIRING, EQUIPMENT, CONDUITS, AND MATERIALS NOT REQUIRED FOR RE-USE OR RE-INSTALLATION (SHOWN OR OTHERWISE) SHALL BE REMOVED. ALL EXISTING MATERIALS AND EQUIPMENT WHICH ARE REMOVED AND ARE DESIRED BY THE OWNER, OR ARE INDICATED TO REMAIN THE PROPERTY OF THE OWNER, SHALL BE DELIVERED TO HIM ON THE PREMISES BY THE CONTRACTOR WHERE DIRECTED BY THE ENGINEER. ALL OTHER MATERIALS AND EQUIPMENT WHICH ARE REMOVED SHALL BECOME THE PROPERTY OF THE CONTRACTOR AND SHALL BE REMOVED BY THE CONTRACTOR FROM THE PREMISES.
- D. EXISTING CONDITIONS, I.E., PRESENCE AND LOCATION OF PANELBOARDS, LIGHTING FIXTURES, RECEPTACLES, EQUIPMENT, AND MATERIALS, INDICATED ARE BASED ON INFORMATION OBTAINED FROM AVAILABLE RECORD DRAWINGS AND FIELD SURVEYS AND ARE NOT WARRANTED TO BE COMPLETE OR CORRECT. CONTRACTOR SHALL FIELD VERIFY EXACT LOCATION OF ALL CONDUITS, EQUIPMENT, AND MATERIALS IN THE FIELD PRIOR TO STARTING ALL WORK.
- E. EXISTING EQUIPMENT SIZES NOTED ARE FOR THE CONVENIENCE OF THE CONTRACTOR ONLY AND ARE NOT WARRANTED TO BE CORRECT. CONTRACTOR SHALL VERIFY ALL SIZES IN THE FIELD IF THEY EFFECT HIS WORK.
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- DRAWING NOTES:**
- ① LOCATION OF EXISTING SECURITY RACK. REMOVE RACK AFTER RELOCATION OF SECURITY EQUIPMENT TO TELECOM ROOM A2##.

SECOND FLOOR PLAN — AREA C — TELECOMMUNICATIONS DEMOLITION
SCALE: 1/8" = 1'-0"

TERMINAL BUILDING

CONCOURSE B

CONCOURSE A

KEY PLAN

GRAPHIC SCALE
SCALE: 1/8" = 1'-0"
UNIT OF MEASURE: FEET

REVISIONS

NO. 3	08/14/19
NO. 6	07/31/20

SHEET NUMBER

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Fayetteville Regional Airport — Airline Terminal Improvements Part 2

SECOND FLOOR PLAN — AREA C — TELECOMMUNICATIONS DEMOLITION


400 Airport Road
Fayetteville, North Carolina 28306

DRAWN BY: JMT
REVIEWED BY: JMT
DATE: 07-18-19
PROJECT NO.: 1808

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SECOND FLOOR PLAN — AREA D — TELECOMMUNICATIONS DEMOLITION
SCALE: 1/8" = 1'-0"

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- GENERAL SHEET NOTES**
1. COORDINATE DEVICE MOUNTING HEIGHTS FOR MILLWORK AND FURNITURE WITH ARCHITECTURAL DRAWINGS.


KEY PLAN

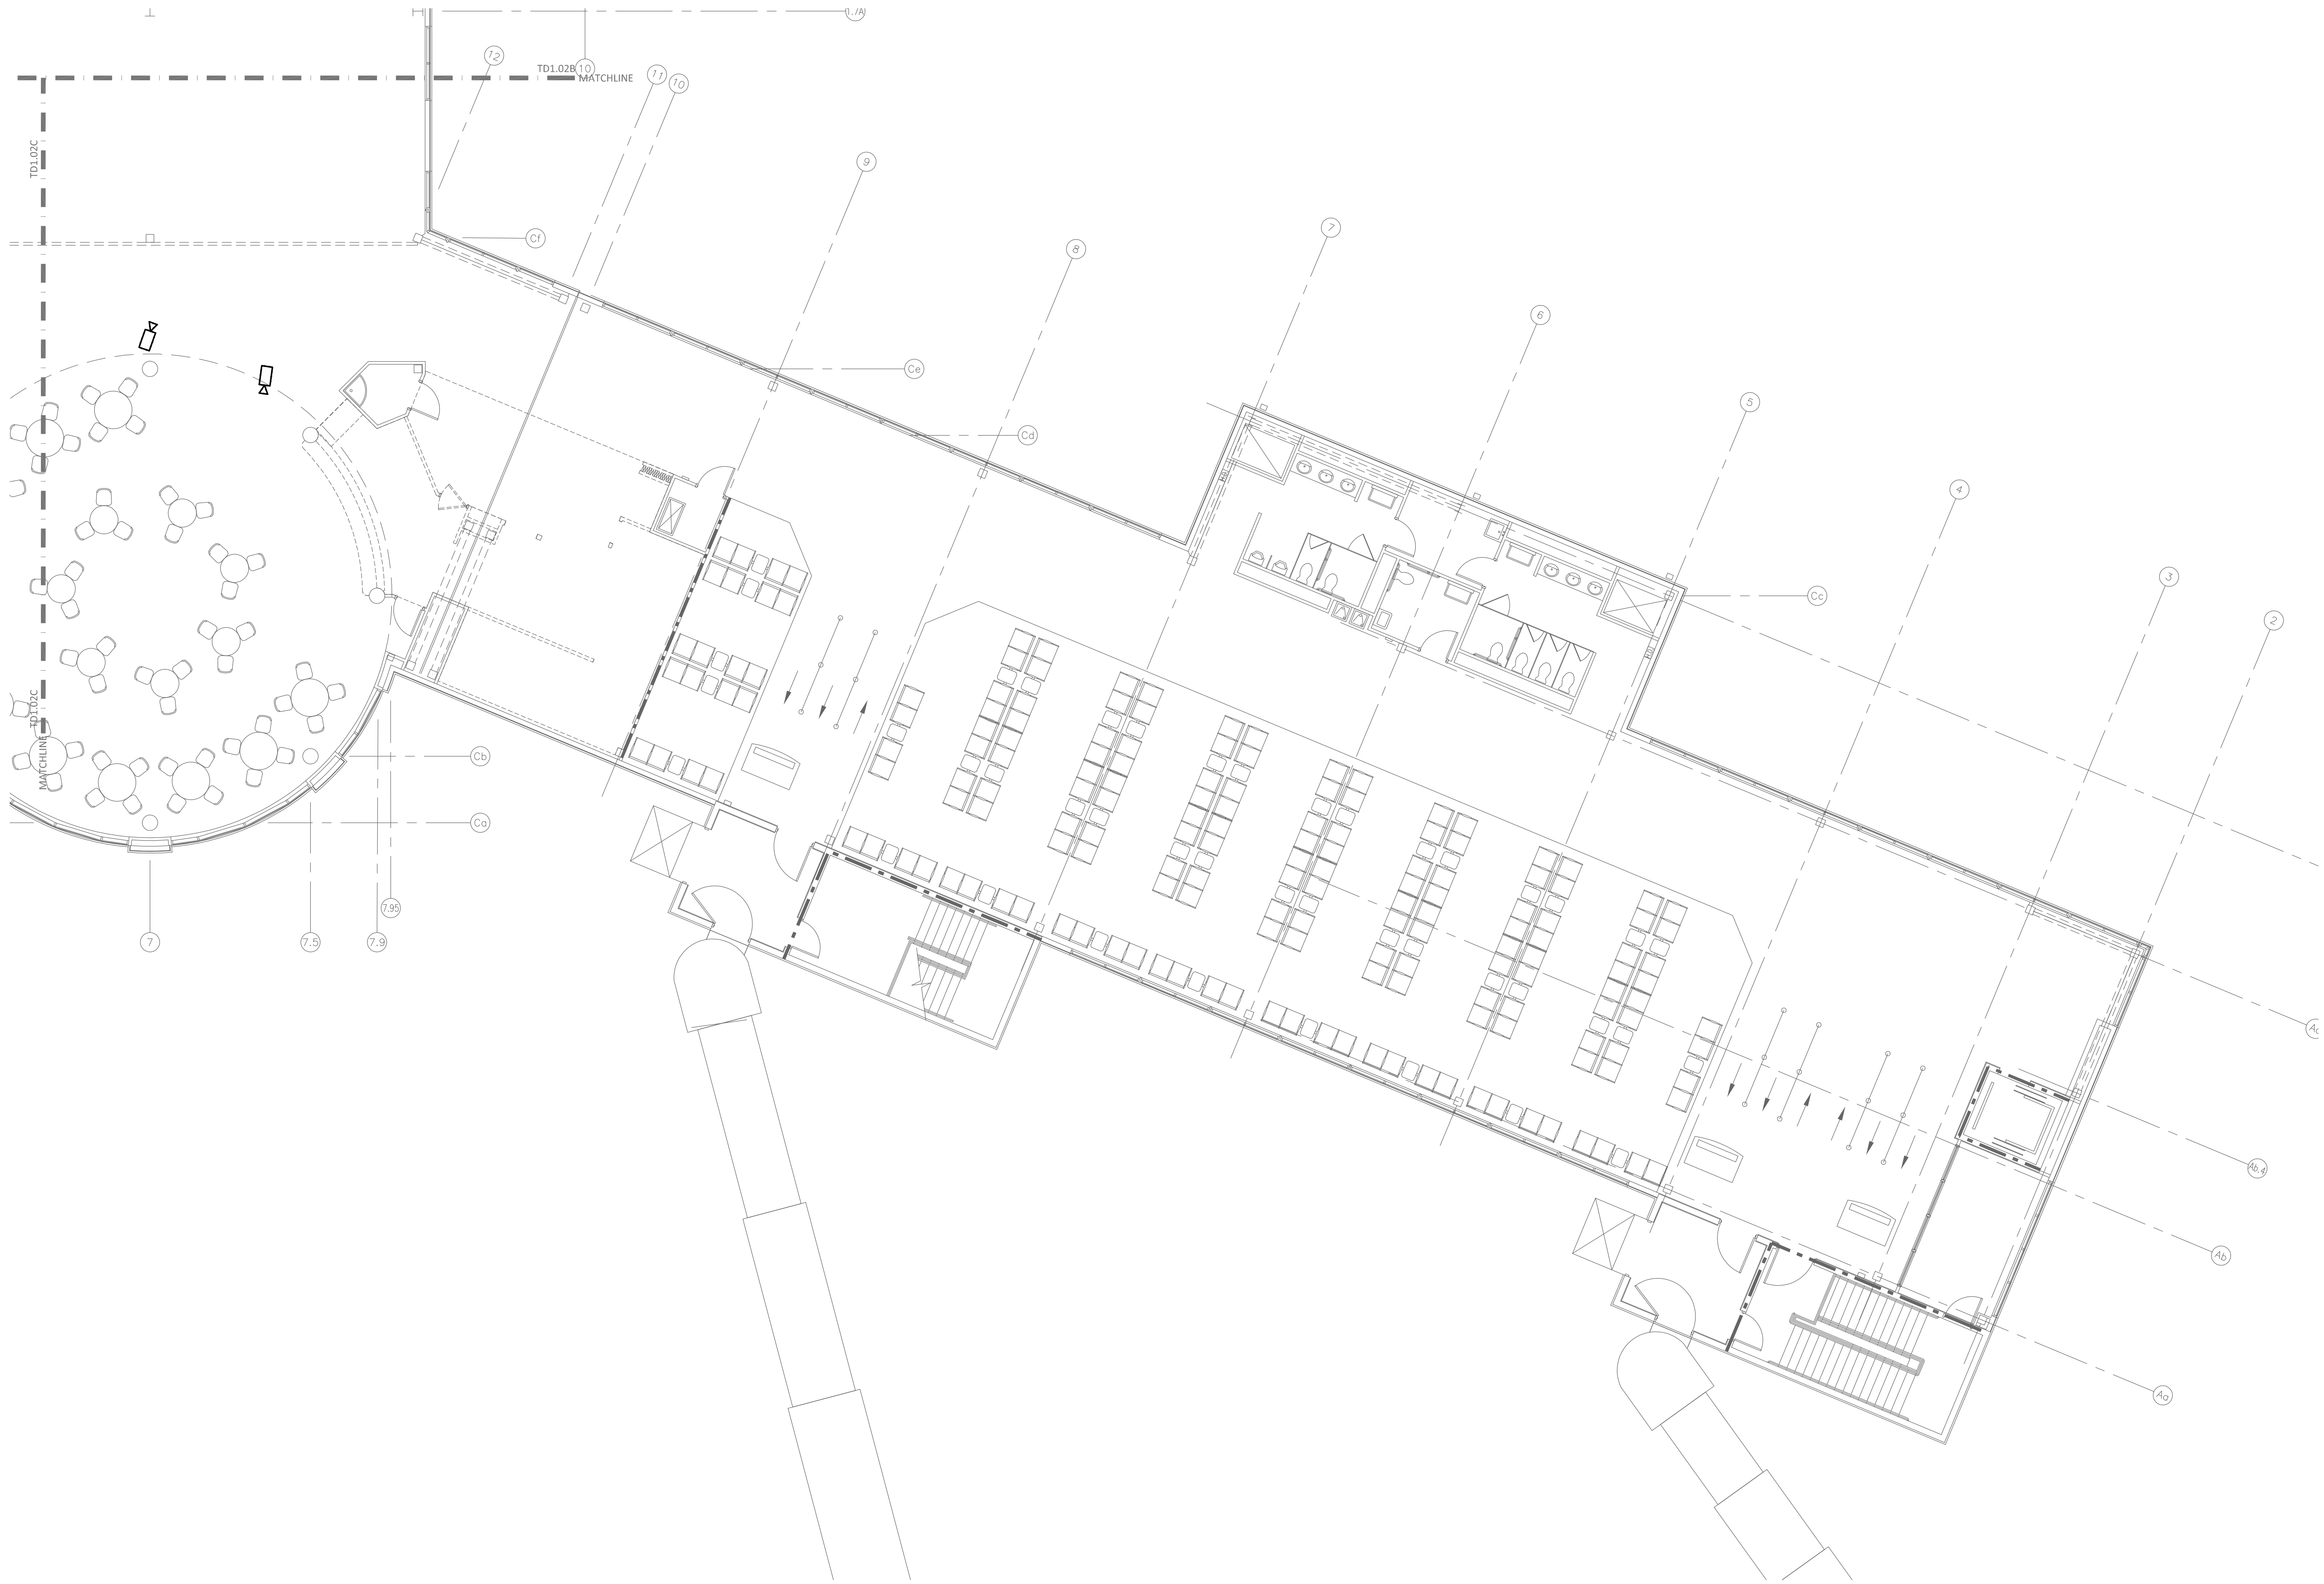TERMINAL BUILDING
CONCOURSE B
CONCOURSE A

GRAPHIC SCALE
SCALE: 1/8" = 1'-0"
UNIT OF MEASURE: FEET


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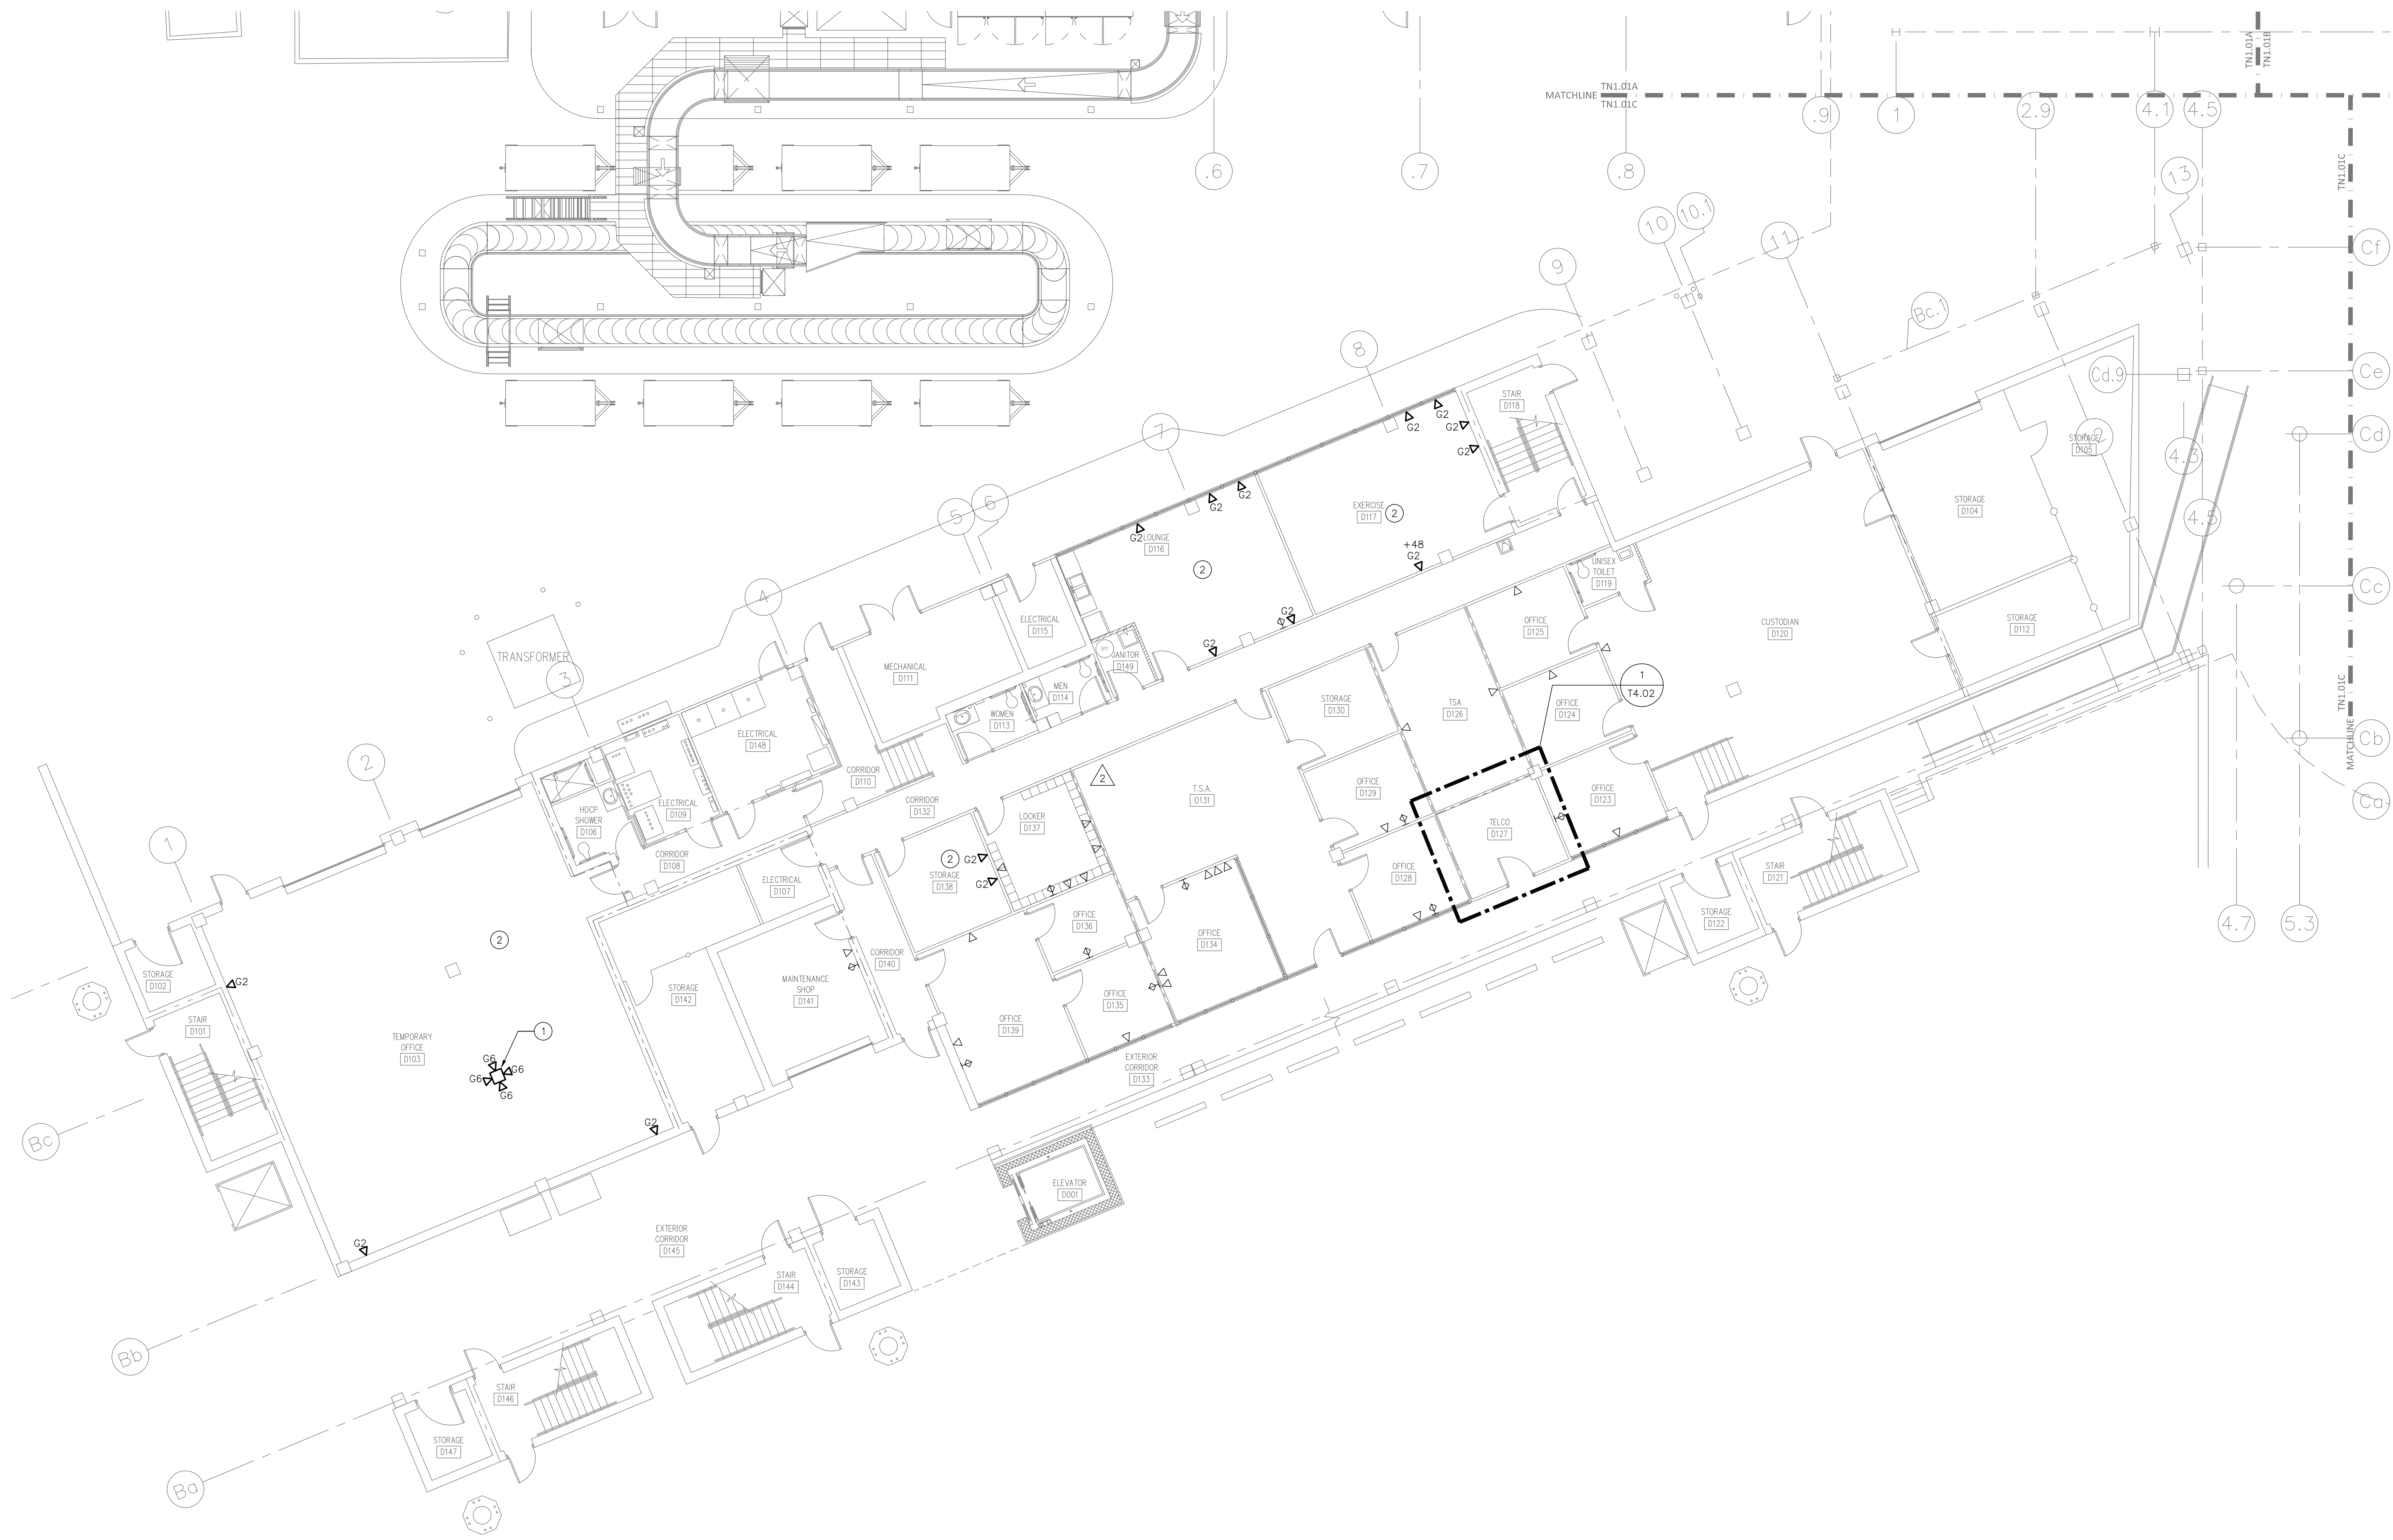


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Fayetteville Regional Airport – Airline Terminal Improvements Part 2	400 Airport Road Fayetteville, North Carolina 28306	FIRST FLOOR PLAN – AREA A – TELECOMMUNICATIONS
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A schematic diagram of the airport terminal and concourses. The terminal is a long, narrow building divided into three sections: 'TICKETING' on the left, 'MAIN TERMINAL' in the center, and 'BAGGAGE' on the right. The 'BAGGAGE' section is shaded with diagonal lines. To the left of the terminal is 'CONCOURSE B', and to the right is 'CONCOURSE A'. Below the terminal is a 'GRAPHIC SCALE' with markings for 0, 4, 8, and 16 feet. Below the scale is the text 'SCALE: 1/8"=1'-0"' and 'UNIT OF MEASURE: FEET'. To the right of the scale is a north arrow pointing upwards, with a large 'N' inside a circle.

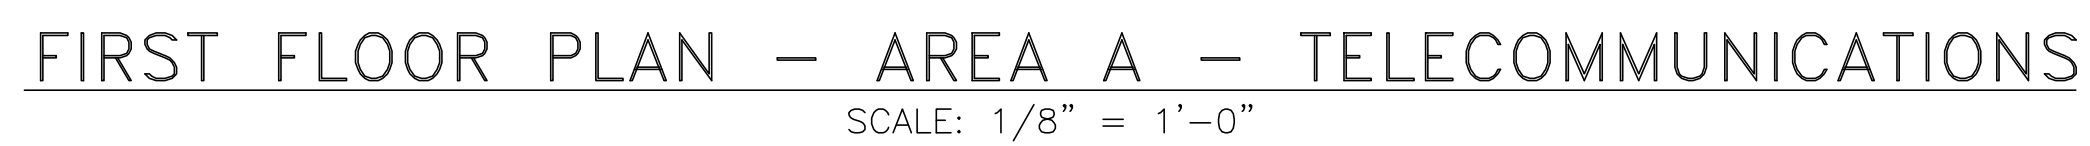

FIRST FLOOR PLAN — AREA C — TELECOMMUNICATIONS
SCALE: 1/8" = 1'-0"

GENERAL NEW WORK NOTES

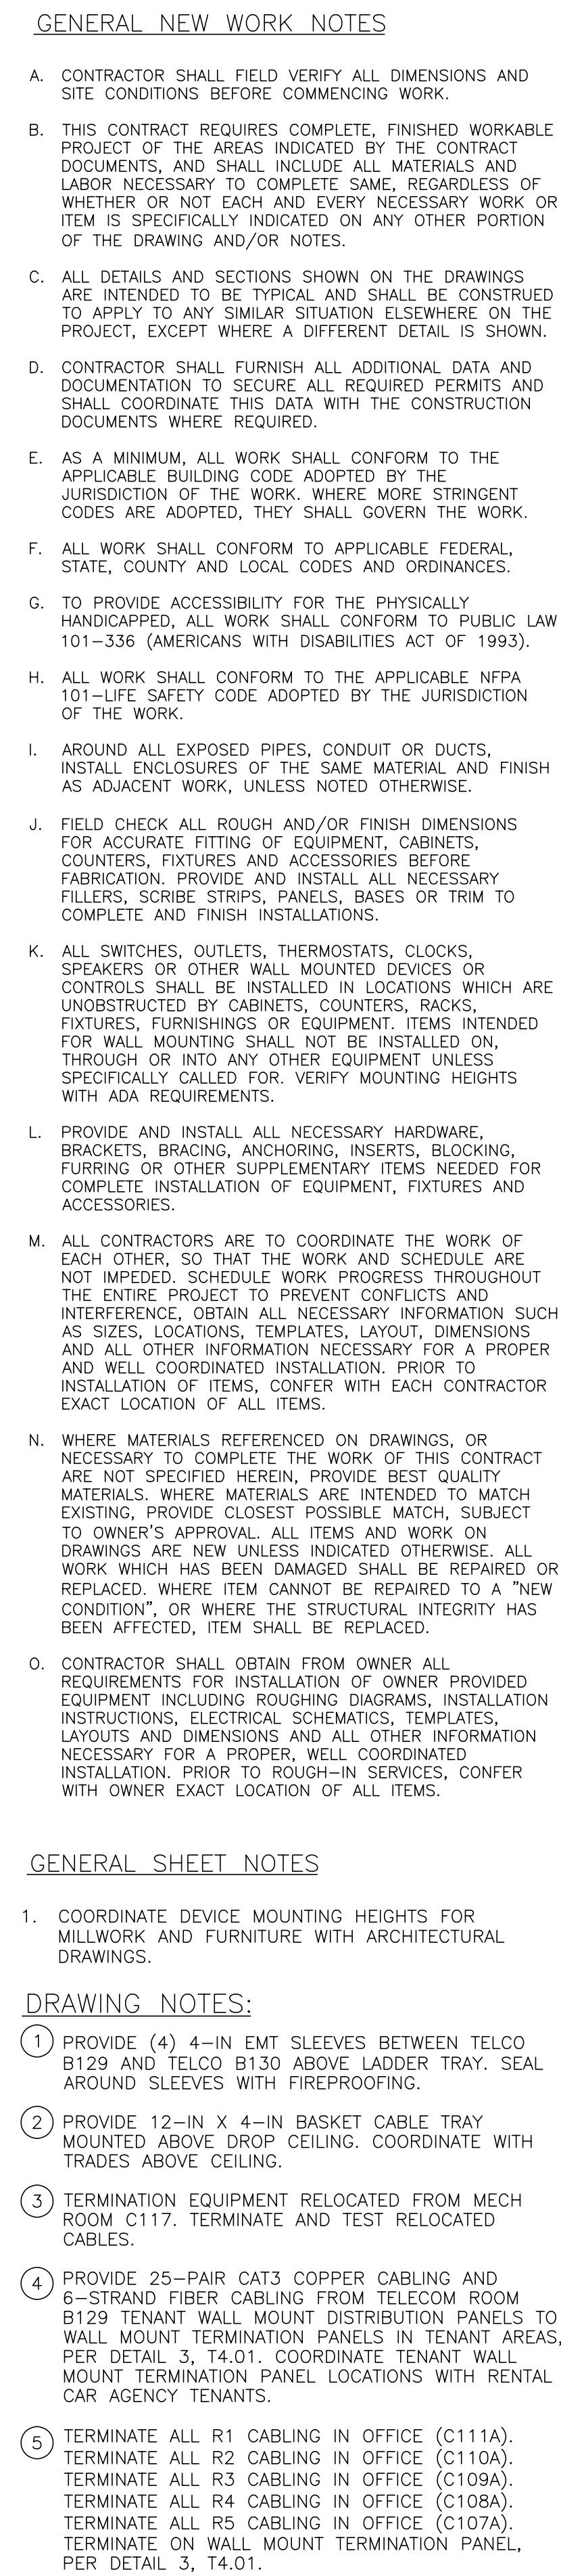- CONTRACTOR SHALL FIELD VERIFY ALL DIMENSIONS AND SITE CONDITIONS BEFORE COMMENCING WORK.
- THIS CONTRACT REQUIRES COMPLETE, FINISHED WORKABLE PROJECT OF THE AREAS INDICATED BY THE CONTRACT DOCUMENTS, AND SHALL INCLUDE ALL MATERIALS AND LABOR NECESSARY TO COMPLETE SAME, REGARDLESS OF WHETHER OR NOT EACH AND EVERY NECESSARY WORK OR ITEM IS SPECIFICALLY INDICATED ON ANY OTHER PORTION OF THE DRAWING AND/OR NOTES.
- ALL DETAILS AND SECTIONS SHOWN ON THE DRAWINGS ARE INTENDED TO BE TYPICAL AND SHALL BE CONSTRUED TO APPLY TO ANY SIMILAR SITUATION ELSEWHERE ON THE PROJECT, EXCEPT WHERE A DIFFERENT DETAIL IS SHOWN.
- CONTRACTOR SHALL FURNISH ALL ADDITIONAL DATA AND DOCUMENTATION TO SECURE ALL REQUIRED PERMITS AND SHALL COORDINATE THIS DATA WITH THE CONSTRUCTION DOCUMENTS WHERE REQUIRED.
- AS A MINIMUM, ALL WORK SHALL CONFORM TO THE APPLICABLE BUILDING CODE ADOPTED BY THE JURISDICTION OF THE WORK, WHERE MORE STRINGENT CODES ARE ADOPTED, THEY SHALL GOVERN THE WORK.
- ALL WORK SHALL CONFORM TO APPLICABLE FEDERAL, STATE, COUNTY AND LOCAL CODES AND ORDINANCES.
- TO PROVIDE ACCESSIBILITY FOR THE PHYSICALLY HANDICAPPED, ALL WORK SHALL CONFORM TO PUBLIC LAW 101-336 (AMERICANS WITH DISABILITIES ACT OF 1993).
- ALL WORK SHALL CONFORM TO THE APPLICABLE NFPA 101-LIFE SAFETY CODE ADOPTED BY THE JURISDICTION OF THE WORK.
- AROUND ALL EXPOSED PIPES, CONDUIT OR DUCTS, INSTALL ENCLOSURES OF THE SAME MATERIAL AND FINISH AS ADJACENT WORK, UNLESS NOTED OTHERWISE.
- FIELD CHECK ALL ROUGH AND/OR FINISH DIMENSIONS FOR ACCURATE FITTING OF EQUIPMENT, CABINETS, COUNTERS, FIXTURES AND ACCESSORIES BEFORE FABRICATION, PROVIDE AND INSTALL ALL NECESSARY FILLERS, SCRIBE STRIPS, PANELS, BASES OR TRIM TO COMPLETE AND FINISH INSTALLATIONS.
- ALL SWITCHES, OUTLETS, THERMOSTATS, CLOCKS, SPEAKERS OR OTHER WALL MOUNTED DEVICES OR CONTROLS SHALL BE INSTALLED IN LOCATIONS WHICH ARE UNOBSTRUCTED BY CABINETS, COUNTERS, RACKS, FIXTURES, FURNISHINGS OR EQUIPMENT. ITEMS INTENDED FOR WALL MOUNTING SHALL NOT BE INSTALLED ON, THROUGH OR INTO ANY OTHER EQUIPMENT UNLESS SPECIFICALLY CALLED FOR. VERIFY MOUNTING HEIGHTS WITH ADA REQUIREMENTS.
- PROVIDE AND INSTALL ALL NECESSARY HARDWARE, BRACKETS, BRACING, ANCHORING, INSERTS, BLOCKING, FURNISH OR OTHER SUPPLEMENTARY ITEMS NEEDED FOR COMPLETE INSTALLATION OF EQUIPMENT, FIXTURES AND ACCESSORIES.
- ALL CONTRACTORS ARE TO COORDINATE THE WORK OF EACH OTHER, SO THAT THE WORK AND SCHEDULE ARE NOT IMPEDED, SCHEDULE WORK PROGRESS THROUGHOUT THE ENTIRE PROJECT TO PREVENT CONFLICTS AND INTERFERENCE. OBTAIN ALL NECESSARY INFORMATION SUCH AS SIZES, LOCATIONS, TEMPLATES, LAYOUT, DIMENSIONS AND ALL OTHER INFORMATION NECESSARY FOR A PROPER AND WELL COORDINATED INSTALLATION. PRIOR TO INSTALLATION OF ITEMS, CONFER WITH EACH CONTRACTOR EXACT LOCATION OF ALL ITEMS.
- WHERE MATERIALS REFERENCED ON DRAWINGS, OR NECESSARY TO COMPLETE THE WORK OF THIS CONTRACT ARE NOT SPECIFIED HEREIN, PROVIDE BEST QUALITY MATERIALS. WHERE MATERIALS ARE INTENDED TO MATCH EXISTING, PROVIDE CLOSEST POSSIBLE MATCH, SUBJECT TO OWNER'S APPROVAL. ALL ITEMS AND WORK ON DRAWINGS ARE NEW UNLESS INDICATED OTHERWISE. ALL WORK WHICH HAS BEEN DAMAGED SHALL BE REPAIRED OR REPLACED, WHERE ITEM CANNOT BE REPAIRED TO A "NEW CONDITION", OR WHERE THE STRUCTURAL INTEGRITY HAS BEEN AFFECTED, ITEM SHALL BE REPLACED.
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GENERAL SHEET NOTES

- COORDINATE DEVICE MOUNTING HEIGHTS FOR MILLWORK AND FURNITURE WITH ARCHITECTURAL DRAWINGS.
- REROUTE TELECOMMUNICATIONS CABLING IN THIS AREA TO TELECOM ROOM D127, UNLESS OTHERWISE NOTED.

DRAWING NOTES

- PROVIDE POWER POLE RACEWAY IN CENTER OF ROOM FOR DATA CABLING AND POWER.
- DATA OUTLETS IN ROOM ARE NEW AND ARE TO BE ROUTED TO TELECOM ROOM D127.

TICKETING

MAIN TERMINAL

BAGGAGE

CONCOURSE B

CONCOURSE A

KEY PLAN

GRAPHIC SCALE

SCALE: 1/8" = 1'-0"

UNIT OF MEASURE: FEET

8

4

0

8

16

8

4

0

8

16

UNIT OF MEASURE: FEET

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RMF Project No: 2153223.F0

Fayetteville Regional Airport — Airline Terminal Improvements Part 2
FIRST FLOOR PLAN — AREA C — TELECOMMUNICATIONS


400 Airport Road
Fayetteville, North Carolina 28306

DRAWN BY: JMT
REVIEWED BY: JMT
DATE: 07-18-19
PROJECT NO.: 1808

REVISIONS	
A	MODIFIED 08/14/19
B	REVISED 05/15/21

SHEET NUMBER

TN1.01C

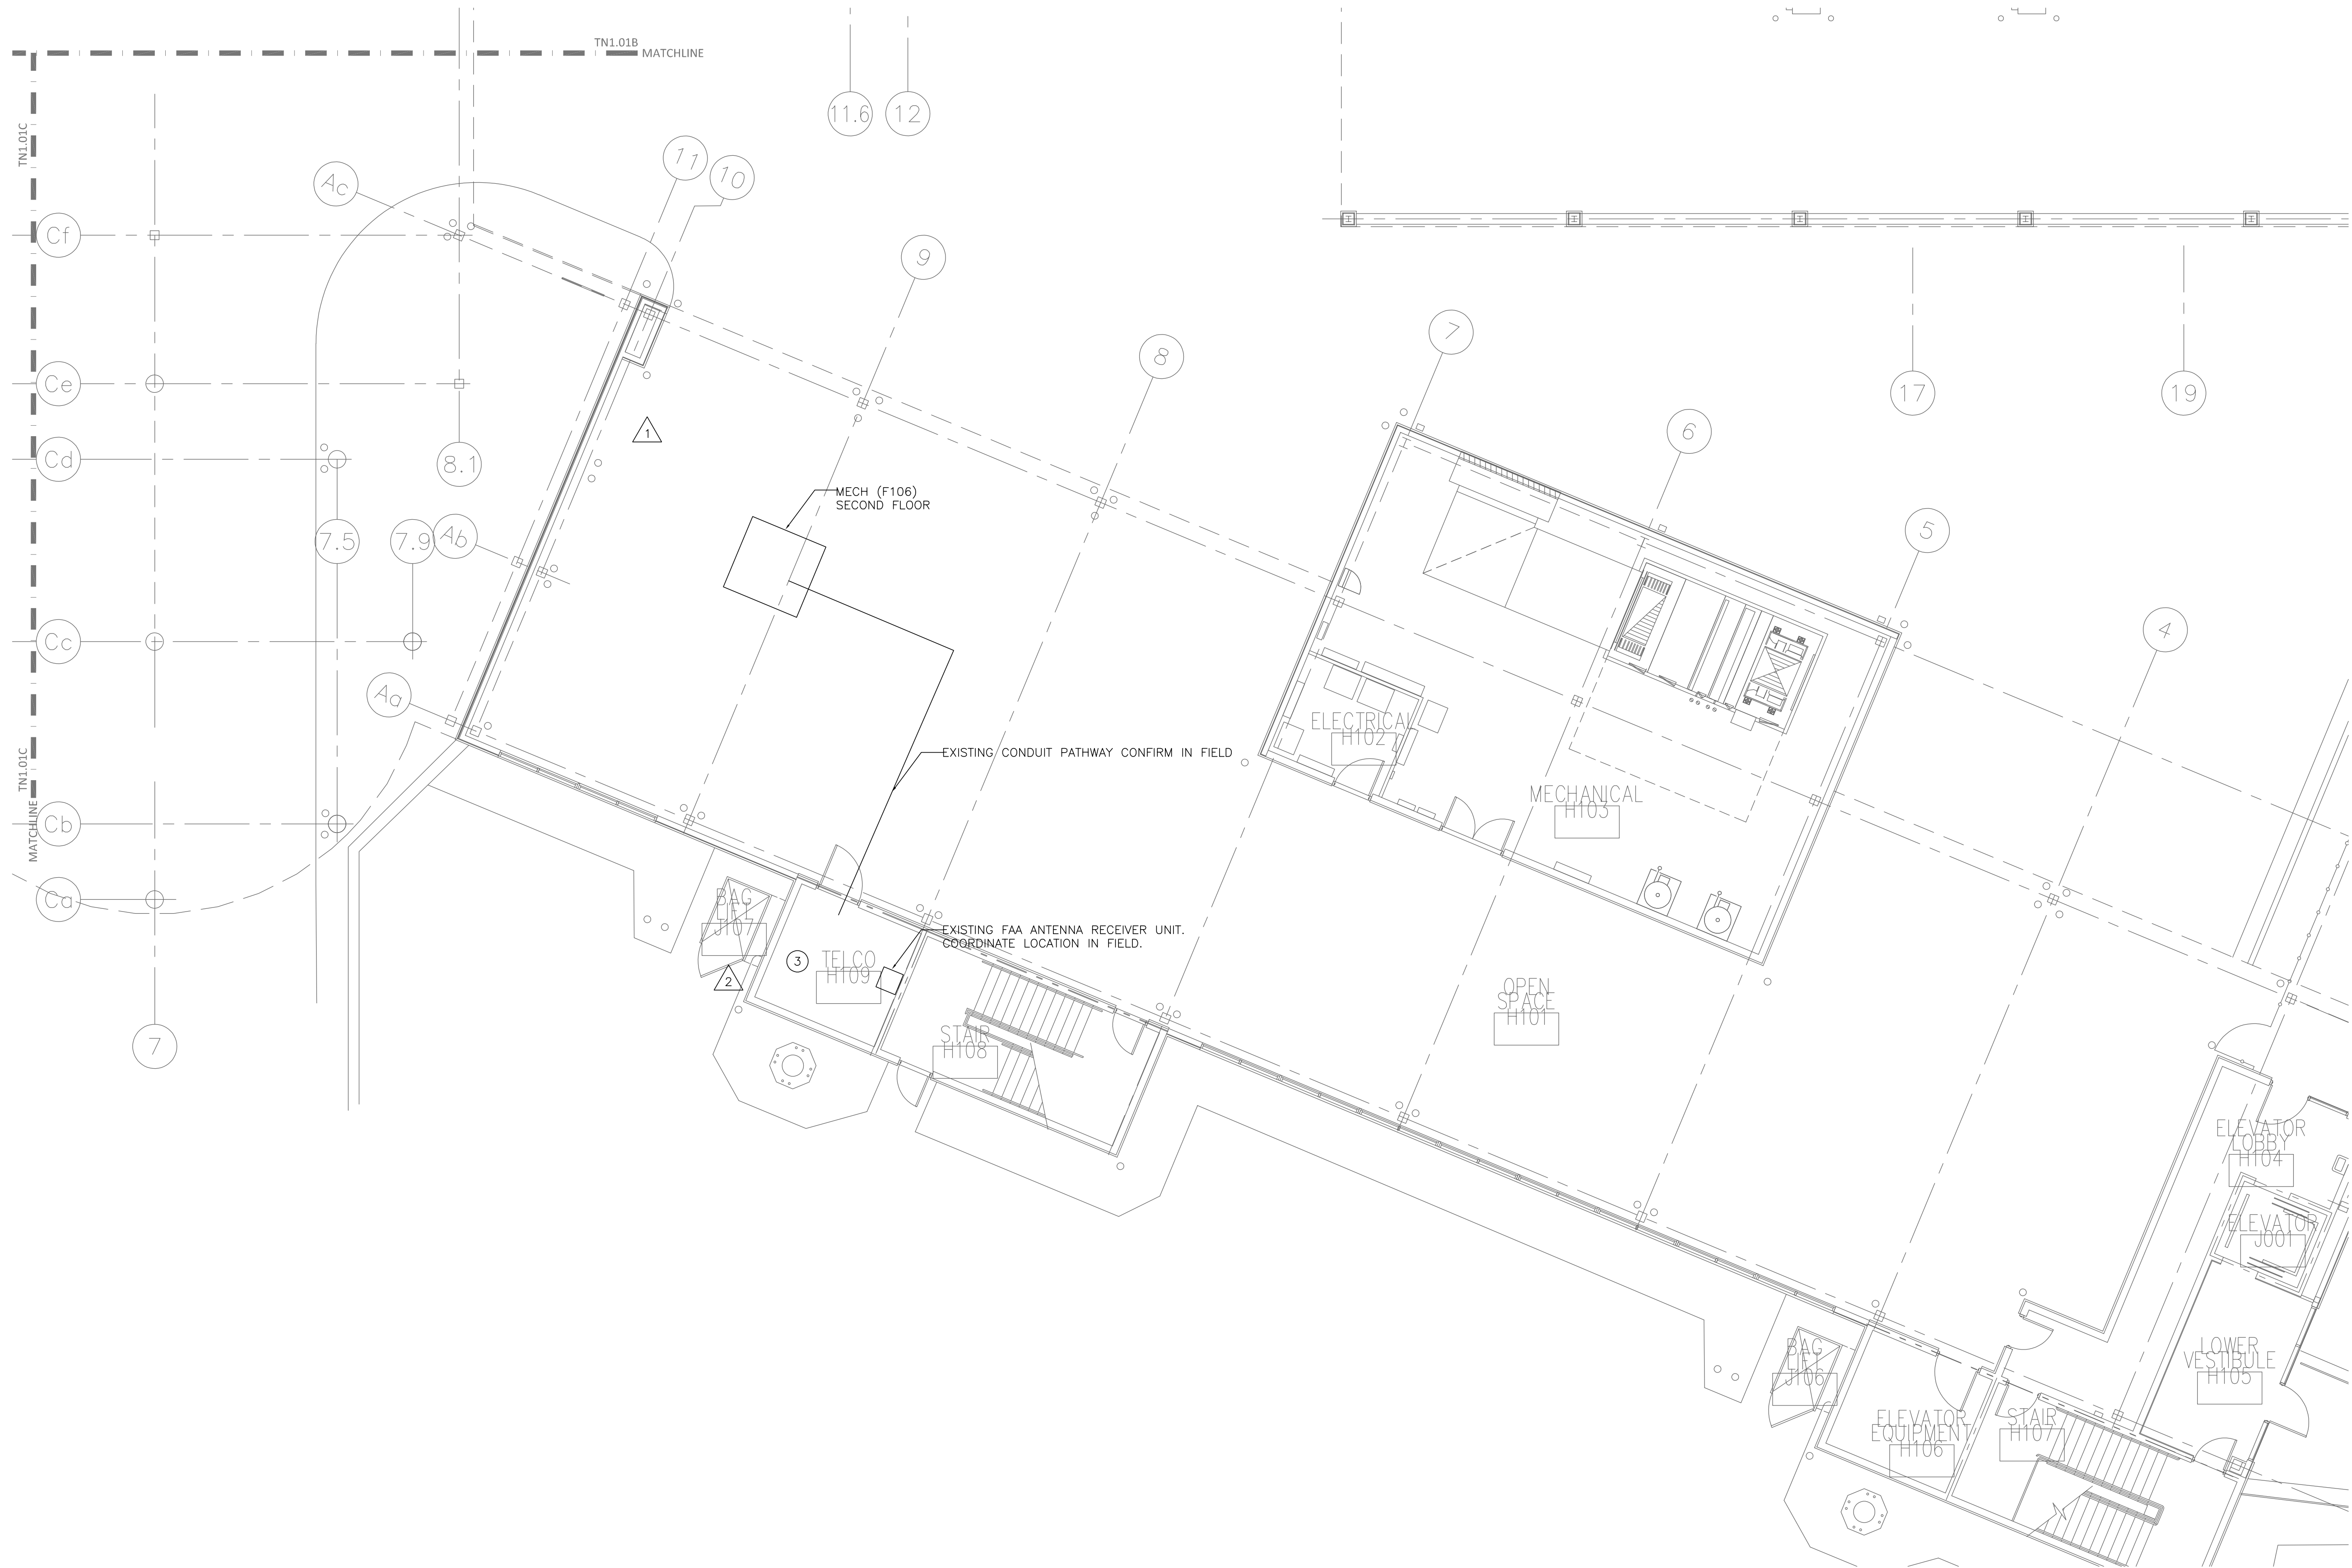


FIRST FLOOR PLAN — AREA D — TELECOMMUNICATIONS
SCALE: 1/8" = 1'-0"

GENERAL NEW WORK NOTES

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GENERAL SHEET NOTES

- RELOCATE FAA ANTENNA RECEIVER UNIT FROM MECHANICAL (C117) TO TELCO (H109). ROUTE RG11 CABLING TO ROOF VIA EXISTING CONDUITS FROM TELCO (H109) THRU MECH (F106), TO ROOF. CONFIRM AND COORDINATE PATHWAY IN FIELD.
- COORDINATE NEW LOCATION FOR FAA ANTENNAS AND TERMINATION POINT OF RG11 CABLING IN FIELD WITH FAA.
- COORDINATE NEW TERMINATION POINT FOR AMERICAN AIRLINE'S 4-STRAND OM3 FIBER OPTIC CABLING IN FIELD WITH AMERICAN AIRLINES IT. THIS CABLING IS EXISTING AND TERMINATES IN A114. THIS CABLING SHOULD BE TERMINATED IN THE TENANT'S RACK IN TELCO (B129). THIS CABLING SHALL BE CONSIDERED PART OF THE SCOPE OF THE PART 2 PROJECT.

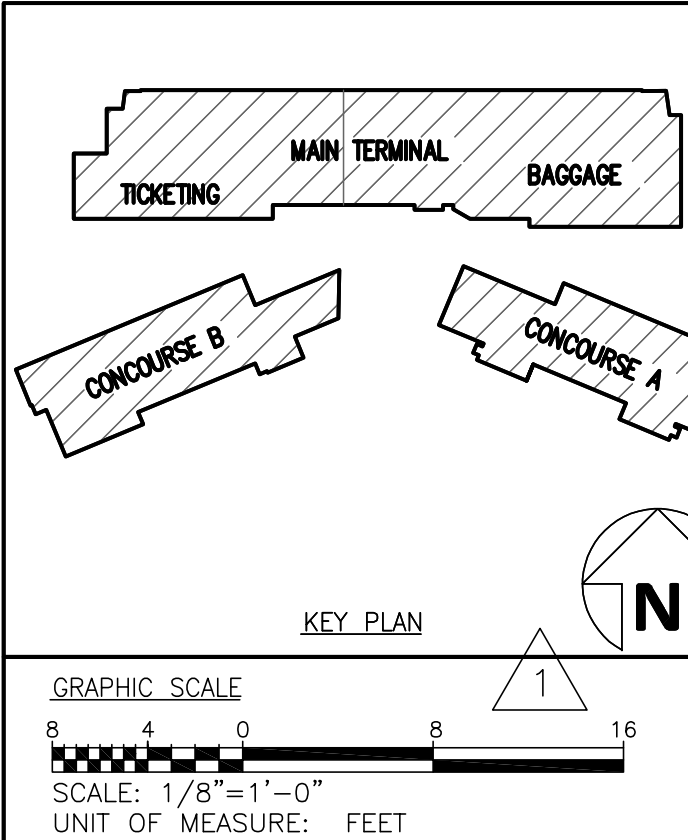

SHEET ADDED

Fayetteville Regional Airport — Airline Terminal Improvements Part 2

DRAWN BY: JMT
REVIEWED BY: JMT
DATE: 07-18-18
PROJECT NO.: 1808

REVISIONS
A RE 7 08/10/20
A RE 20 05/28/21


SHEET NUMBER

TN1.01D

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SECOND FLOOR PLAN – AREA A – TELECOMMUNICATIONS


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GENERAL SHEET NOTES

- COORDINATE DEVICE MOUNTING HEIGHTS FOR MILLWORK AND FURNITURE WITH ARCHITECTURAL DRAWINGS.
- DETERMINE BEST PATHWAY FOR FIBER AND COPPER BACKBONE CABLING FROM SERVER (G124A) IN FIELD, PER GC.
- DISTRIBUTE ALL SECOND FLOOR LOW VOLTAGE CABLING FROM SERVER (G124A), UON.

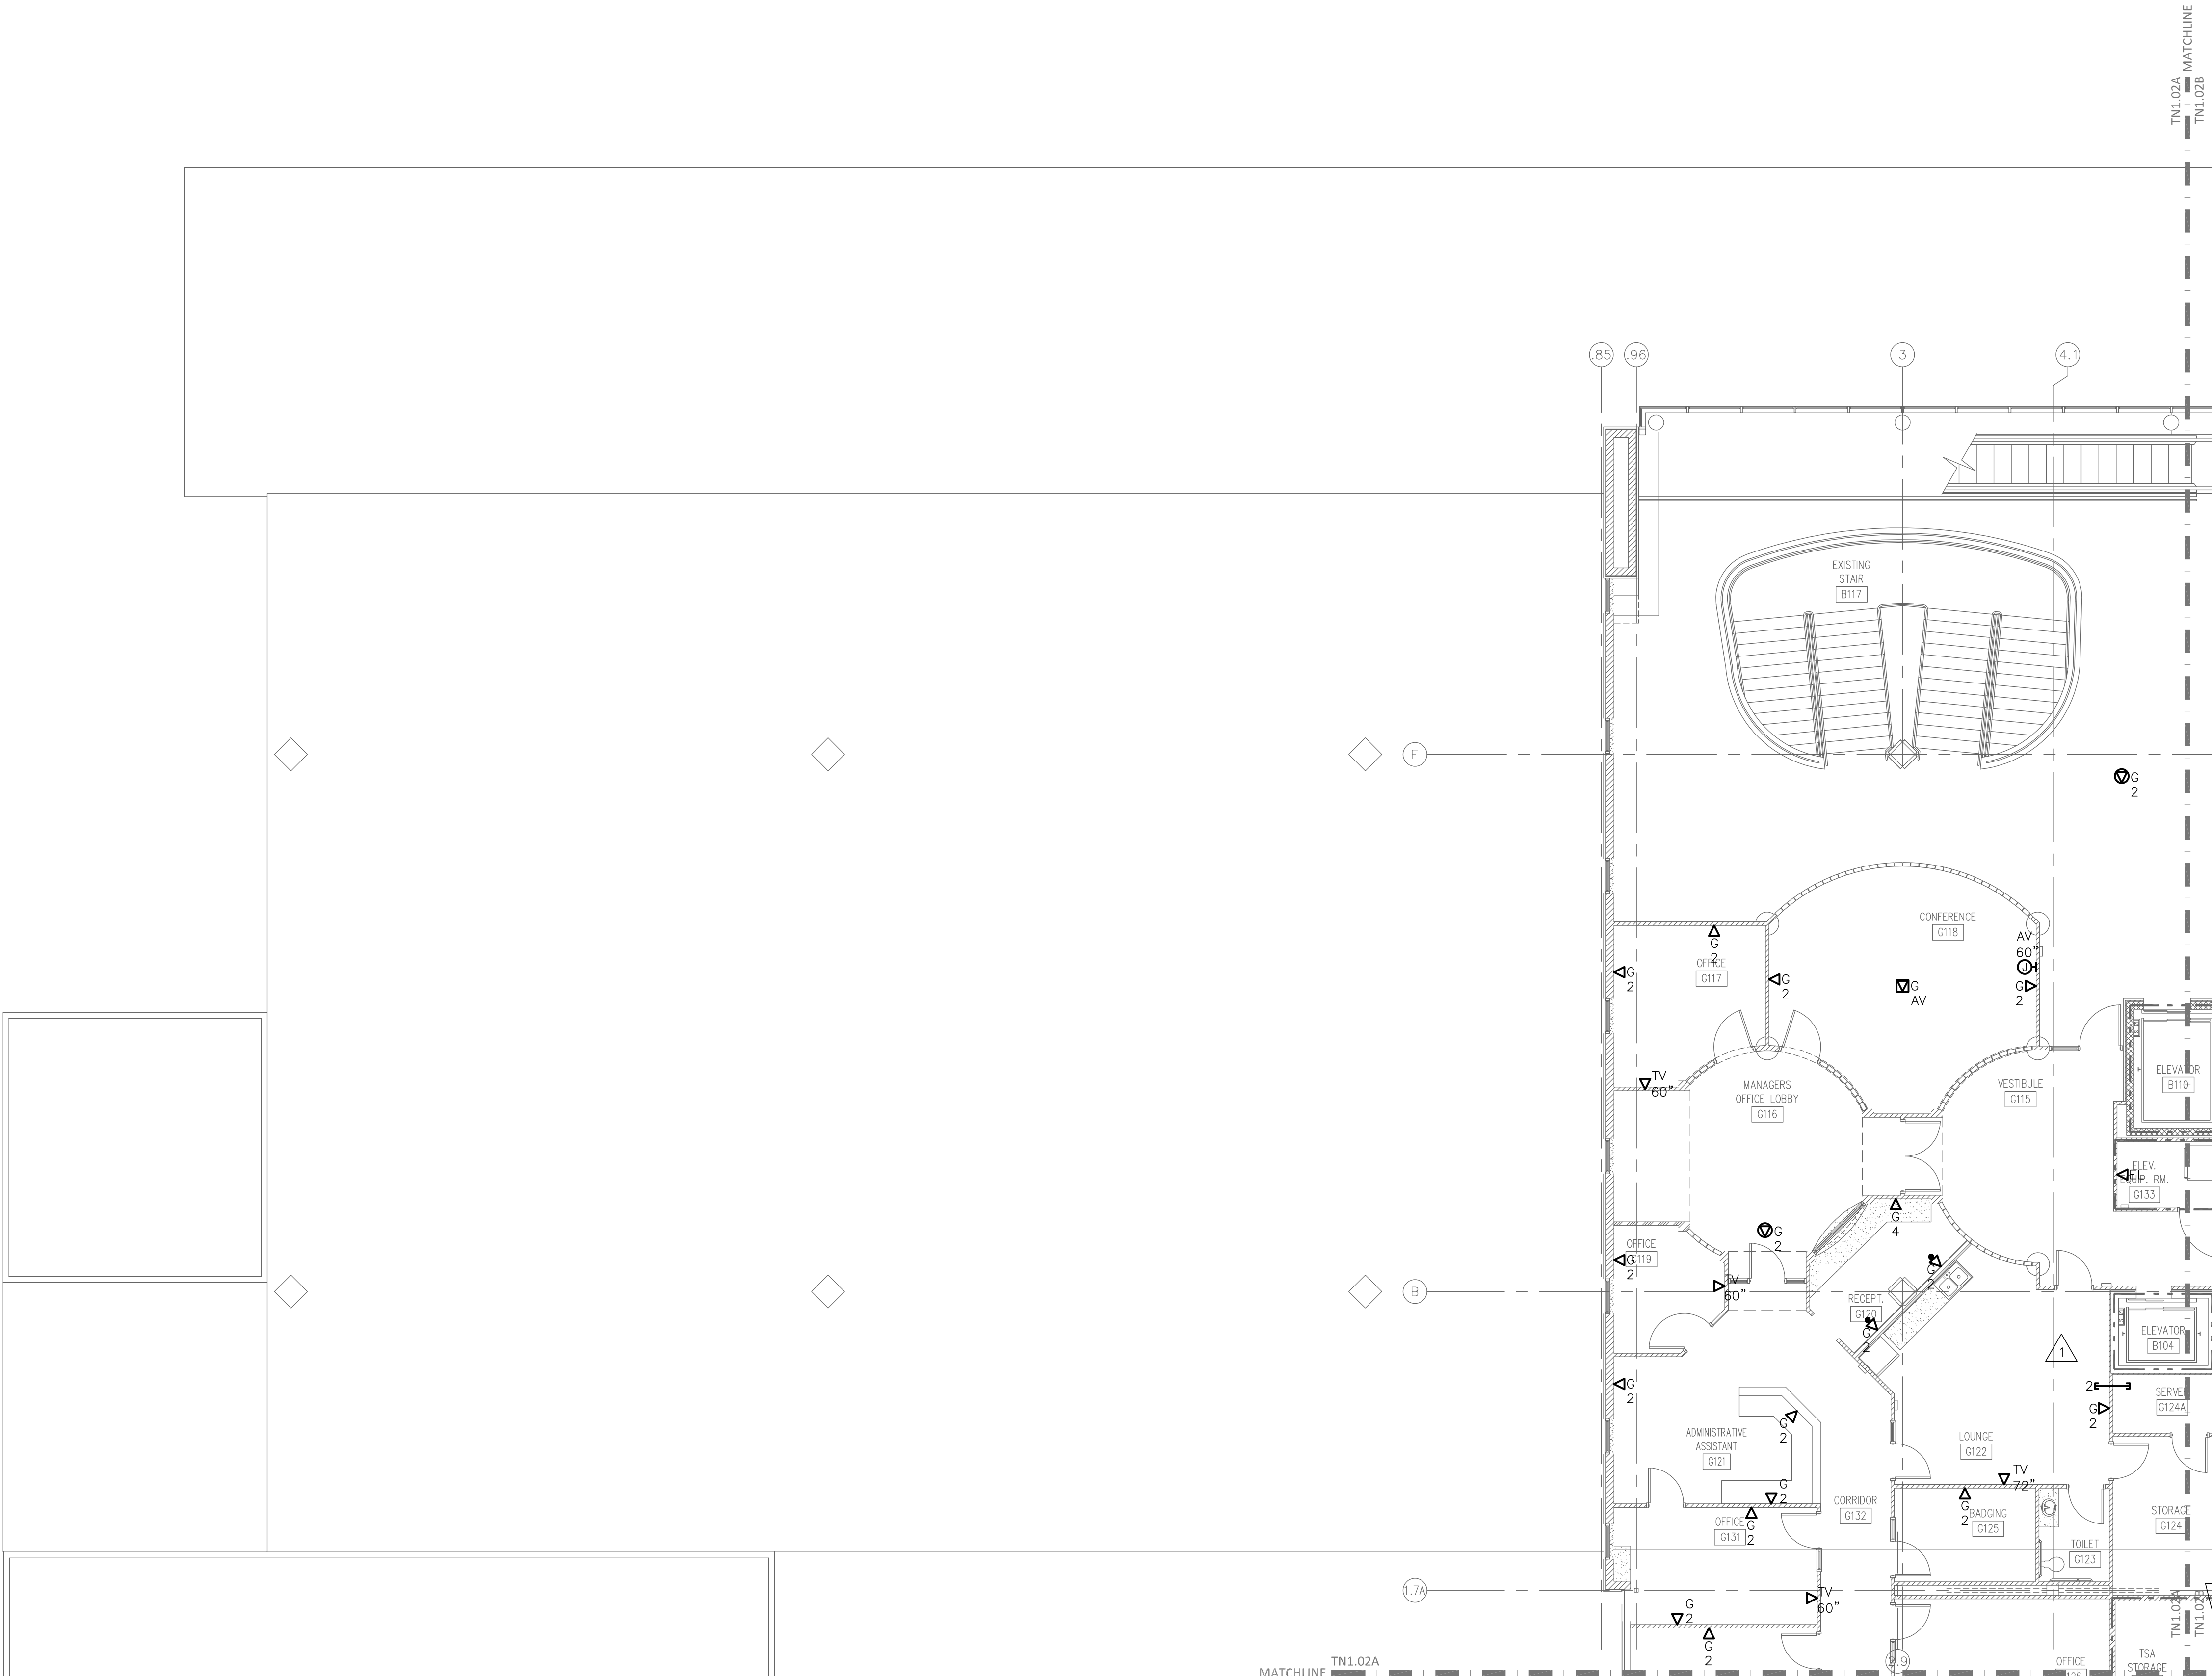

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RMF Project No: 2153223.F0

Fayetteville Regional Airport – Airline Terminal Improvements Part 2

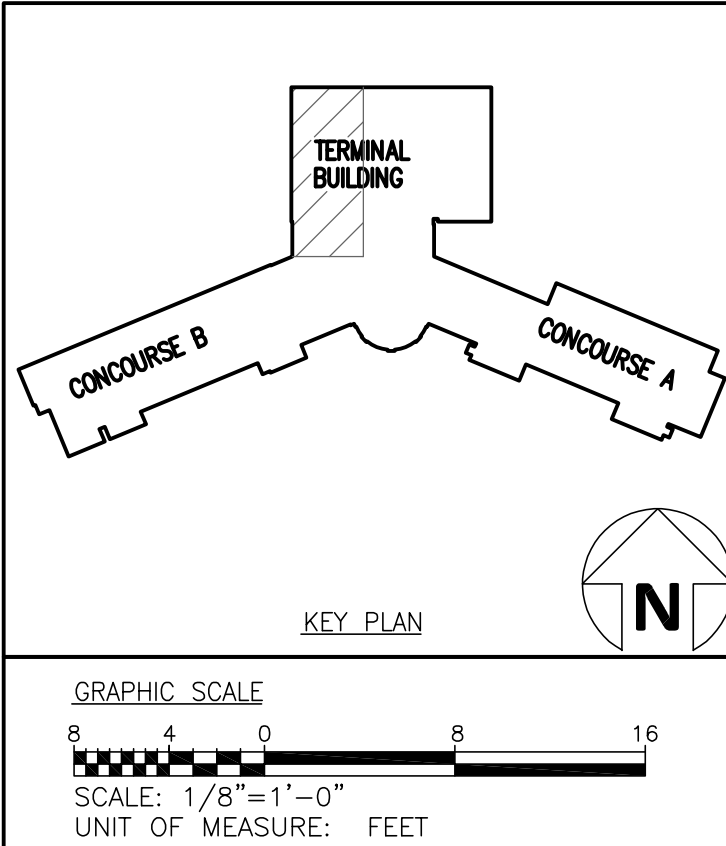SECOND FLOOR PLAN – AREA A – TELECOMMUNICATIONS


400 Airport Road
Fayetteville, North Carolina 28306

DRAWN BY: JMT
REVIEWED BY: JMT
DATE: 07-18-19
PROJECT NO.: 1808


REVISIONS
REV 17 04/16/21
REV 18 04/28/21

SHEET NUMBER

TN1.02A

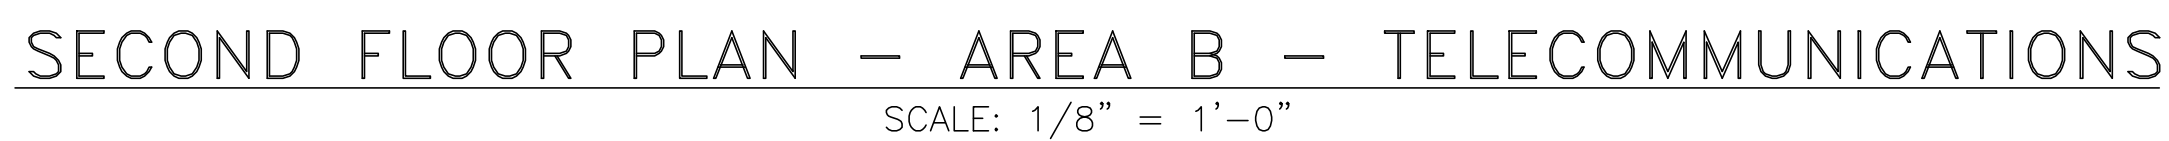

- ① COORDINATE DATA OUTLET CABLING IN FIELD WITH TSA IT. ROUTE (2) CAT6 CABLES FROM "B" DATA OUTLET TO "C" DATA OUTLET.
- ② ROUTE CAT3 COPPER CABLING FROM TSA CABINET IN TELCO ROOM B129 TO THIS OUTLET. THIS IS A POTS PHONE LINE.

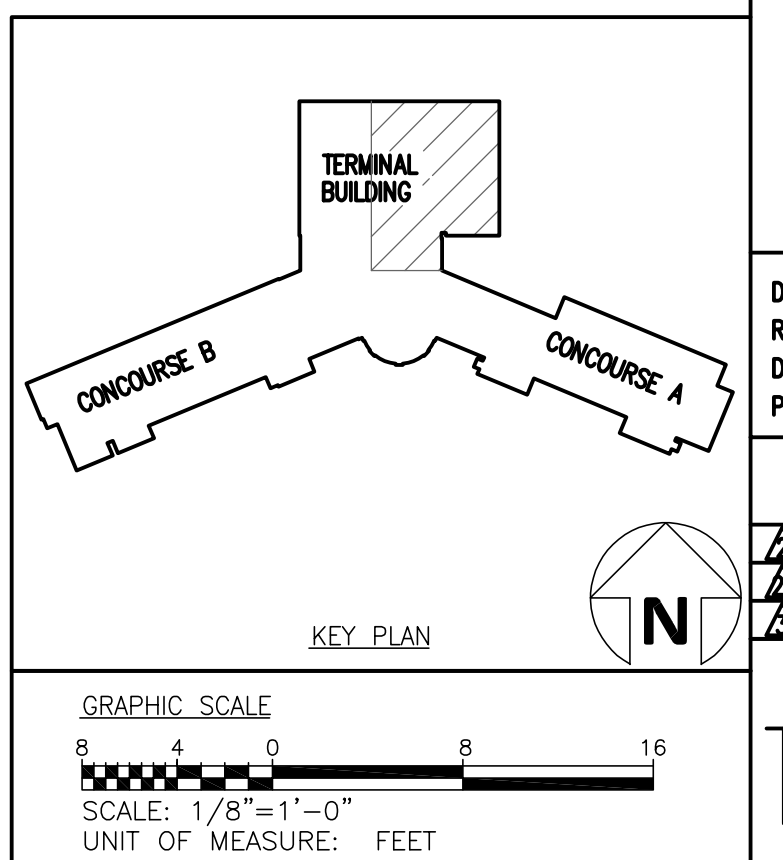

TN1.02B



SECOND FLOOR PLAN — AREA C — TELECOMMUNICATIONS
SCALE: 1/8" = 1'-0"

GENERAL NEW WORK NOTES


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GENERAL SHEET NOTES

- COORDINATE DEVICE MOUNTING HEIGHTS FOR MILLWORK AND FURNITURE WITH ARCHITECTURAL DRAWINGS.
- REROUTE EXISTING CABLING TO EXISTING TELECOMMUNICATIONS RACK TO TELECOMMUNICATIONS RACK IN ROOM D127.
- NEW TSA TELECOMMUNICATIONS CABINETS ARE LOCATED IN TELCO ROOM B129. ROUTE ALL TSA CABLING TO TSA TELECOMMUNICATIONS CABINETS IN TELCO ROOM B129 AND TERMINATE IN APPROPRIATE PATCH PANELS.
- ROUTE NEW CABLING TELECOMMUNICATIONS RACK IN TELCO ROOM D127, UON.
- ROUTE ALL NEW CABLING FOR G126, G127, G128, G129, AND G130 TO SERVER (G124A).

DRAWING NOTES

- ROUTE CABLING TO TELCO ROOM H109, COORDINATE TERMINATION METHOD IN FIELD WITH AMERICAN AIRLINES IT.
- COORDINATE DATA OUTLET CABLING IN FIELD WITH TSA IT. ROUTE (2) CAT6 CABLES FROM "C" DATA OUTLET TO "B" DATA OUTLET.

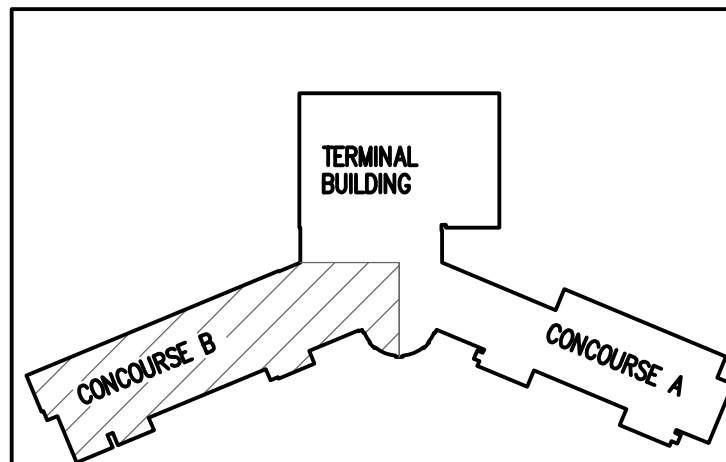

REVISIONS		
4	CBE-18	04/28/21
5	CBE-20	05/28/21
6	CBE-21	06/09/21
7	CBE-26	01/28/22

GRAPHIC SCALE
SCALE: 1/8" = 1'-0"
UNIT OF MEASURE: FEET

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SECOND FLOOR PLAN — AREA C — TELECOMMUNICATIONS

Fayetteville Regional Airport — Airline Terminal Improvements Part 2


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Fayetteville, North Carolina 28306

DRAWN BY: JMT
REVIEWED BY: JMT
DATE: 07-18-19
PROJECT NO.: 1808


REVISIONS
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6 CBE-21 06/09/21
7 CBE-26 01/28/22

SHEET NUMBER

TN1.02C

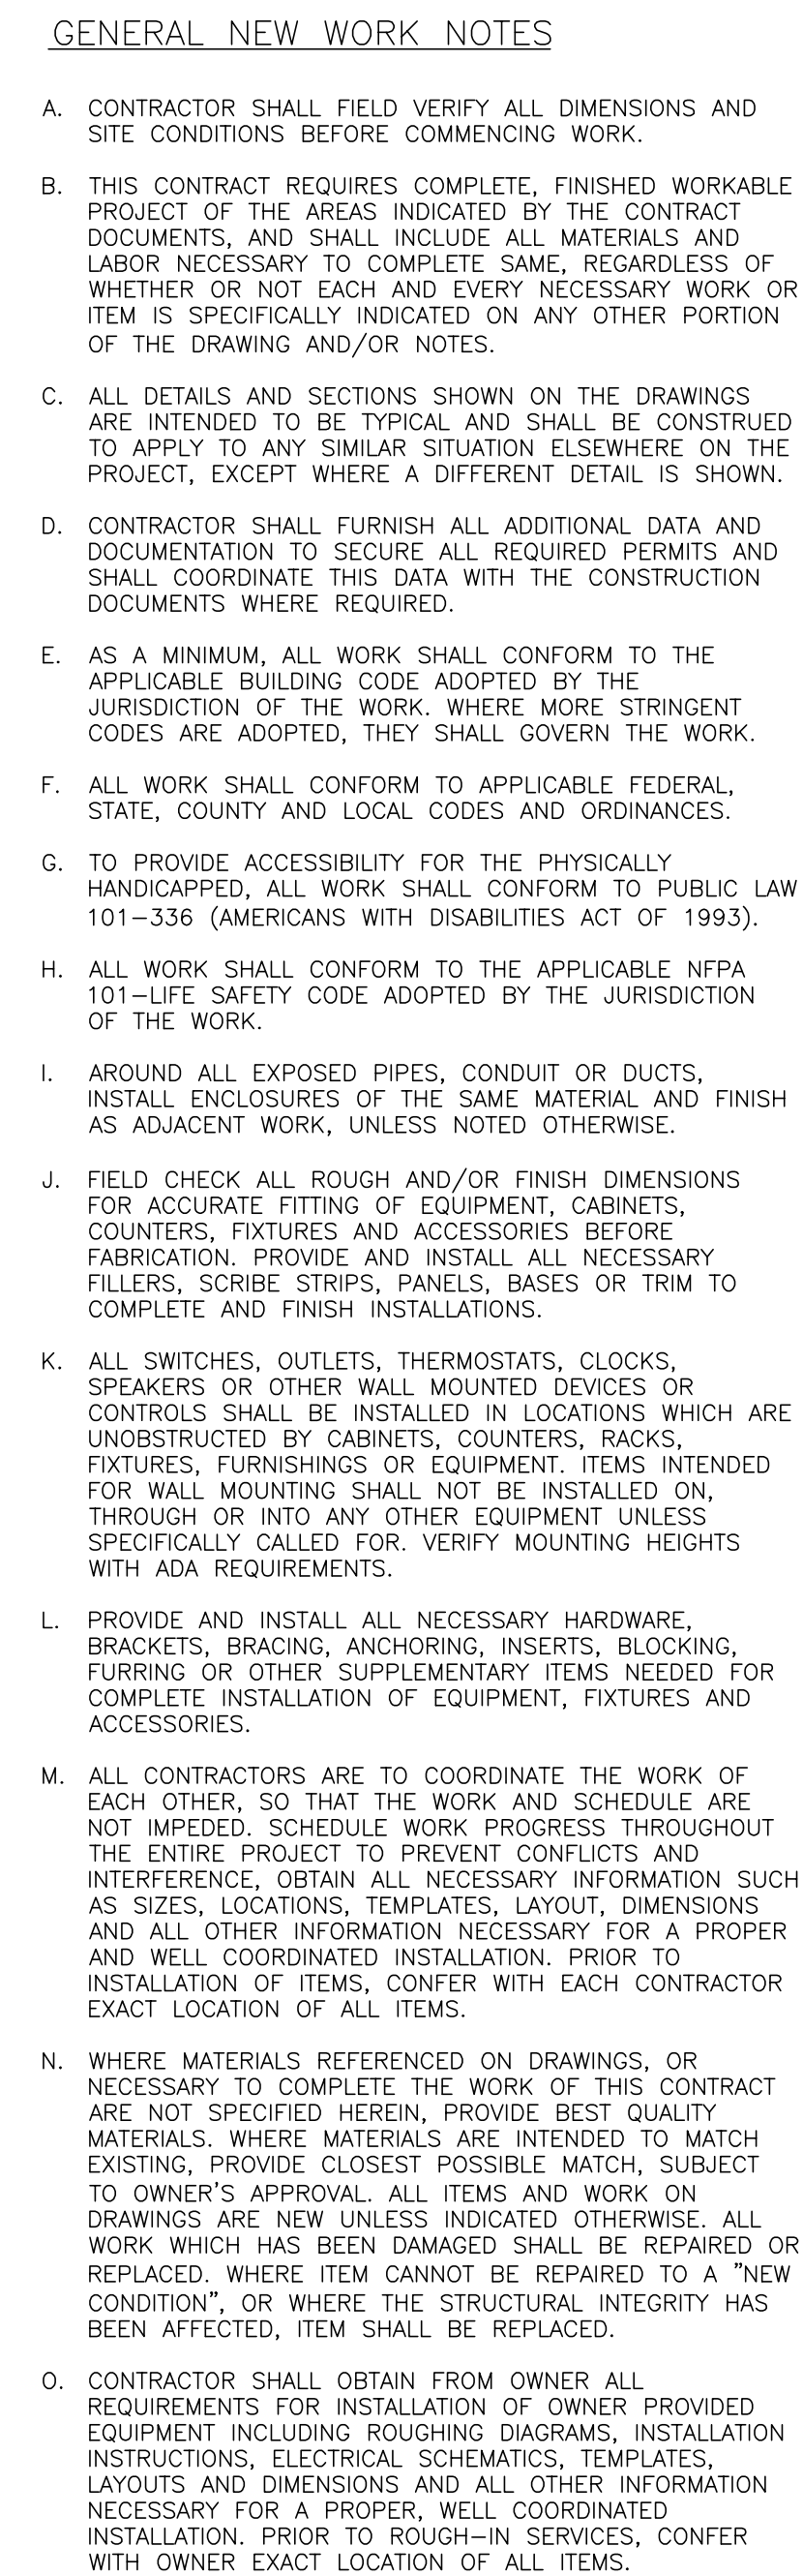


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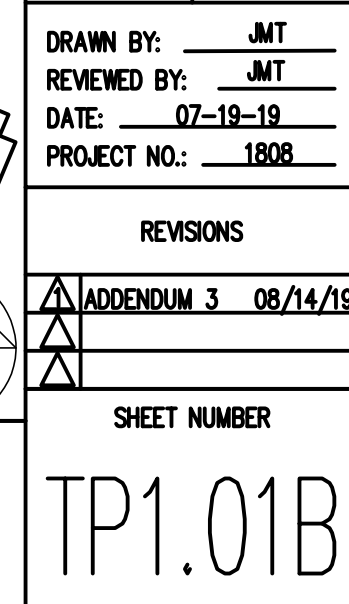
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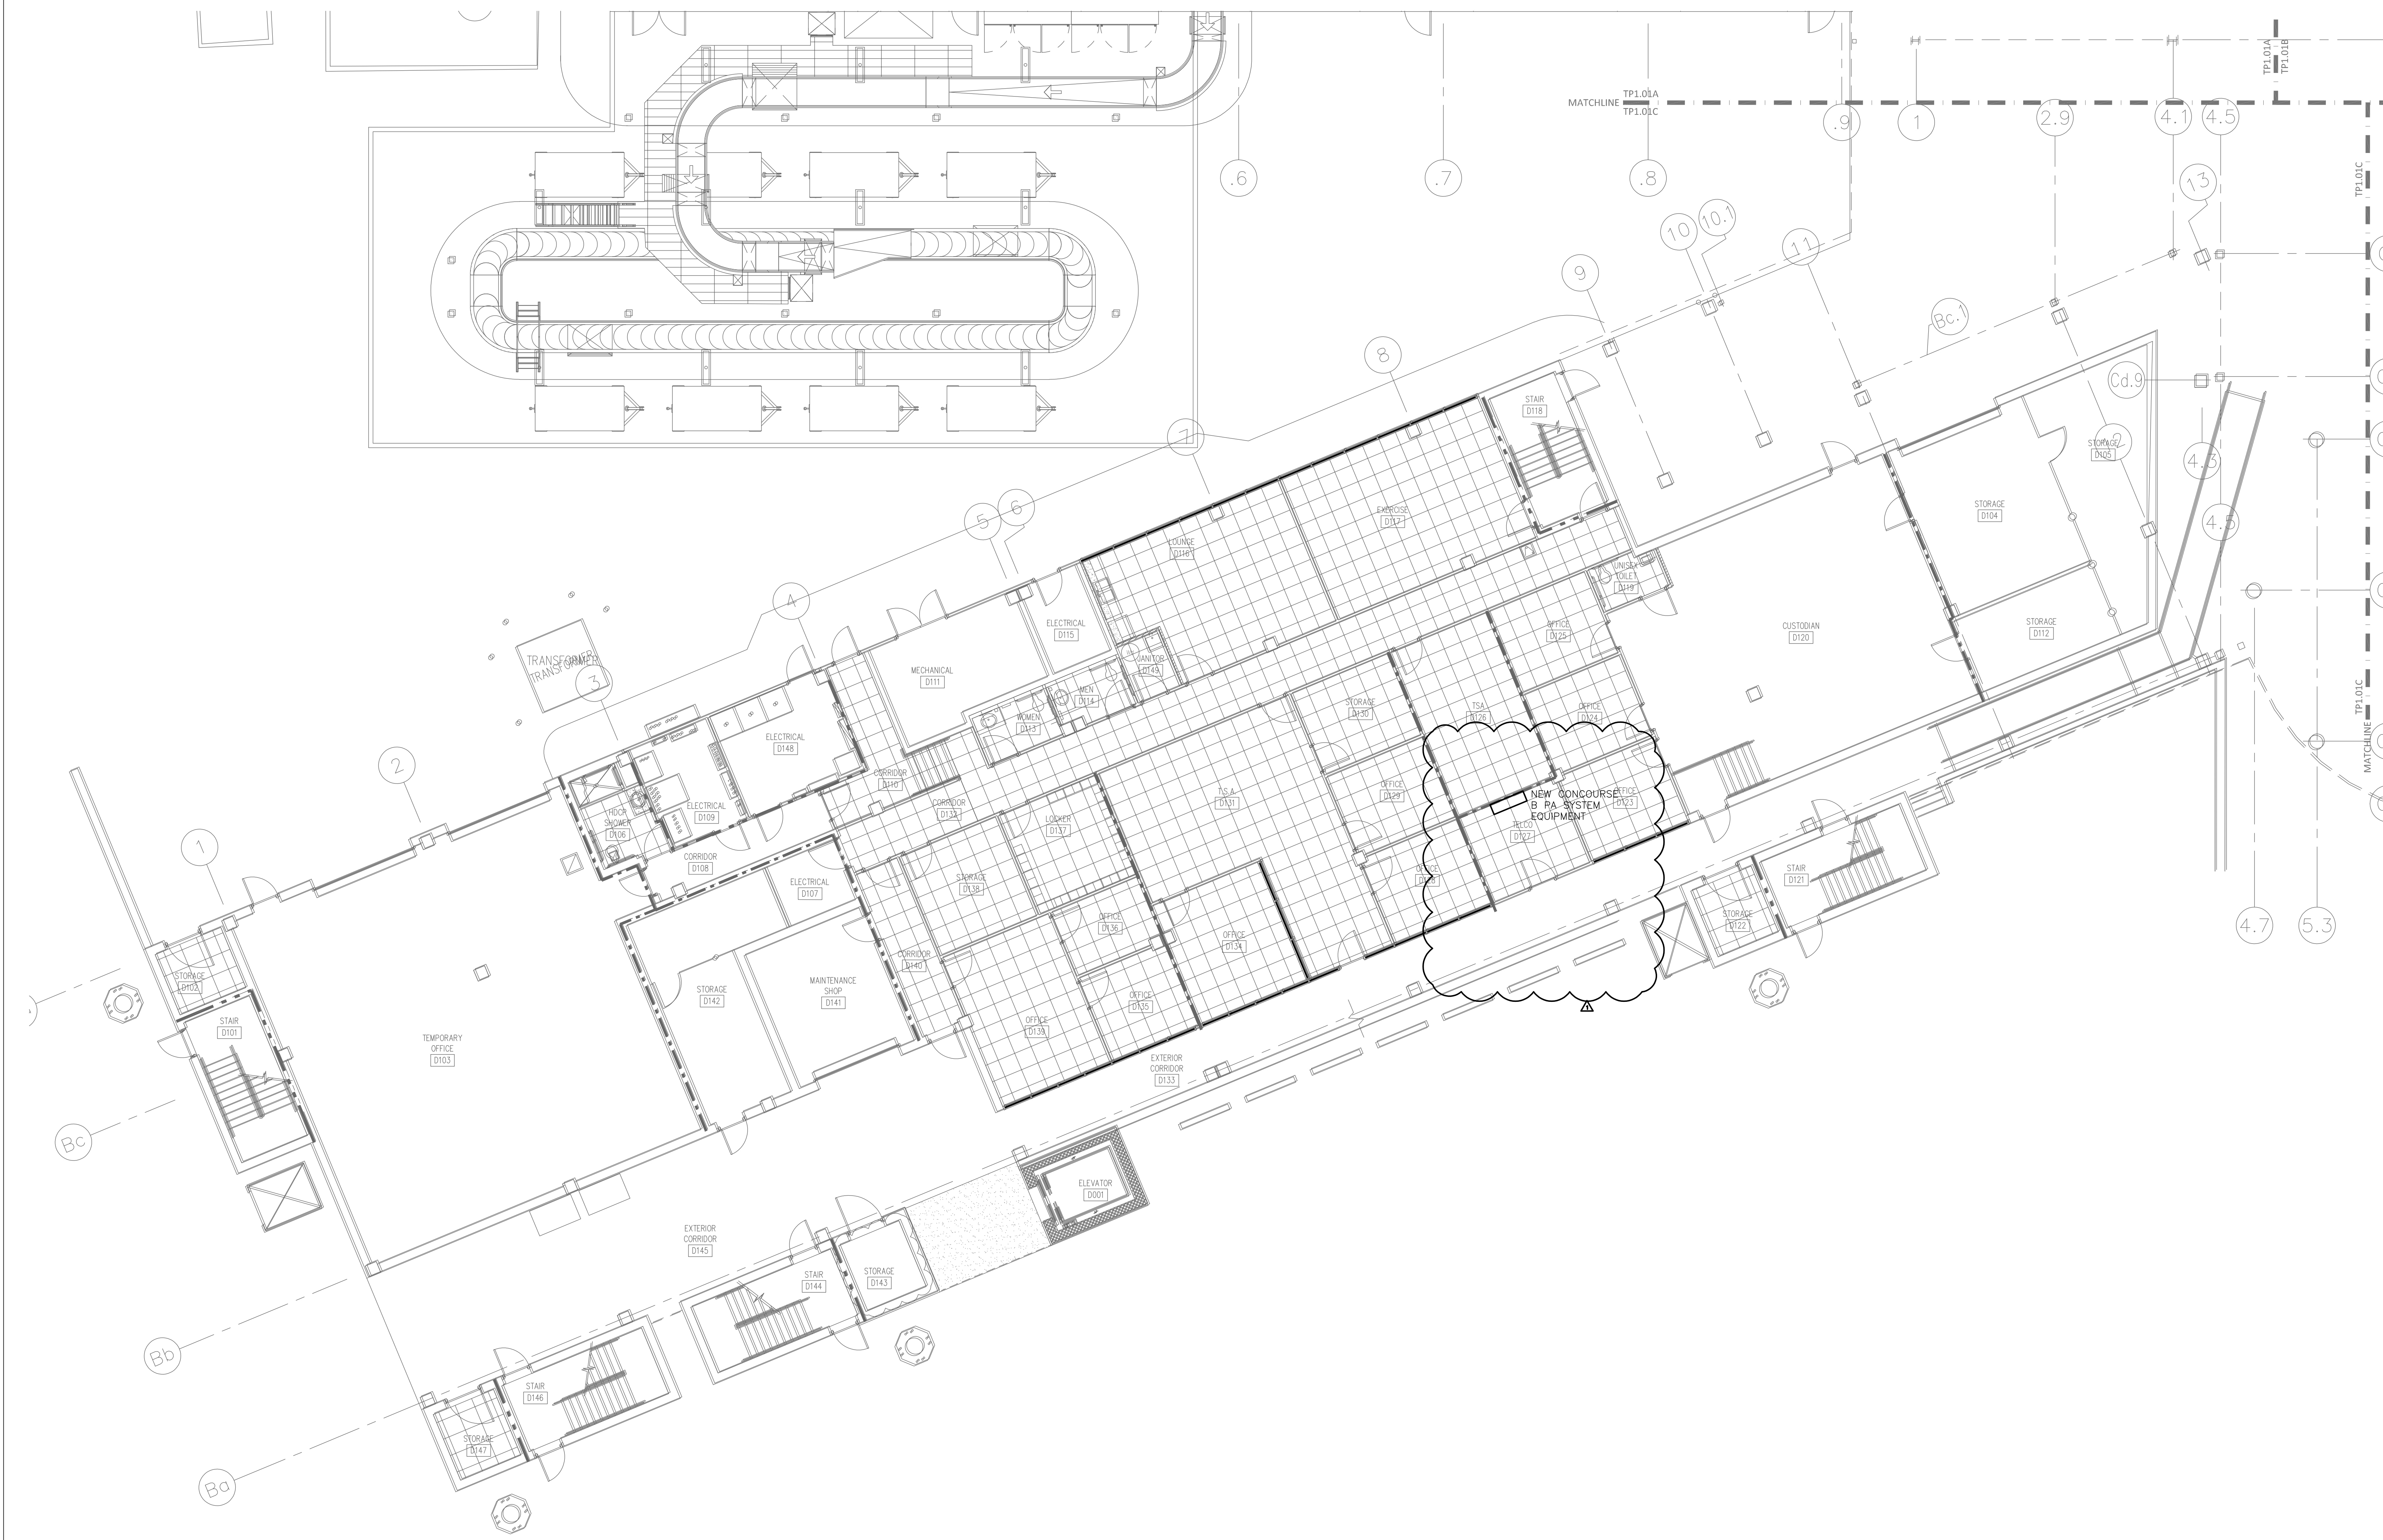
1	SHEET NUMBER
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GENERAL SHEET NOTES

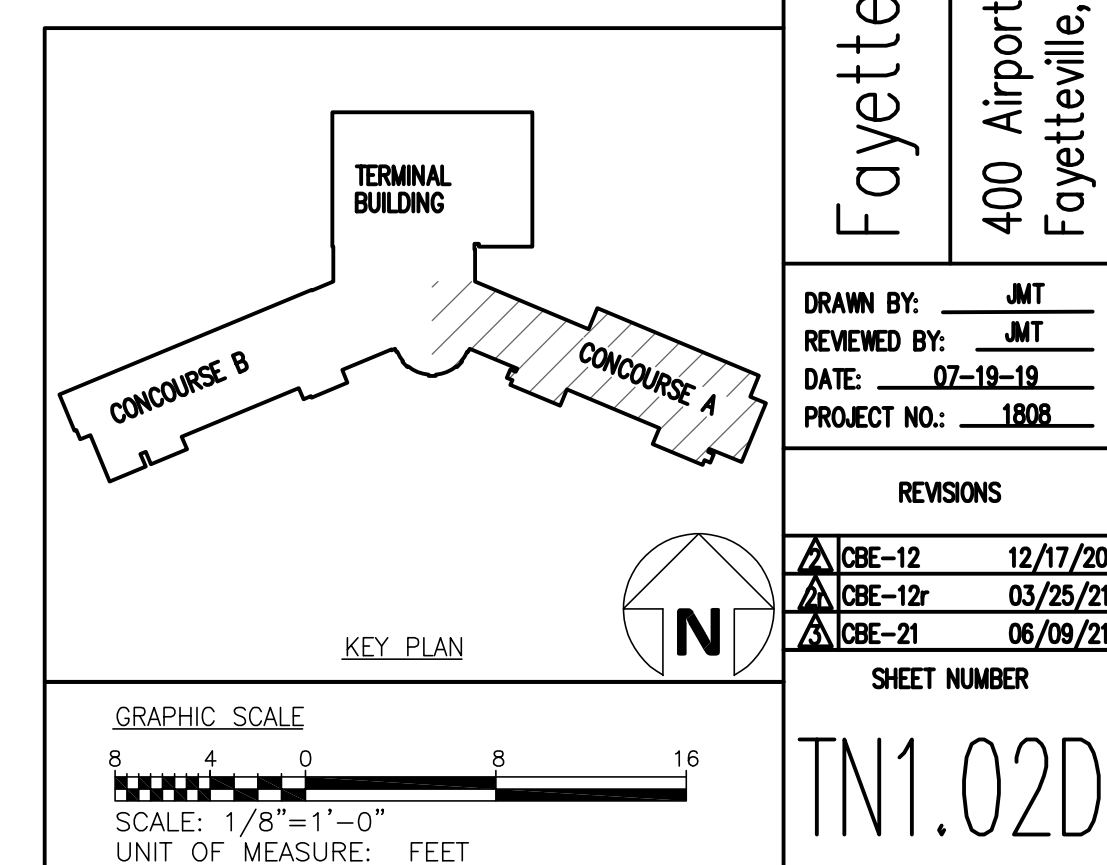1. COORDINATE DEVICE MOUNTING HEIGHTS FOR MILLWORK AND FURNITURE WITH ARCHITECTURAL DRAWINGS.





FIRST FLOOR PLAN - AREA C - PUBLIC ADDRESS
SCALE: 1/8" = 1'-0"
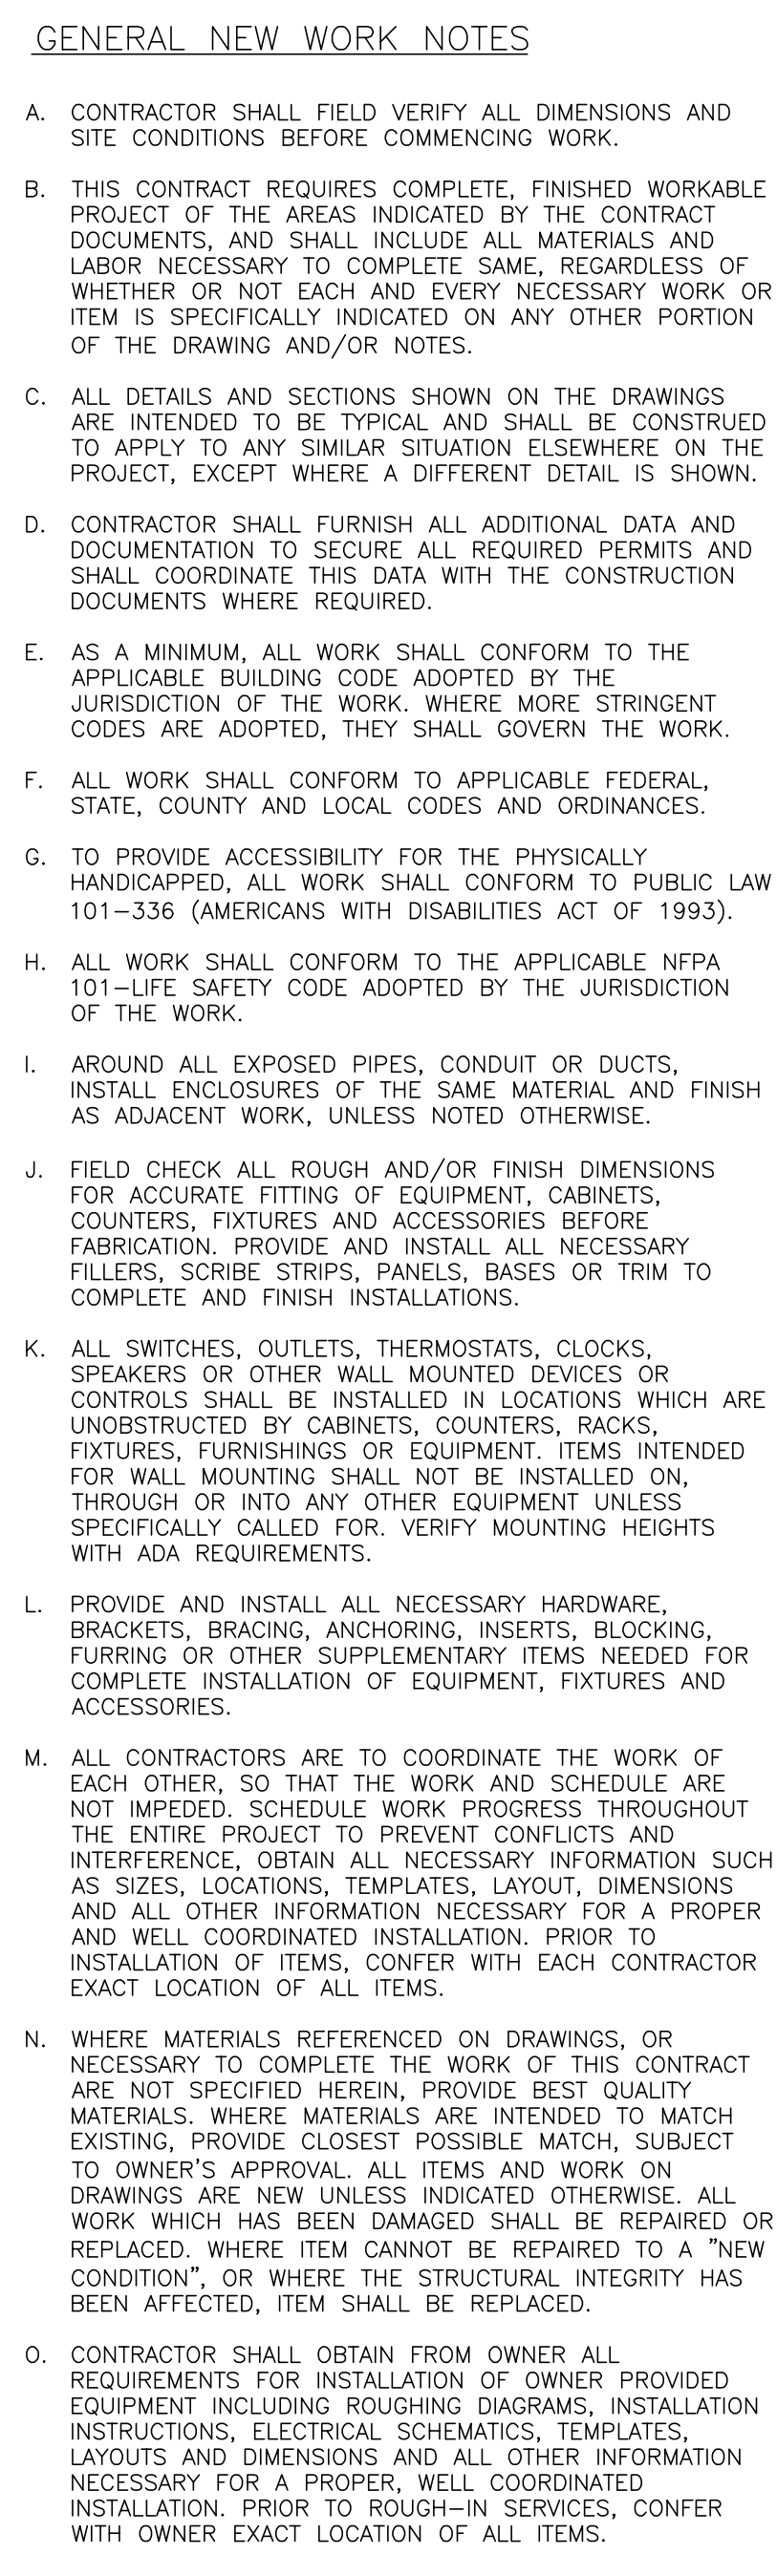
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GENERAL SHEET NOTES

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FIRE RATED WALL LEGEND

1 HOUR FIRE PARTITION
1 HOUR FIRE BARRIER

MAIN TERMINAL

TICKETING BAGGAGE

CONCOURSE B CONCOURSE A

KEY PLAN

GRAPHIC SCALE

SCALE: 1/8" = 1'-0"

UNIT OF MEASURE: FEET

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Fayetteville Regional Airport - Airline Terminal Improvements Part 2

FIRST FLOOR PLAN - AREA C - PUBLIC ADDRESS

400 Airport Road
Fayetteville, North Carolina 28306


DRAWN BY: JMT
REVIEWED BY: JMT
DATE: 07-18-19
PROJECT NO.: 1808

REVISIONS

MODIFICATION 3 08/14/19

SHEET NUMBER

TP1.01C

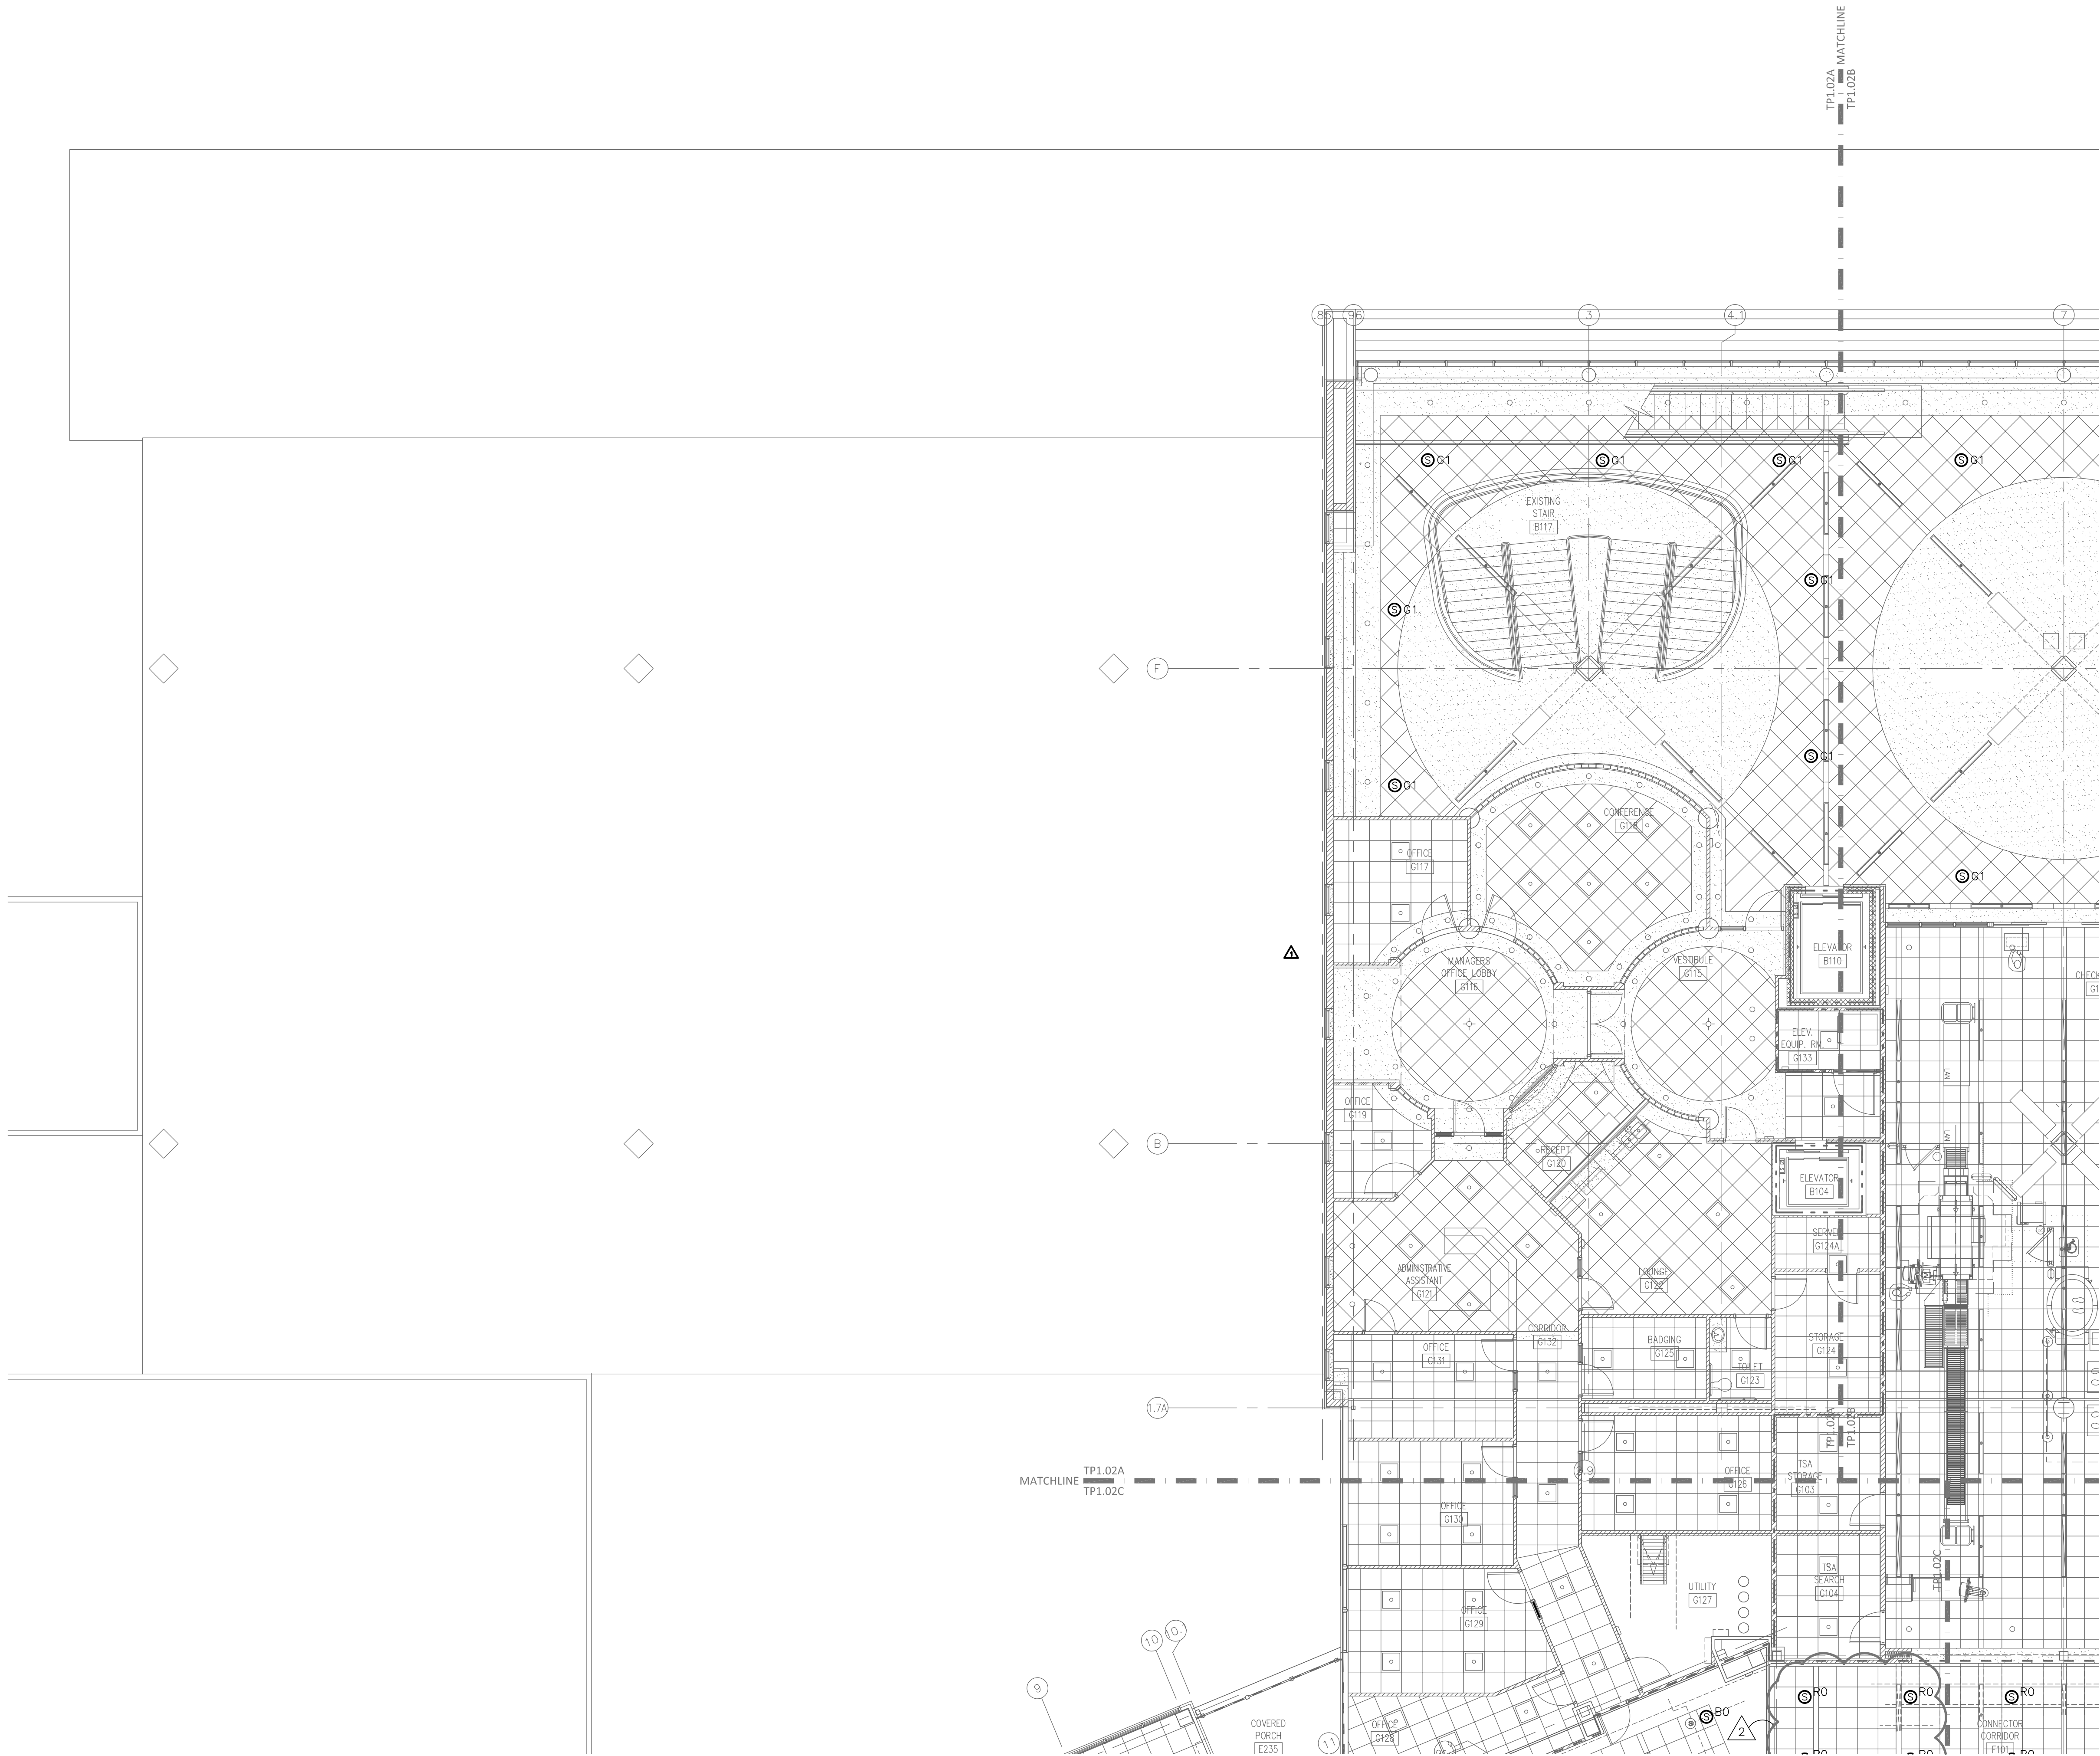


SECOND FLOOR PLAN – AREA A – PUBLIC ADDRESS
SCALE: 1/8" = 1'-0"

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GENERAL SHEET NOTES

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Fayetteville Regional Airport – Airline Terminal Improvements Part 2

SECOND FLOOR PLAN – AREA A – PUBLIC ADDRESS

400 Airport Road
Fayetteville, North Carolina 28306

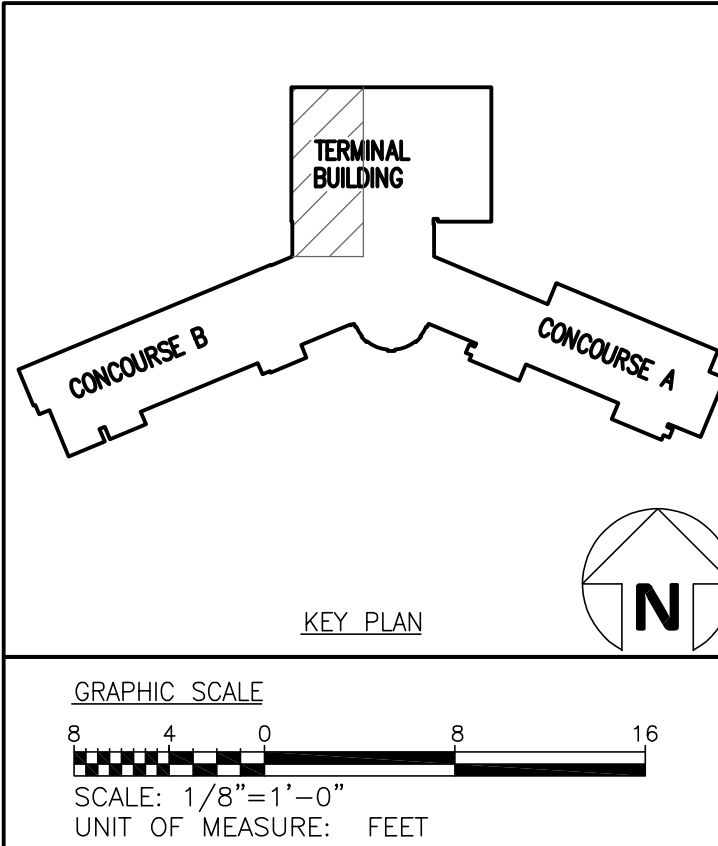DRAWN BY: JMT
REVIEWED BY: JMT
DATE: 07-18-19
PROJECT NO.: 1808

REVISIONS

NO. DESCRIPTION DATE

1. MODIFIED 08/14/19

2. MODIFIED 08/14/19

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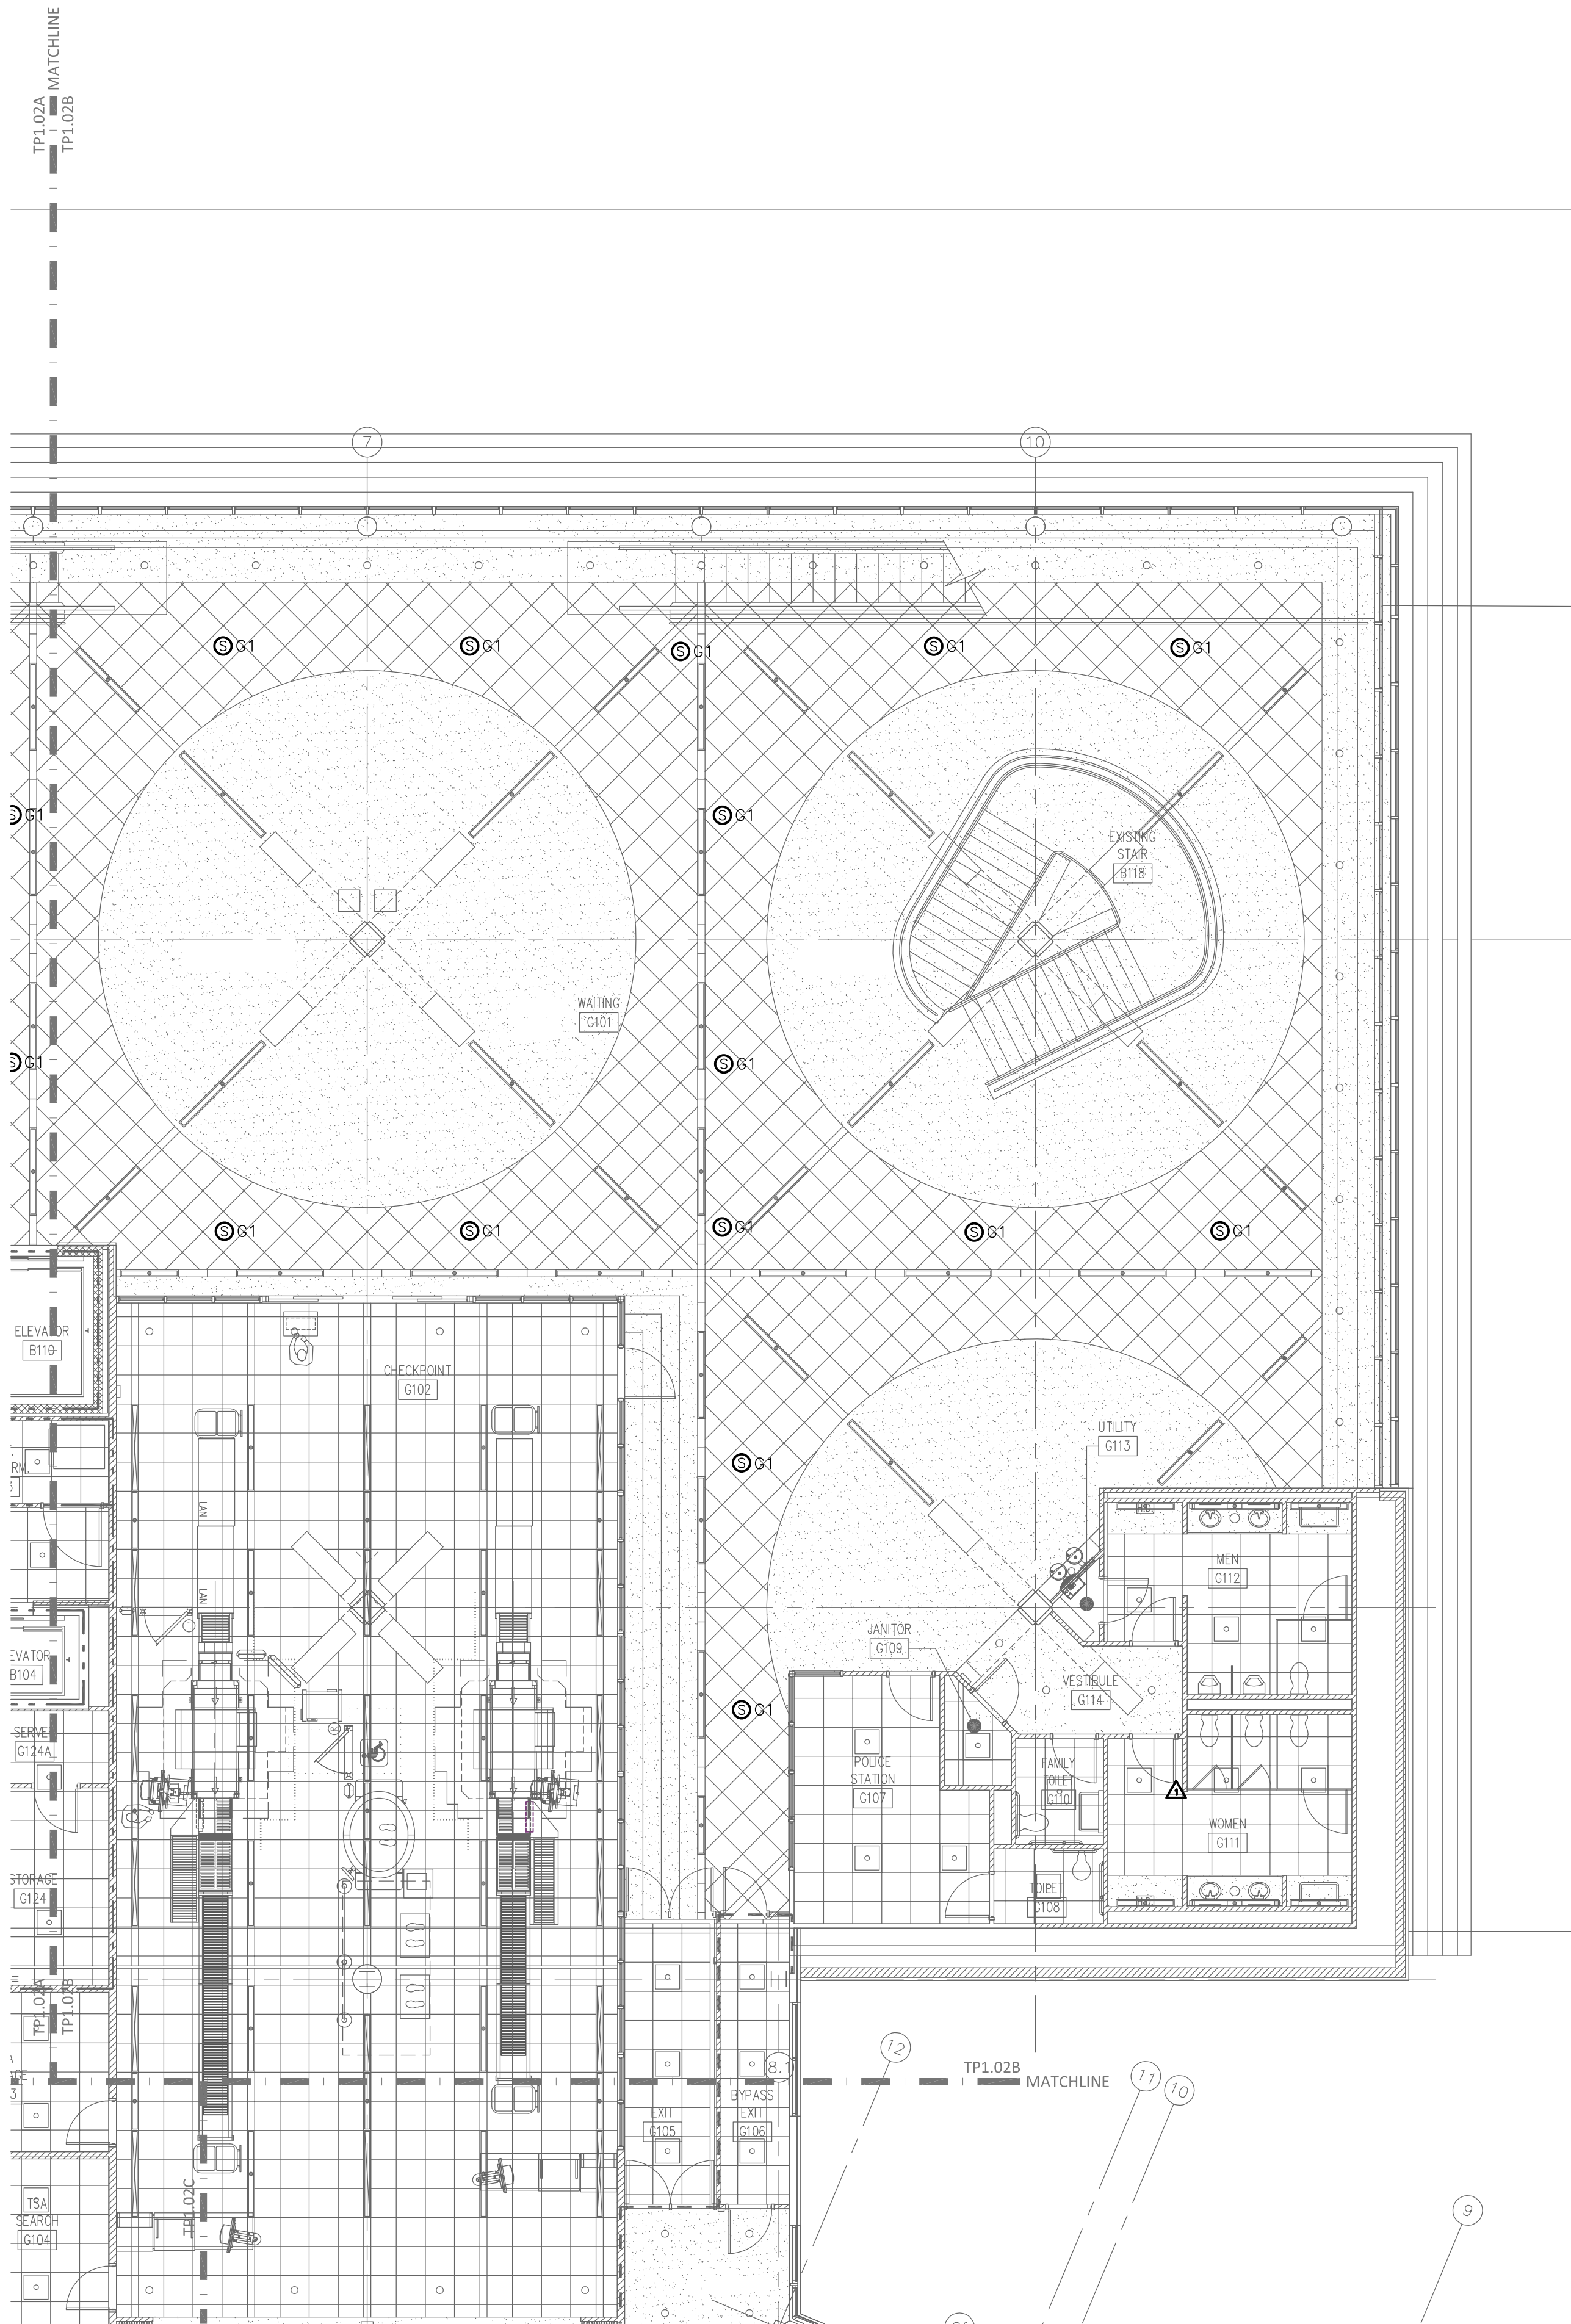
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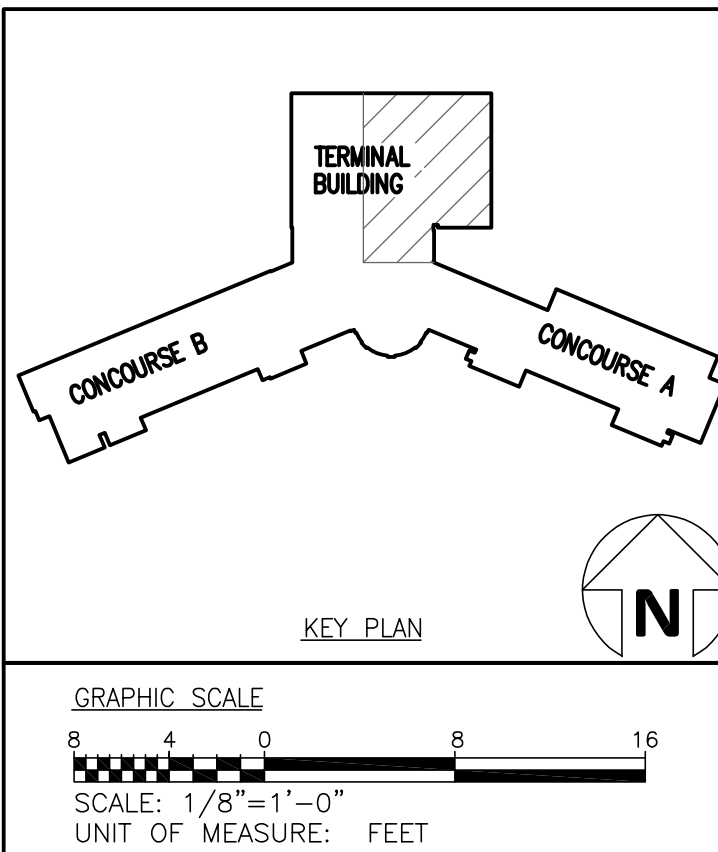
SECOND FLOOR PLAN – AREA B – PUBLIC ADDRESS
SCALE: 1/8" = 1'-0"

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Fayetteville Regional Airport – Airline Terminal Improvements Part 2
SECOND FLOOR PLAN – AREA B – PUBLIC ADDRESS
400 Airport Road
Fayetteville, North Carolina 28306

DRAWN BY: JMT
REVIEWED BY: JMT
DATE: 07-18-19
PROJECT NO.: 1808

REVISIONS

NO. DESCRIPTION DATE

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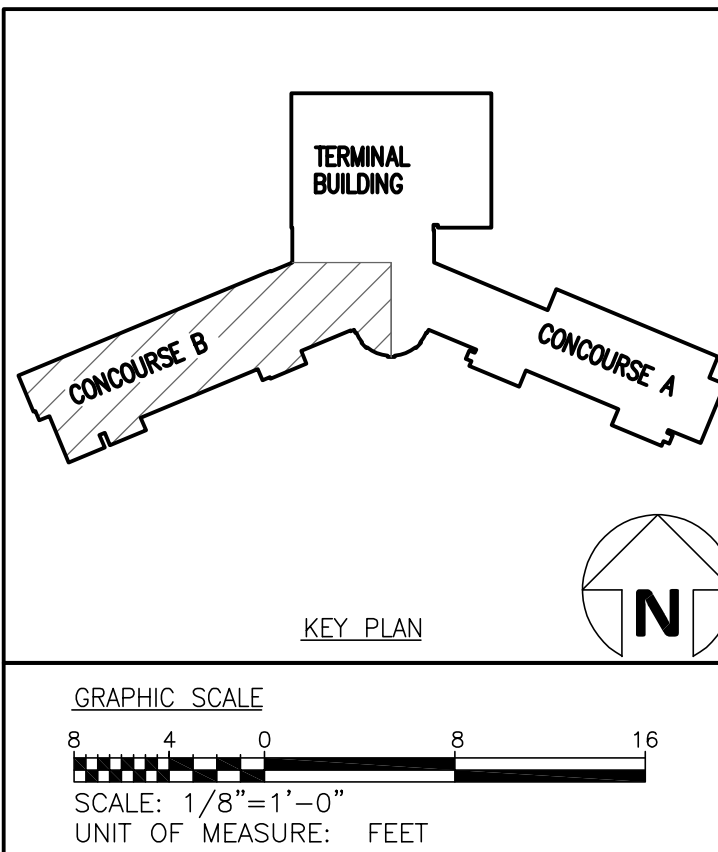
SECOND FLOOR PLAN — AREA C — PUBLIC ADDRESS
SCALE: 1/8" = 1'-0"

GENERAL NEW WORK NOTES

- CONTRACTOR SHALL FIELD VERIFY ALL DIMENSIONS AND SITE CONDITIONS BEFORE COMMENCING WORK.
- THIS CONTRACT REQUIRES COMPLETE, FINISHED WORKABLE PROJECT OF THE AREAS INDICATED BY THE CONTRACT DOCUMENTS, AND SHALL INCLUDE ALL MATERIALS AND LABOR NECESSARY TO COMPLETE SAME, REGARDLESS OF WHETHER OR NOT EACH AND EVERY NECESSARY WORK OR ITEM IS SPECIFICALLY INDICATED ON ANY OTHER PORTION OF THE DRAWING AND/OR NOTES.
- ALL DETAILS AND SECTIONS SHOWN ON THE DRAWINGS ARE INTENDED TO BE TYPICAL AND SHALL BE CONSTRUED TO APPLY TO ANY SIMILAR SITUATION ELSEWHERE ON THE PROJECT, EXCEPT WHERE A DIFFERENT DETAIL IS SHOWN.
- CONTRACTOR SHALL FURNISH ALL ADDITIONAL DATA AND DOCUMENTATION TO SECURE ALL REQUIRED PERMITS AND SHALL COORDINATE THIS DATA WITH THE CONSTRUCTION DOCUMENTS WHERE REQUIRED.
- AS A MINIMUM, ALL WORK SHALL CONFORM TO THE APPLICABLE BUILDING CODE ADOPTED BY THE JURISDICTION OF THE WORK, WHERE MORE STRINGENT CODES ARE ADOPTED, THEY SHALL GOVERN THE WORK.
- ALL WORK SHALL CONFORM TO APPLICABLE FEDERAL, STATE, COUNTY AND LOCAL CODES AND ORDINANCES.
- TO PROVIDE ACCESSIBILITY FOR THE PHYSICALLY HANDICAPPED, ALL WORK SHALL CONFORM TO PUBLIC LAW 101-336 (AMERICANS WITH DISABILITIES ACT OF 1993).
- ALL WORK SHALL CONFORM TO THE APPLICABLE NFPA 101 LIFT SAFETY CODE ADOPTED BY THE JURISDICTION OF THE WORK.
- AROUND ALL EXPOSED PIPES, CONDUIT OR DUCTS, INSTALL ENCLOSURES OF THE SAME MATERIAL AND FINISH AS ADJACENT WORK, UNLESS NOTED OTHERWISE.
- FIELD CHECK ALL ROUGH AND/OR FINISH DIMENSIONS FOR ACCURATE FITTING OF EQUIPMENT, CABINETS, COUNTERS, FIXTURES AND ACCESSORIES BEFORE FABRICATION. PROVIDE AND INSTALL ALL NECESSARY FILLERS, SCRIBE STRIPS, PANELS, BASES OR TRIM TO COMPLETE AND FINISH INSTALLATIONS.
- ALL SWITCHES, OUTLETS, THERMOSTATS, CLOCKS, SPEAKERS OR OTHER WALL MOUNTED DEVICES OR CONTROLS SHALL BE INSTALLED IN LOCATIONS WHICH ARE UNOBSTRUCTED BY CABINETS, COUNTERS, RACKS, FIXTURES, FURNISHINGS OR EQUIPMENT. ITEMS INTENDED FOR WALL MOUNTING SHALL NOT BE INSTALLED ON, THROUGH OR INTO ANY OTHER EQUIPMENT UNLESS SPECIFICALLY CALLED FOR. VERIFY MOUNTING HEIGHTS WITH ADA REQUIREMENTS.
- PROVIDE AND INSTALL ALL NECESSARY HARDWARE, BRACKETS, BRACING, ANCHORING, INSERTS, BLOCKING, FURNISHING OR OTHER SUPPLEMENTARY ITEMS NEEDED FOR COMPLETE INSTALLATION OF EQUIPMENT, FIXTURES AND ACCESSORIES.
- ALL CONTRACTORS ARE TO COORDINATE THE WORK OF EACH OTHER, SO THAT THE WORK AND SCHEDULE ARE NOT IMPEDED, SCHEDULE WORK PROGRESS THROUGHOUT THE ENTIRE PROJECT TO PREVENT CONFLICTS AND INTERFERENCE. OBTAIN ALL NECESSARY INFORMATION SUCH AS SIZES, LOCATIONS, TEMPLATES, LAYOUT, DIMENSIONS AND ALL OTHER INFORMATION NECESSARY FOR A PROPER AND WELL COORDINATED INSTALLATION. PRIOR TO INSTALLATION OF ITEMS, CONFER WITH EACH CONTRACTOR EXACT LOCATION OF ALL ITEMS.
- WHERE MATERIALS REFERENCED ON DRAWINGS, OR NECESSARY TO COMPLETE THE WORK OF THIS CONTRACT ARE NOT SPECIFIED HEREIN, PROVIDE BEST QUALITY MATERIALS. WHERE MATERIALS ARE INTENDED TO MATCH EXISTING, PROVIDE CLOSEST POSSIBLE MATCH, SUBJECT TO OWNER'S APPROVAL. ALL ITEMS AND WORK ON DRAWINGS ARE NEW UNLESS INDICATED OTHERWISE. ALL WORK WHICH HAS BEEN DAMAGED SHALL BE REPAIRED OR REPLACED, WHERE ITEM CANNOT BE REPAIRED TO A "NEW CONDITION", OR WHERE THE STRUCTURAL INTEGRITY HAS BEEN AFFECTED, ITEM SHALL BE REPLACED.
- CONTRACTOR SHALL OBTAIN FROM OWNER ALL REQUIREMENTS FOR INSTALLATION OF OWNER PROVIDED EQUIPMENT INCLUDING ROUGHING DIAGRAMS, INSTALLATION INSTRUCTIONS, ELECTRICAL SCHEMATICS, TEMPLATES, LAYOUTS AND DIMENSIONS AND ALL OTHER INFORMATION NECESSARY FOR A PROPER, WELL COORDINATED INSTALLATION. PRIOR TO ROUGH-IN SERVICES, CONFER WITH OWNER EXACT LOCATION OF ALL ITEMS.

GENERAL SHEET NOTES

- COORDINATE DEVICE MOUNTING HEIGHTS FOR MILLWORK AND FURNITURE WITH ARCHITECTURAL DRAWINGS.



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RMF Project No: 215323.F0

Fayetteville Regional Airport — Airline Terminal Improvements Part 2

SECOND FLOOR PLAN — AREA C — PUBLIC ADDRESS


400 Airport Road
Fayetteville, North Carolina 28306

DRAWN BY: JMT
REVIEWED BY: JMT
DATE: 07-18-19
PROJECT NO.: 1808


REVISIONS
A. MODIFIED 3 08/14/19
B. PRE-14 02/10/21

SHEET NUMBER

TP1.02C

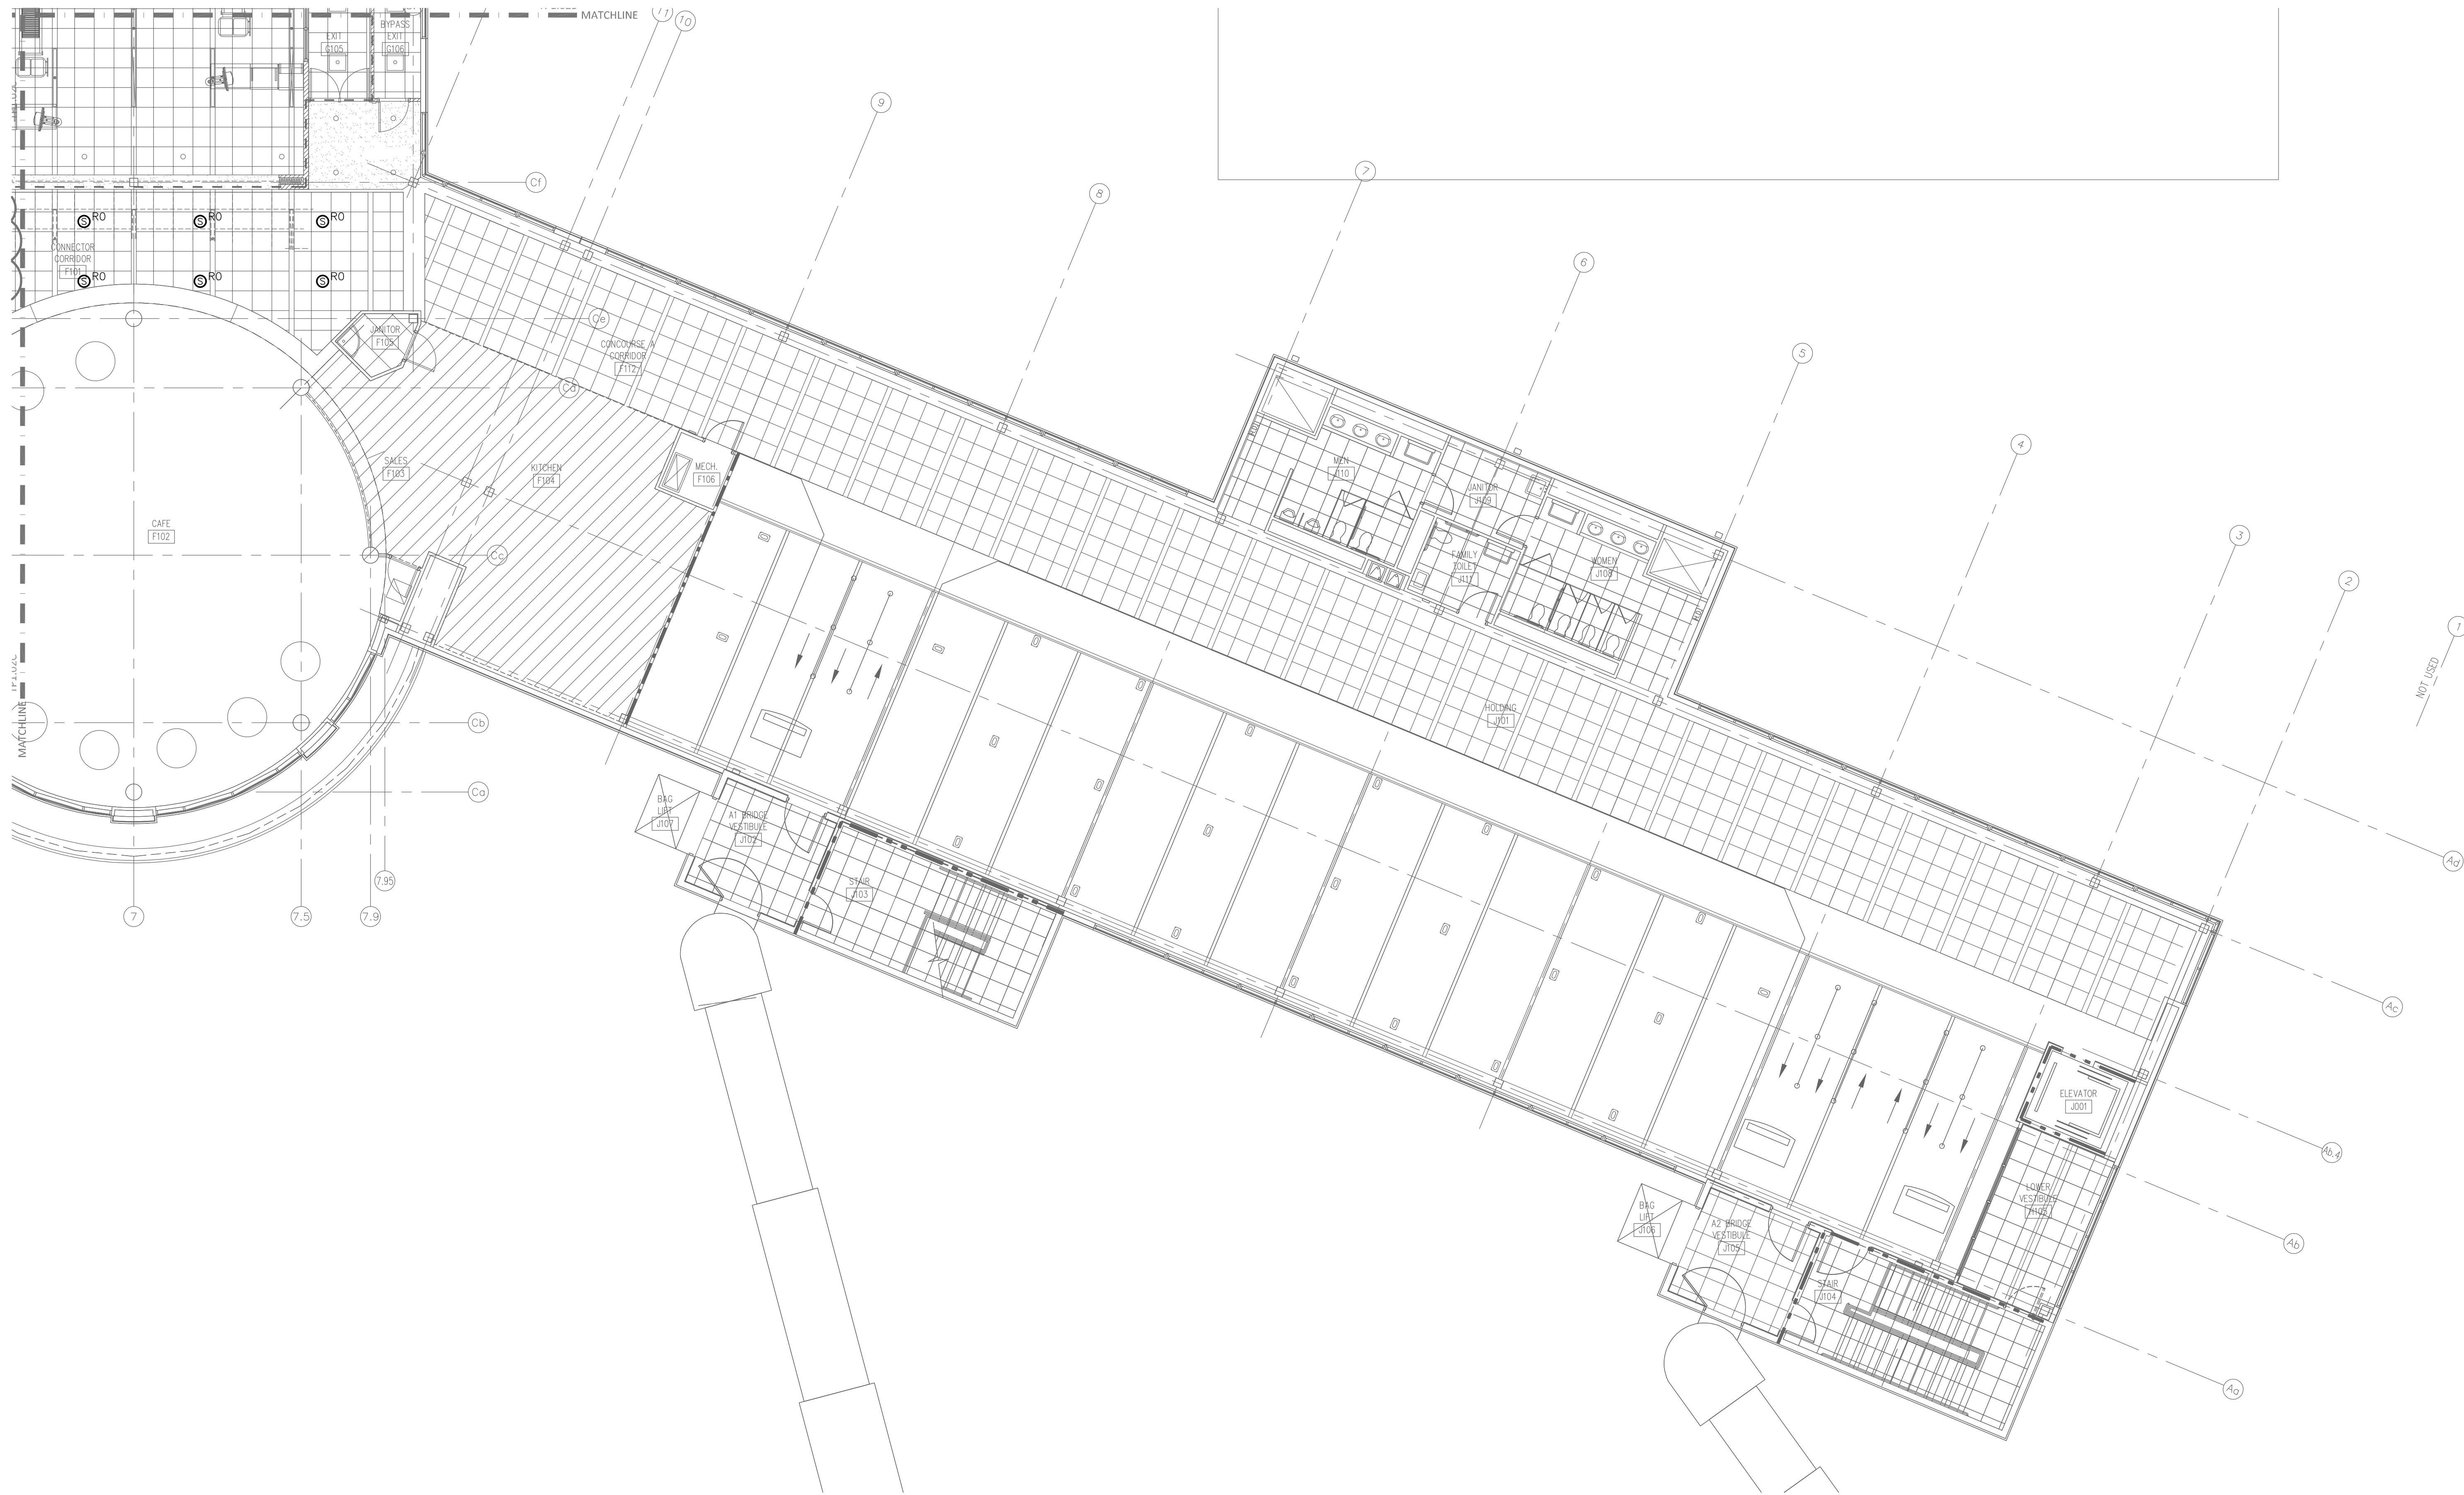

SECOND FLOOR PLAN — AREA D — PUBLIC ADDRESS
SCALE: 1/8" = 1'-0"

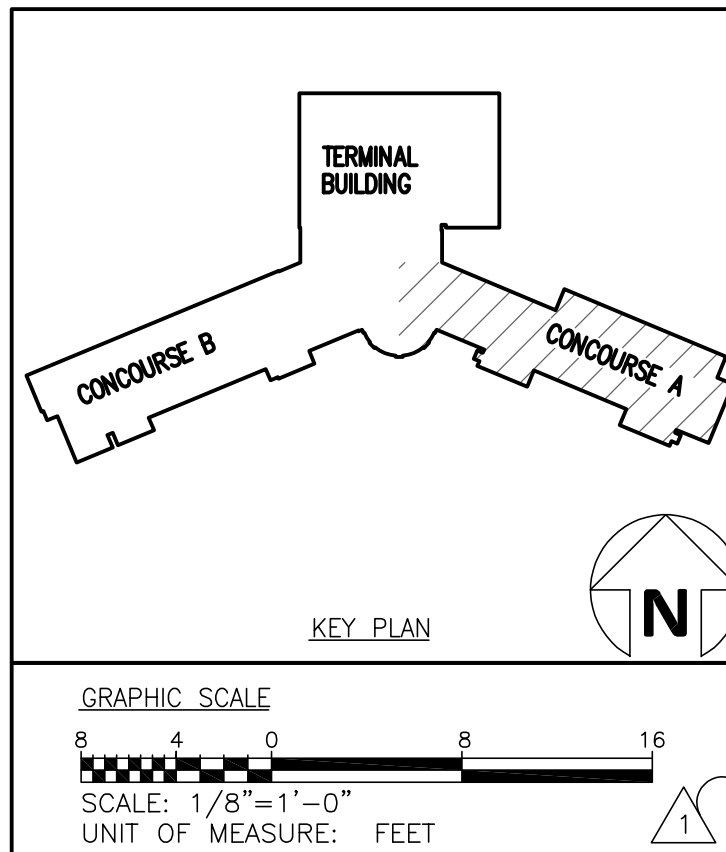

DRAWN BY: JMT
REVIEWED BY: JMT
DATE: 07-18-18
PROJECT NO.: 1808

REVISIONS	
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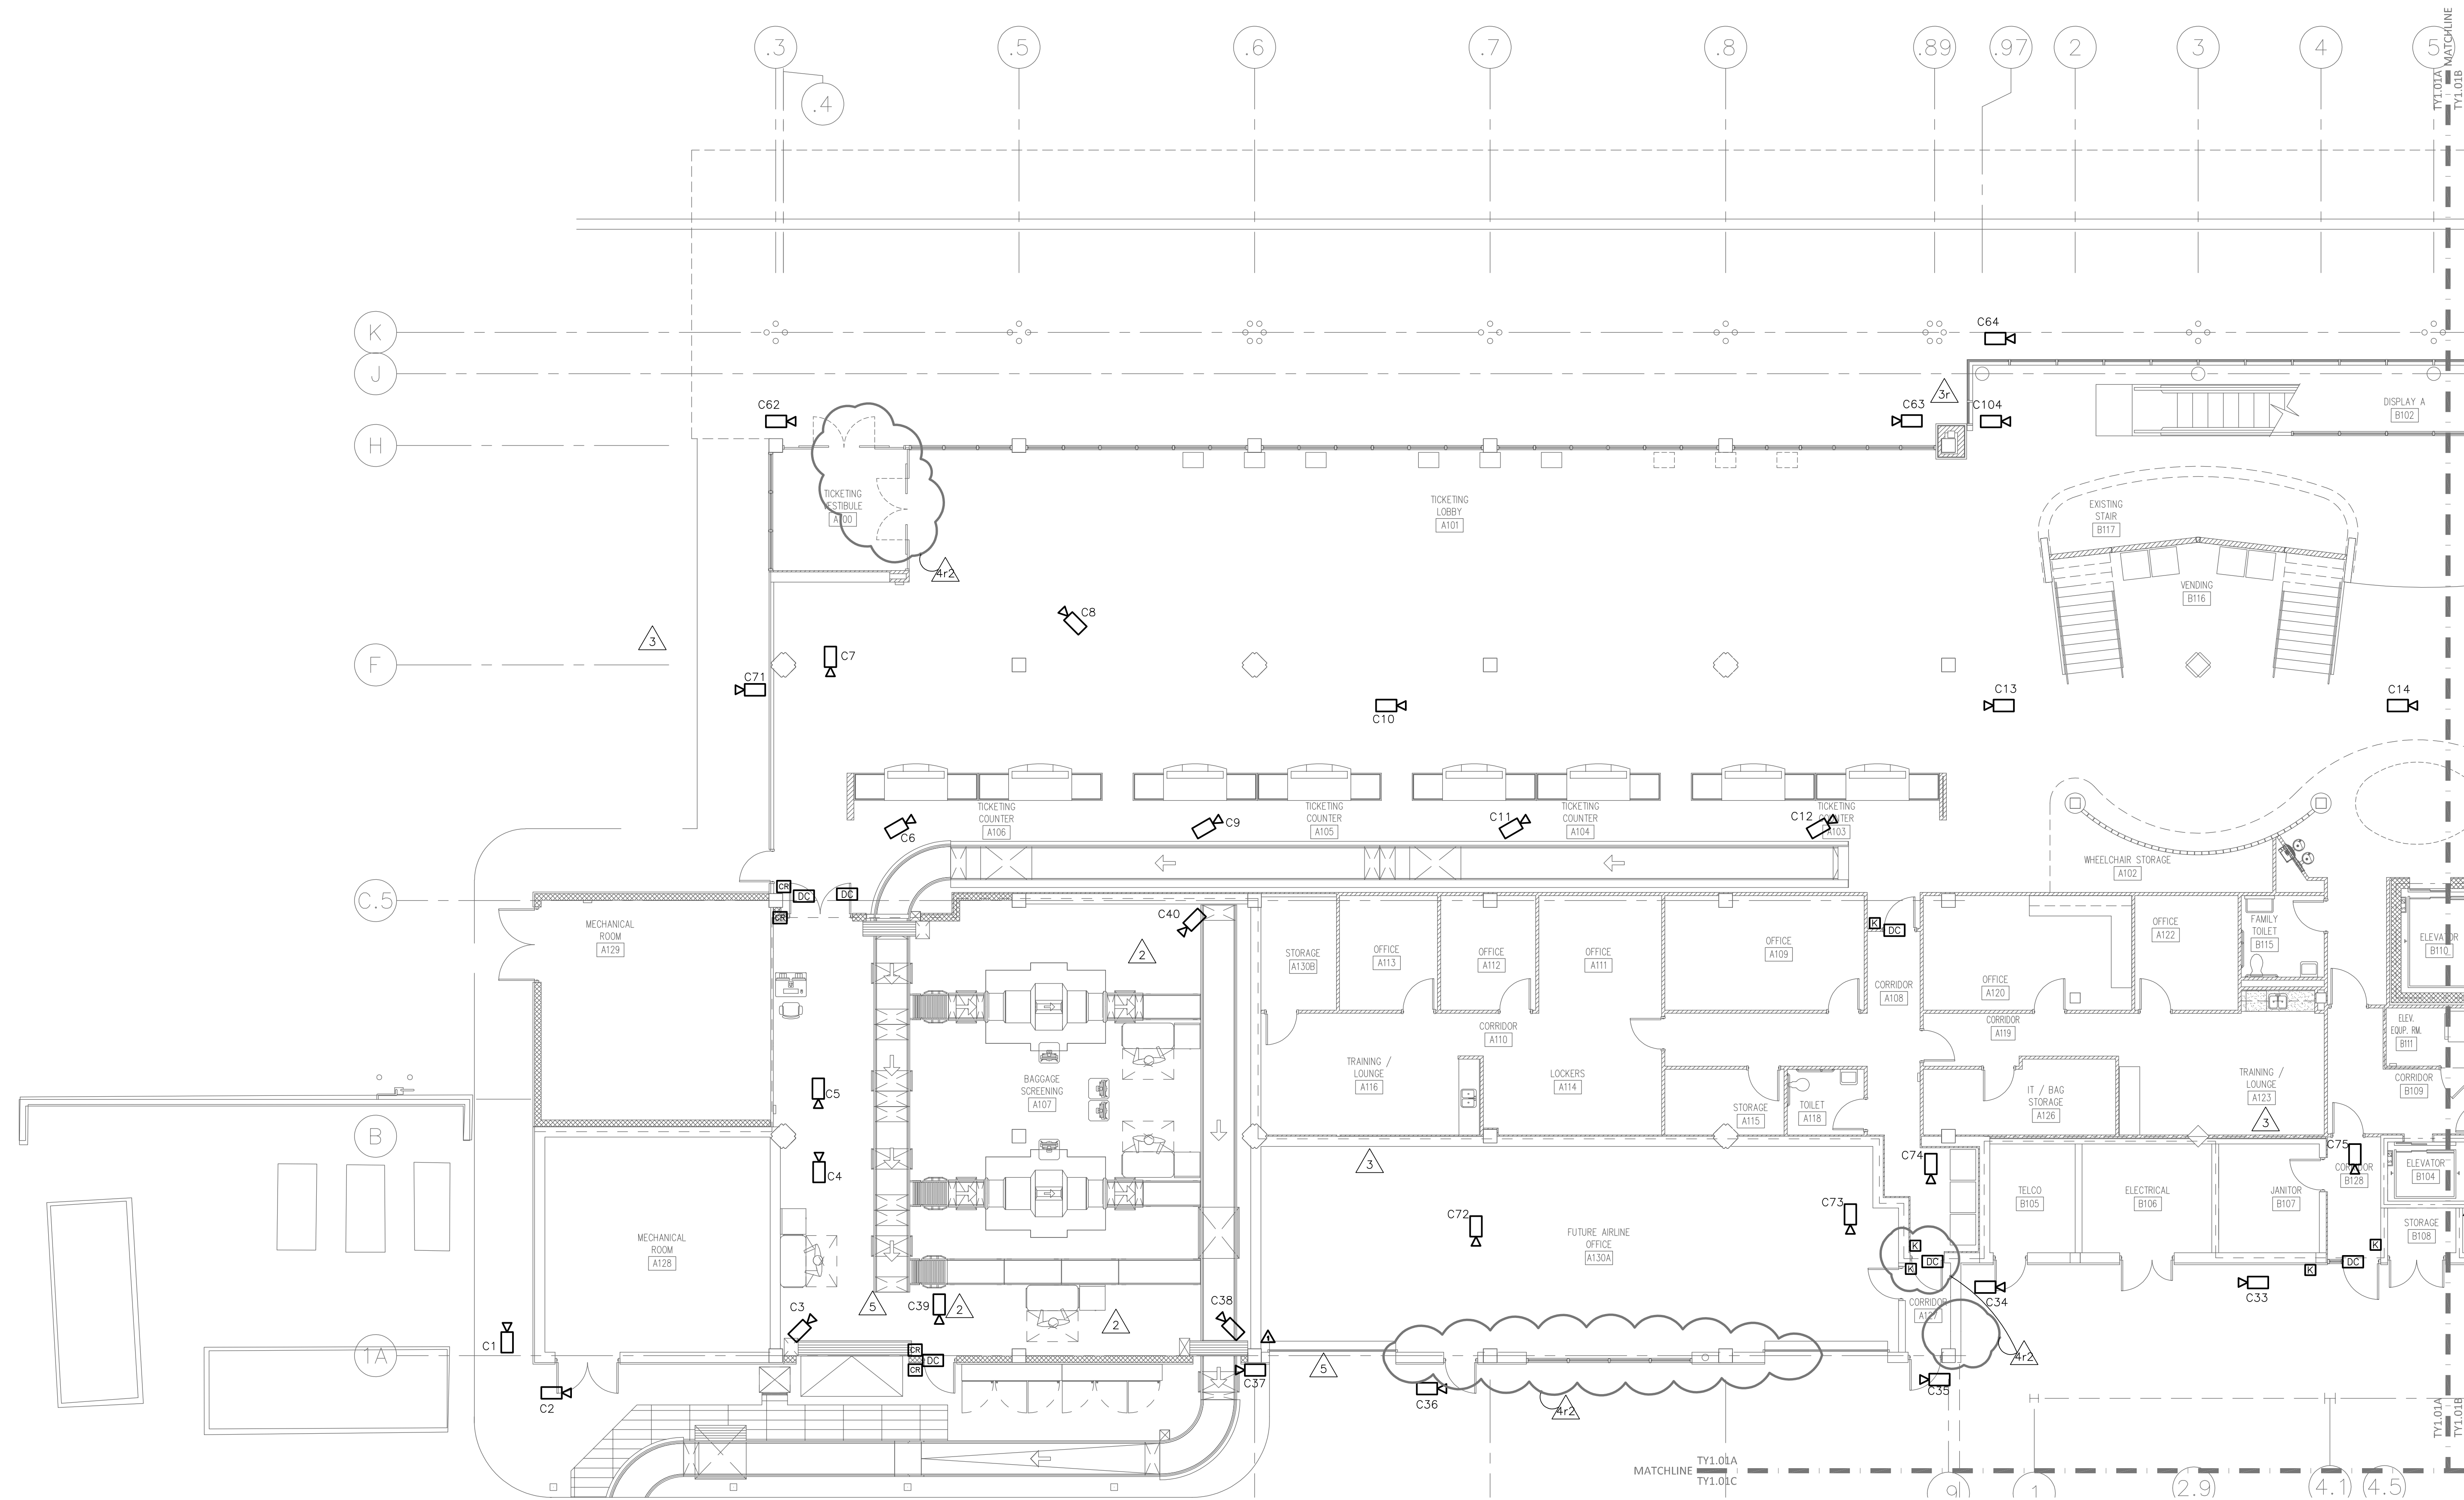
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RMF Project No: 2153223.F0

Fayetteville Regional Airport — Airline Terminal Improvements Part 2
SECOND FLOOR PLAN — AREA D — PUBLIC ADDRESS
400 Airport Road
Fayetteville, North Carolina 28306



FIRST FLOOR PLAN – AREA A – SECURITY
SCALE: 1/8" = 1'-0"

- GENERAL NEW WORK NOTES**
- A. CONTRACTOR SHALL FIELD VERIFY ALL DIMENSIONS AND SITE CONDITIONS BEFORE COMMENCING WORK.
 - B. THIS CONTRACT REQUIRES COMPLETE, FINISHED WORKABLE PROJECT OF THE AREAS INDICATED BY THE CONTRACT DOCUMENTS, AND SHALL INCLUDE ALL MATERIALS AND LABOR NECESSARY TO COMPLETE SAME, REGARDLESS OF WHETHER OR NOT EACH AND EVERY NECESSARY WORK OR ITEM IS SPECIFICALLY INDICATED ON ANY OTHER PORTION OF THE DRAWING AND/OR NOTES.
 - C. ALL DETAILS AND SECTIONS SHOWN ON THE DRAWINGS ARE INTENDED TO BE TYPICAL AND SHALL BE CONSTRUED TO APPLY TO ANY SIMILAR SITUATION ELSEWHERE ON THE PROJECT, EXCEPT WHERE A DIFFERENT DETAIL IS SHOWN.
 - D. CONTRACTOR SHALL FURNISH ALL ADDITIONAL DATA AND DOCUMENTATION TO SECURE ALL REQUIRED PERMITS AND SHALL COORDINATE THIS DATA WITH THE CONSTRUCTION DOCUMENTS WHERE REQUIRED.
 - E. AS A MINIMUM, ALL WORK SHALL CONFORM TO THE APPLICABLE BUILDING CODE ADOPTED BY THE JURISDICTION OF THE WORK, WHERE MORE STRINGENT CODES ARE ADOPTED, THEY SHALL GOVERN THE WORK.
 - F. ALL WORK SHALL CONFORM TO APPLICABLE FEDERAL, STATE, COUNTY AND LOCAL CODES AND ORDINANCES.
 - G. TO PROVIDE ACCESSIBILITY FOR THE PHYSICALLY HANDICAPPED, ALL WORK SHALL CONFORM TO PUBLIC LAW 101-336 (AMERICANS WITH DISABILITIES ACT OF 1993).
 - H. ALL WORK SHALL CONFORM TO THE APPLICABLE NFPA 101-LIFT SAFETY CODE ADOPTED BY THE JURISDICTION OF THE WORK.
 - I. AROUND ALL EXPOSED PIPES, CONDUIT OR DUCTS, INSTALL ENCLOSURES OF THE SAME MATERIAL AND FINISH AS ADJACENT WORK, UNLESS NOTED OTHERWISE.
 - J. FIELD CHECK ALL ROUGH AND/OR FINISH DIMENSIONS FOR ACCURATE FITTING OF EQUIPMENT, CABINETS, COUNTERS, FIXTURES AND ACCESSORIES BEFORE FABRICATION. PROVIDE AND INSTALL ALL NECESSARY FILLERS, SCRIBE STRIPS, PANELS, BASES OR TRIM TO COMPLETE AND FINISH INSTALLATIONS.
 - K. ALL SWITCHES, OUTLETS, THERMOSTATS, CLOCKS, SPEAKERS OR OTHER WALL MOUNTED DEVICES OR CONTROLS SHALL BE INSTALLED IN LOCATIONS WHICH ARE UNOBSTRUCTED BY CABINETS, COUNTERS, RACKS, FIXTURES, FURNISHINGS OR EQUIPMENT. ITEMS INTENDED FOR WALL MOUNTING SHALL NOT BE INSTALLED ON, THROUGH OR INTO ANY OTHER EQUIPMENT UNLESS SPECIFICALLY CALLED FOR. VERIFY MOUNTING HEIGHTS WITH ADA REQUIREMENTS.
 - L. PROVIDE AND INSTALL ALL NECESSARY HARDWARE, BRACKETS, BRACING, ANCHORING, INSERTS, BLOCKING, FURNISH OR OTHER SUPPLEMENTARY ITEMS NEEDED FOR COMPLETE INSTALLATION OF EQUIPMENT, FIXTURES AND ACCESSORIES.
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 - N. WHERE MATERIALS REFERENCED ON DRAWINGS, OR NECESSARY TO COMPLETE THE WORK OF THIS CONTRACT ARE NOT SPECIFIED HEREIN, PROVIDE BEST QUALITY MATERIALS. WHERE MATERIALS ARE INTENDED TO MATCH EXISTING, PROVIDE CLOSEST POSSIBLE MATCH, SUBJECT TO OWNER'S APPROVAL. ALL ITEMS AND WORK ON DRAWINGS ARE NEW UNLESS INDICATED OTHERWISE. ALL WORK WHICH HAS BEEN DAMAGED SHALL BE REPAIRED OR REPLACED, WHERE ITEM CANNOT BE REPAIRED TO A "NEW CONDITION", OR WHERE THE STRUCTURAL INTEGRITY HAS BEEN AFFECTED, ITEM SHALL BE REPLACED.
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- GENERAL SHEET NOTES**
- 1. COORDINATE DEVICE MOUNTING HEIGHTS FOR MILLWORK AND FURNITURE WITH ARCHITECTURAL DRAWINGS.
 - 2. DETERMINE BEST LOCATION FOR NEW SECURITY CAMERAS BASED ON SITE CONDITIONS AND EXISTING LOCATIONS IN FIELD. PLACE NEW SECURITY CAMERAS AT EXISTING CAMERA LOCATION WHERE POSSIBLE.

FIRE RATED WALL LEGEND

- 1 HOUR FIRE PARTITION
- 1 HOUR FIRE BARRIER

KEY PLAN

GRAPHIC SCALE
SCALE: 1/8" = 1'-0"
UNIT OF MEASURE: FEET

REVISIONS

NO.	DESCRIPTION	DATE
1	ISSUED FOR PERMIT	08/24/20
2	REVISED	12/17/20
3	REVISED	04/16/21
4	REVISED	07/28/21

SHEET NUMBER
TY1.01A

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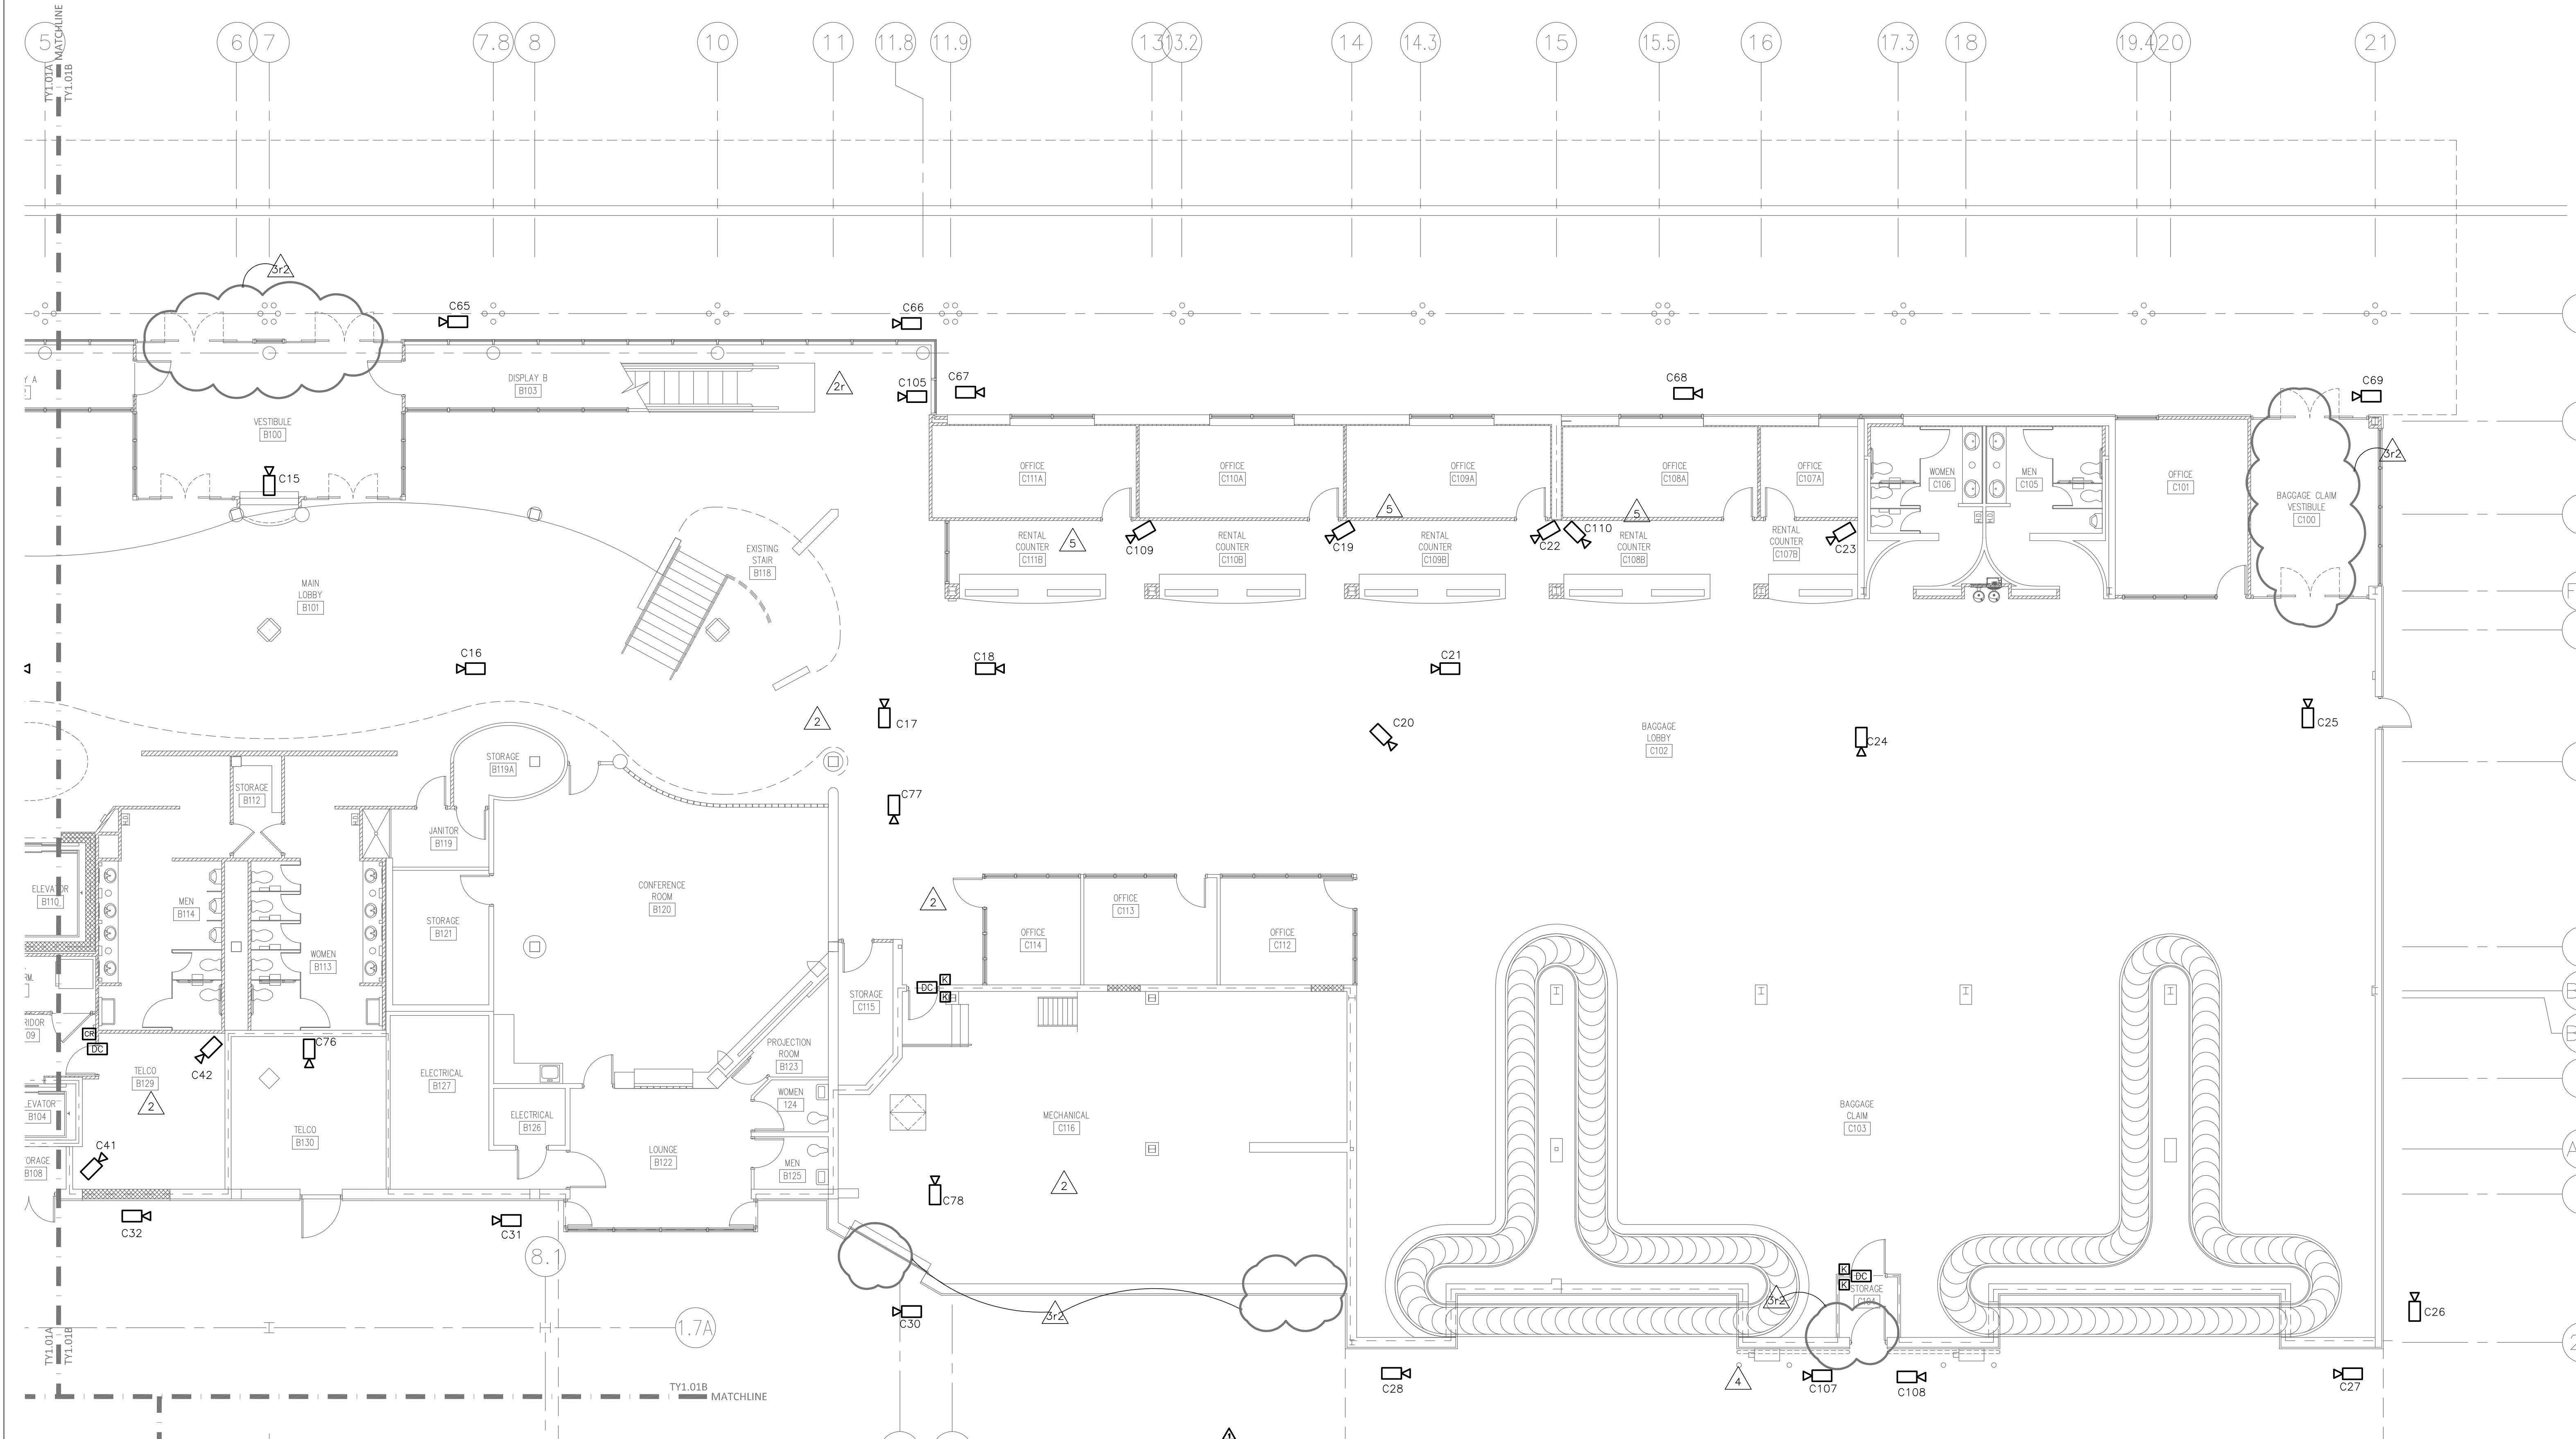
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RMF Project No: 2153223.F0

Fayetteville Regional Airport – Airline Terminal Improvements Part 2

FIRST FLOOR PLAN – AREA A – SECURITY

400 Airport Road
Fayetteville, North Carolina 28306

DRAWN BY: JMT
REVIEWED BY: JMT
DATE: 07-18-19
PROJECT NO.: 1808



FIRST FLOOR PLAN - AREA B - SECURITY

SCALE: 1/8" = 1'-0"

GENERAL NEW WORK NOTES


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GENERAL SHEET NOTES


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FIRE RATED WALL LEGEND

- 1 HOUR FIRE PARTITION
- 1 HOUR FIRE BARRIER



KEY PLAN

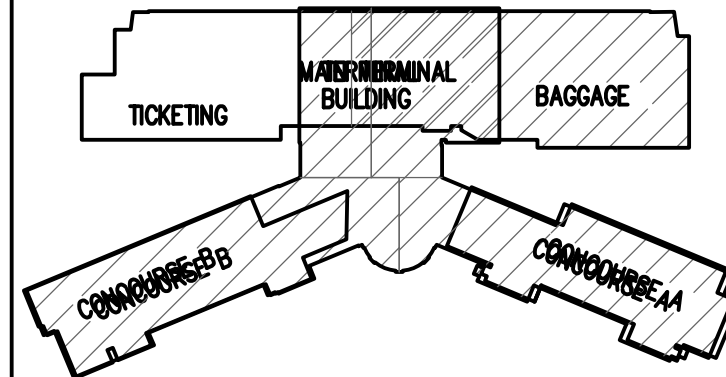

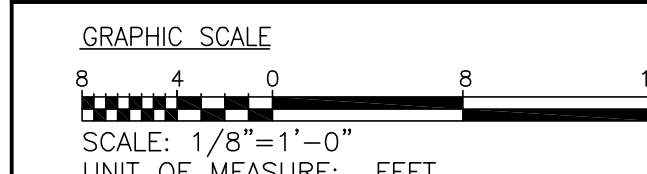UNIT OF MEASURE: FEET

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RMF Project No: 2153223.F0

Fayetteville Regional Airport - Airline Terminal Improvements Part 2

FIRST FLOOR PLAN - AREA B - SECURITY

DRAWN BY: JMT
REVIEWED BY: JMT
DATE: 07-18-19
PROJECT NO.: 1808

REVISIONS
3. 08-12 12/17/20
4. 08-14 02/10/21
5. 08-17 04/16/21
6. 08-19 07/28/21

SHEET NUMBER

TY1.01B

A. CONTRACTOR SHALL FIELD VERIFY ALL DIMENSIONS AND SITE CONDITIONS BEFORE COMMENCING WORK.

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C. ALL DETAILS AND SECTIONS SHOWN ON THE DRAWINGS ARE INTENDED TO BE TYPICAL AND SHALL BE CONSTRUED TO APPLY TO ANY SIMILAR SITUATION ELSEWHERE ON THE PROJECT, EXCEPT WHERE A DIFFERENT DETAIL IS SHOWN.

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APPLICABLE BUILDING CODE ADOPTED BY THE
JURISDICTION OF THE WORK. WHERE MORE STRINGENT
CODES ARE ADOPTED, THEY SHALL GOVERN THE WORK

G. TO PROVIDE ACCESSIBILITY FOR THE PHYSICALLY HANDICAPPED, ALL WORK SHALL CONFORM TO PUBLIC LAW

1. AROUND ALL EXPOSED PIPES, CONDUIT OR DUCTS

6. FIELD CHECK ALL ROUGH AND/OR FINISH DIMENSIONS FOR ACCURATE FITTING OF EQUIPMENT, CABINETS, COUNTERTOPS, FIXTURES AND ACCESSORIES BEFORE

K. ALL SWITCHES, OUTLETS, THERMOSTATS, CLOCKS, SPEAKERS OR OTHER WALL MOUNTED DEVICES OR

THROUGH OR INTO ANY OTHER EQUIPMENT UNLESS SPECIFICALLY CALLED FOR. VERIFY MOUNTING HEIGHTS WITH ADA REQUIREMENTS.

COMPLETE INSTALLATION OF EQUIPMENT, FIXTURES AND ACCESSORIES.

THE ENTIRE PROJECT TO PREVENT CONFLICTS AND INTERFERENCE, OBTAIN ALL NECESSARY INFORMATION SUCH AS SIZES, LOCATIONS, TEMPLATES, LAYOUT, DIMENSIONS.

N. WHERE MATERIALS REFERENCED ON DRAWINGS, OR

TO OWNER'S APPROVAL. ALL ITEMS AND WORK ON
DRAWINGS ARE NEW UNLESS INDICATED OTHERWISE. ALL
WORK WHICH HAS BEEN DAMAGED SHALL BE REPAIRED AS



0. CONTRACTOR SHALL OBTAIN FROM OWNER ALL REQUIREMENTS FOR INSTALLATION OF OWNER PROVIDED

INSTALLATION. PRIOR TO ROUGH-IN SERVICES, CONFER WITH OWNER EXACT LOCATION OF ALL ITEMS.

1. COORDINATE DEVICE MOUNTING HEIGHTS FOR MILLWORK

2. DETERMINE BEST LOCATION FOR NEW SECURITY CAMERAS BASED ON SITE CONDITIONS AND EXISTING LOCATIONS IN FIELD. PLACE NEW SECURITY CAMERAS AT EXISTING CAMERA LOCATION WHERE POSSIBLE.

2. DETERMINE BEST LOCATION FOR NEW SECURITY CAMERAS BASED ON SITE CONDITIONS AND EXISTING LOCATIONS IN FIELD. PLACE NEW SECURITY CAMERAS AT EXISTING CAMERA LOCATION WHERE POSSIBLE.

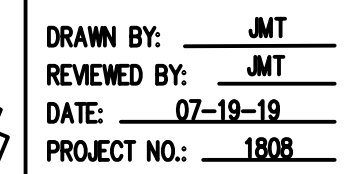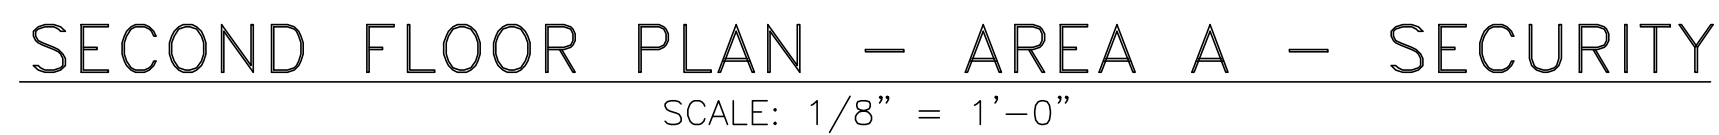TV-14 00A

|Y1.02A

CONTRACTOR SHALL FIELD VERIFY ALL DIMENSIONS AND SITE CONDITIONS BEFORE COMMENCING WORK.

B. THIS CONTRACT REQUIRES COMPLETE, FINISHED WORKABLE SCHEDULES TO BE SUBMITTED TO THE OWNER BY THE CONTRACTOR. DOCUMENTS, SHALL INCLUDE ALL MATERIALS AND LABOR NECESSARY TO COMPLETE SAME, REGARDLESS OF WHETHER OR NOT EACH ITEM OF WORK OR ITEM IS SPECIFICALLY INDICATED ON ANY OTHER PORTION OF THE DRAWING AND/OR NOTES.

C. ALL DETAILS AND SECTIONS SHOWN ON THE DRAWINGS SHALL BE ADHERED TO. THE CONTRACTOR SHALL BE REQUIRED TO APPLY TO ANY SIMILAR SITUATION ELSEWHERE ON THE PROJECT, EXCEPT WHERE A DIFFERENT DETAIL IS SHOWN.

D. CONTRACTOR SHALL FURNISH ALL ADDITIONAL DATA AND DOCUMENTATION TO SECURE ALL REQUIRED PERMITS AND APPROVALS (ADEQUATE) WITH THE CONSTRUCTION DOCUMENTS WHERE REQUIRED.

E. AS A MINIMUM, ALL WORK SHALL CONFORM TO THE APPLICABLE BUILDING CODE ADOPTED BY THE JURISDICTION OF THE PROJECT. IF THERE ARE ANY VARIATIONS OR DIFFERENT CODES ADOPTED, THEY SHALL GOVERN THE WORK.

F. ALL WORK SHALL CONFORM TO APPLICABLE FEDERAL, STATE, COUNTY AND LOCAL CODES AND ORDINANCES.

G. TO PROVIDE ACCESSIBILITY FOR THE PHYSICALLY HANDICAPPED, ALL WORK SHALL CONFORM TO PUBLIC LAW 94-142 (AMENDMENTS WITH THE REHABILITATION ACT OF 1993).

H. ALL WORK SHALL CONFORM TO THE APPLICABLE NFPA 101-LIFE SAFETY CODE ADOPTED BY THE JURISDICTION OF THE WORK.

I. AROUND ALL EXPOSED PIPES, CONDUIT OR DUCTS, IN ALL ENCLOSURES, ALL WORK SHALL BE FINISHED AS ADJUSTED WORK, UNLESS NOTED OTHERWISE.

J. FIELD CHECK ALL ROUGH AND/OR FINISH DIMENSIONS FOR ACCURATE FITTING OF EQUIPMENT, CABINETS, COUNTERS, FIXTURES AND ACCESSORIES BEFORE FABRICATION. PROVIDE AND INSTALL ALL NECESSARY FILLERS, SCRIBE STRIPS, PANELS, BASES OR TRIM TO COMPLETE AND FINISH INSTALLATIONS.

K. ALL SWITCHES, OUTLETS, THERMOSTATS, CLOCKS, DIMMERS OR OTHER CONTROLS OR DEVICES OR CONTROLS SHALL BE INSTALLED IN LOCATIONS WHICH ARE UNOBSSTRUCTURED BY CABINETS, COUNTERS, RACKS, OR OTHER DEVICES. IF THE LOCATION IS NOT INTENDED FOR WALL MOUNTING SHALL NOT BE INSTALLED ON, OR INTO OR THROUGH ANY DEPENDENT SURFACE SPECIFICALLY CALLED FOR. VERIFY MOUNTING HEIGHTS WITH DATA REQUIREMENTS.

L. PROVIDE AND INSTALL ALL NECESSARY HARDWARE, INCLUDING, BUT NOT LIMITED TO, SCREWS, BOLTS, NUTS, BRACING, AND ANCHORS. PROVIDE, FURNISH OR INSTALL OTHER SUPPLEMENTARY ITEMS NEEDED FOR COMPLETE INSTALLATION OF EQUIPMENT, FIXTURES AND ACCESSORIES.


M. ALL CONTRACTORS ARE TO COORDINATE THE WORK OF EACH OTHER, SO THAT THE WORK AND SCHEDULE ARE NOT IMPEDED. SCHEDULE WORK PROGRESS THROUGHOUT THE PROJECT TO PREVENT CONFLICTS AND INTERFERENCE, OBTAIN ALL NECESSARY INFORMATION SUCH AS SIZES, LOCATIONS, TEMPLATES, LAYOUT, DIMENSIONS AND OTHER INFORMATION FROM THE PROJECTOR AND FIELD COORDINATED INSTALLATION. PRIOR TO THE START OF ITEMS OF WORK WITH EACH CONTRACTOR EXACT LOCATION OF ALL ITEMS.

N. WHERE MATERIALS REFERENCED ON DRAWINGS, OR NECESSARY TO COMPLETE THE WORK OF THIS CONTRACT ARE NOT SPECIFIED HEREIN, PROVIDE BEST QUALITY MATERIALS. WHERE MATERIALS ARE INTENDED TO MATCH EXISTING, PROVIDE CLOSEST POSSIBLE MATCH, SUBJECT TO THE APPROVAL OF THE PROJECTOR. WHERE THE DRAWINGS ARE NEW UNLESS INDICATED OTHERWISE, ALL WORK WHICH HAS BEEN DAMAGED SHALL BE REPAIRED OR REPLACED. WHERE THE WORK IS IN A "NEW CONDITION", OR WHERE THE STRUCTURAL INTEGRITY HAS BEEN AFFECTED, IT MUST BE REPLACED.

O. CONTRACTOR SHALL OBTAIN FROM OWNER ALL NECESSARY PERMITS FOR INSTALLATION OF OWNER PROVIDED EQUIPMENT INCLUDING ROUGHING DRAWINGS, INSTALLATION INSTRUCTIONS, ELECTRICAL, SCHEMATICS, TEMPLATES, DIMENSIONS AND DIMENSIONS. ALL OTHER INFORMATION NECESSARY FOR A PROPER, WELL COORDINATED INSTALLATION. PRIOR TO ROUGH-IN SERVICES, CONFERENCE WITH OWNER TO OBTAIN EXACT LOCATION OF ALL

1. COORDINATE DEVICE MOUNTING HEIGHTS FOR MILLWORK AND FURNITURE WITH ARCHITECTURAL DRAWINGS.
2. DETERMINE BEST LOCATION FOR NEW SECURITY CAMERAS BASED ON SITE CONDITIONS AND EXISTING LOCATIONS IN FIELD. PLACE NEW SECURITY CAMERAS AT EXISTING CAMERA LOCATION WHERE POSSIBLE.

① ALL-IN-ONE EXIT LANE BREACH CONTROL SYSTEM, PROVIDED BY OTHERS. COORDINATE CONNECTIONS INTO SECURITY SYSTEM.

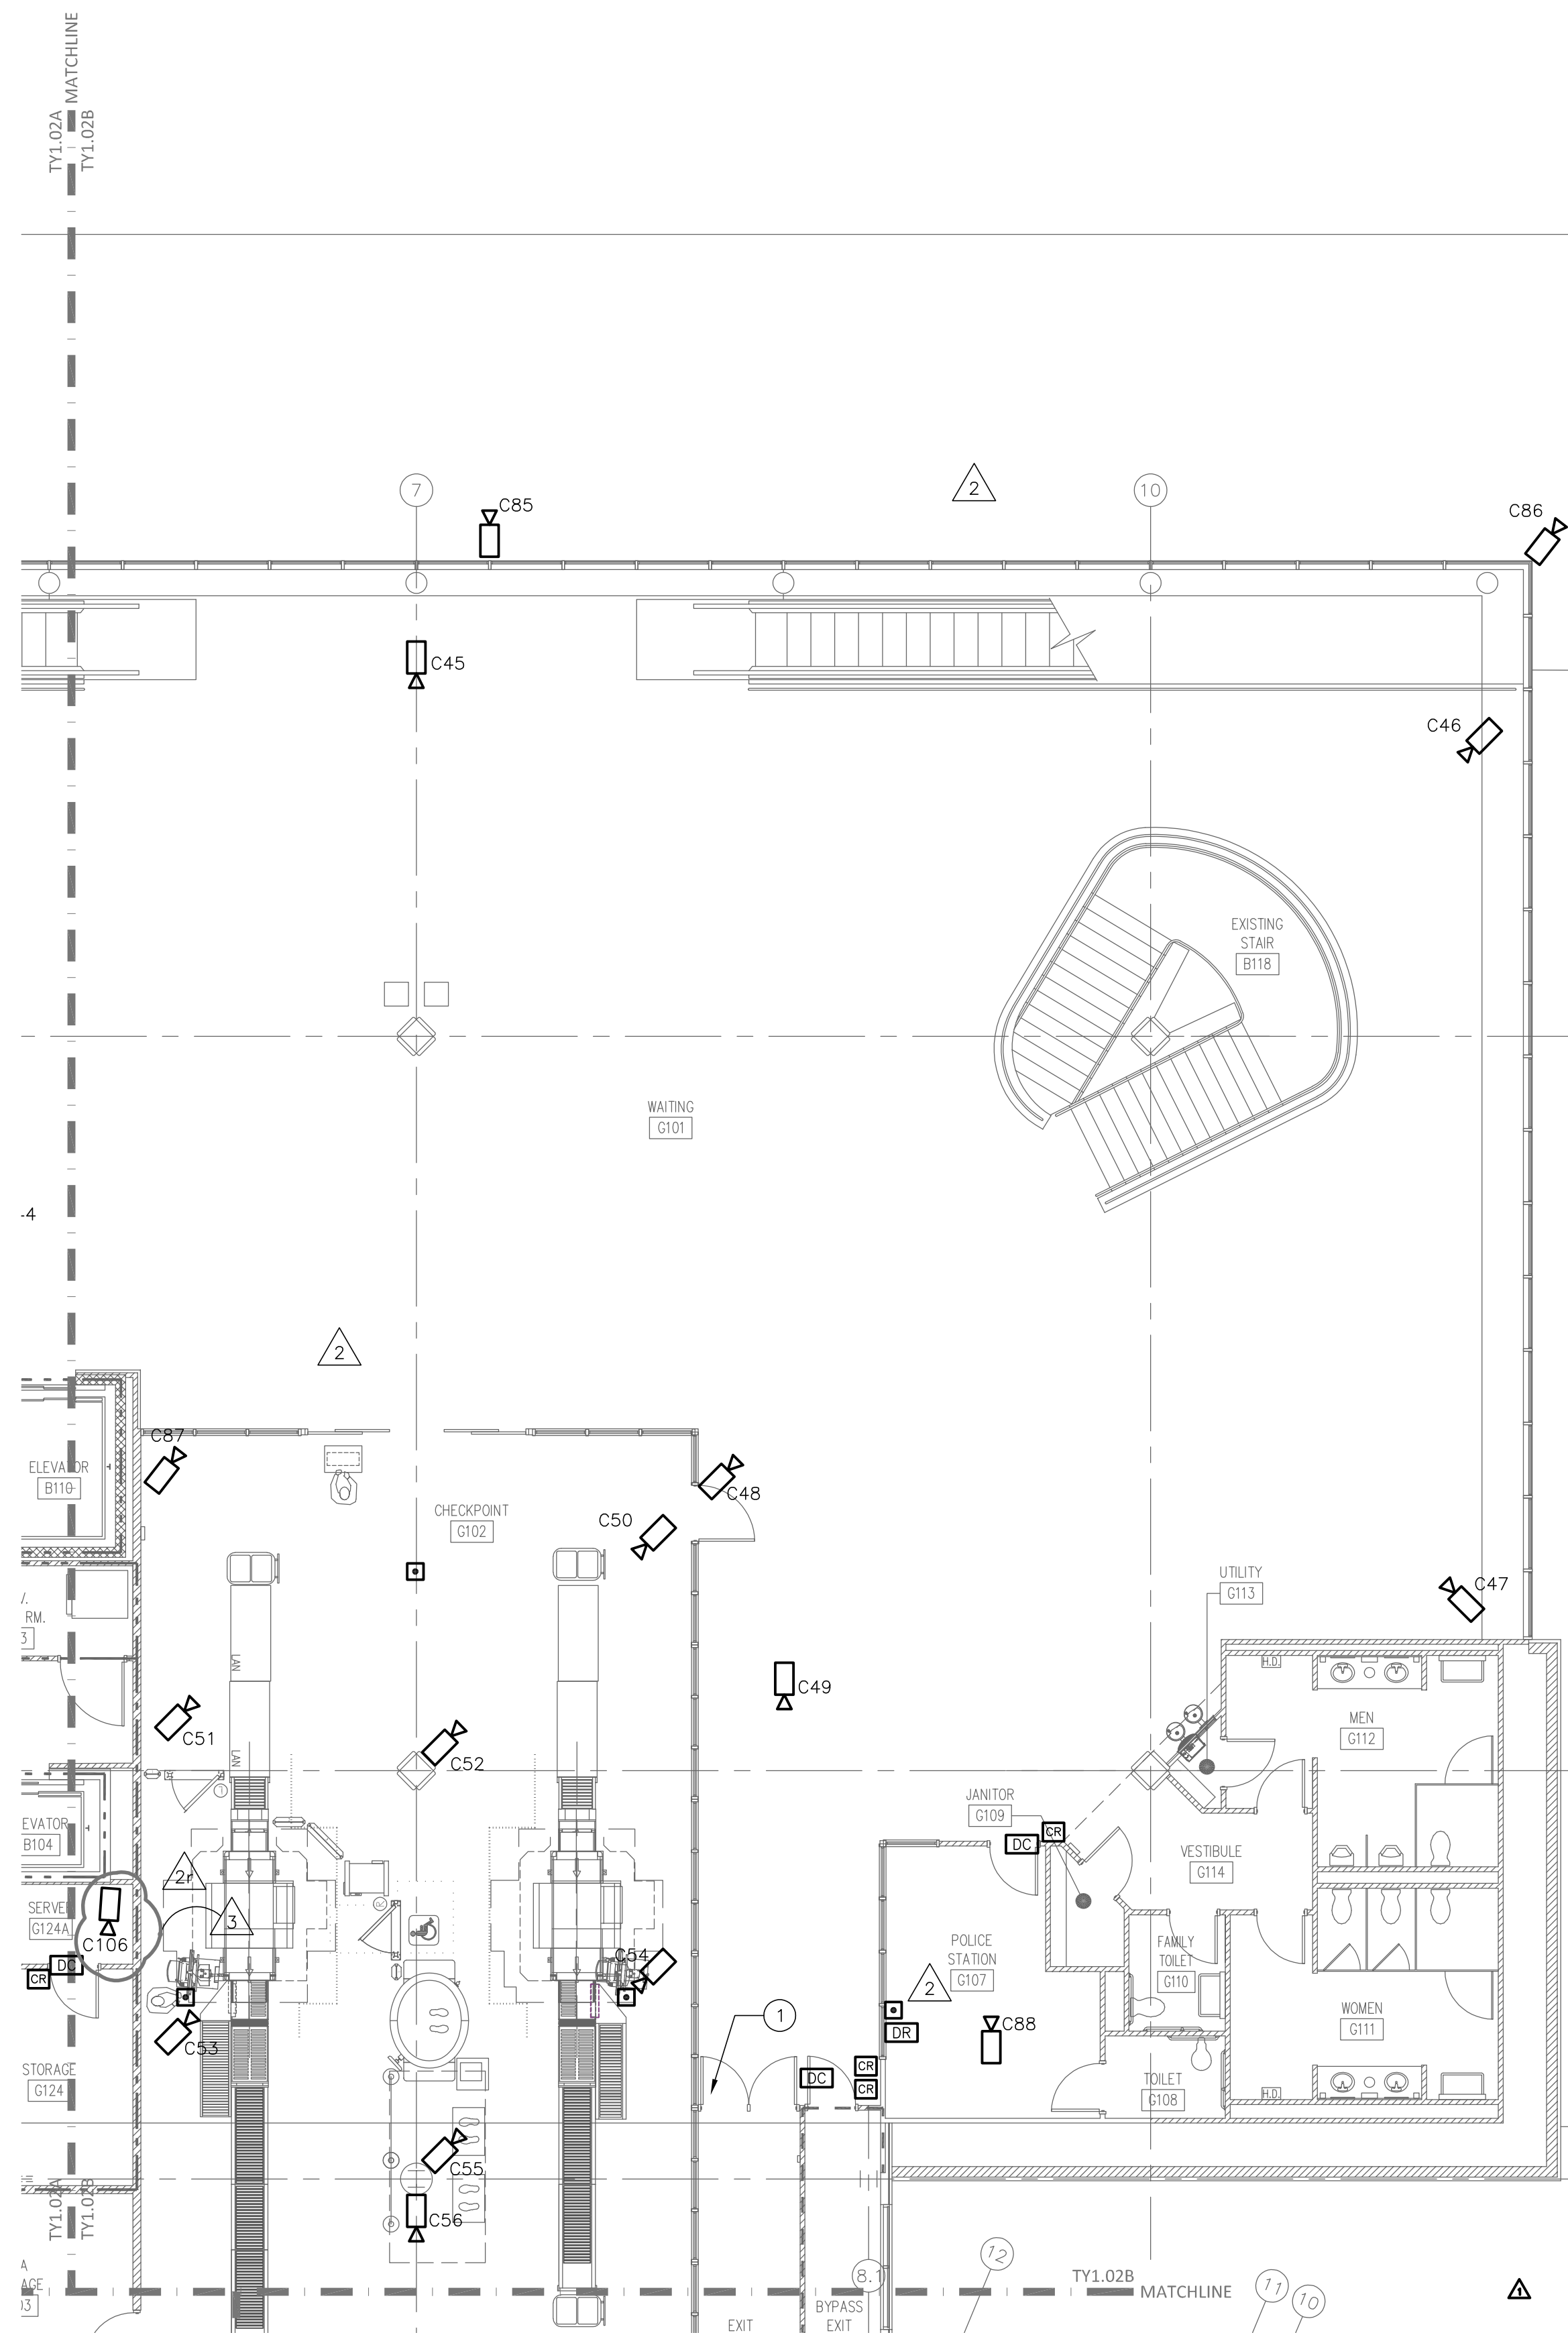

Fayetteville Regional Airport – Airline Terminal Improvements Part 2

SECOND FLOOR PLAN - AREA B - SECURITY


Fayetteville, North Carolina 28306

DRAWN BY: JMT
 REVIEWED BY: JMT
 DATE: 07-19-19
 PROJECT NO.: 1808

REVISIONS	
CBE-6	07/31/20
CBE-6r	08/24/20
CBE-17	04/16/21




SHEET NUMBER

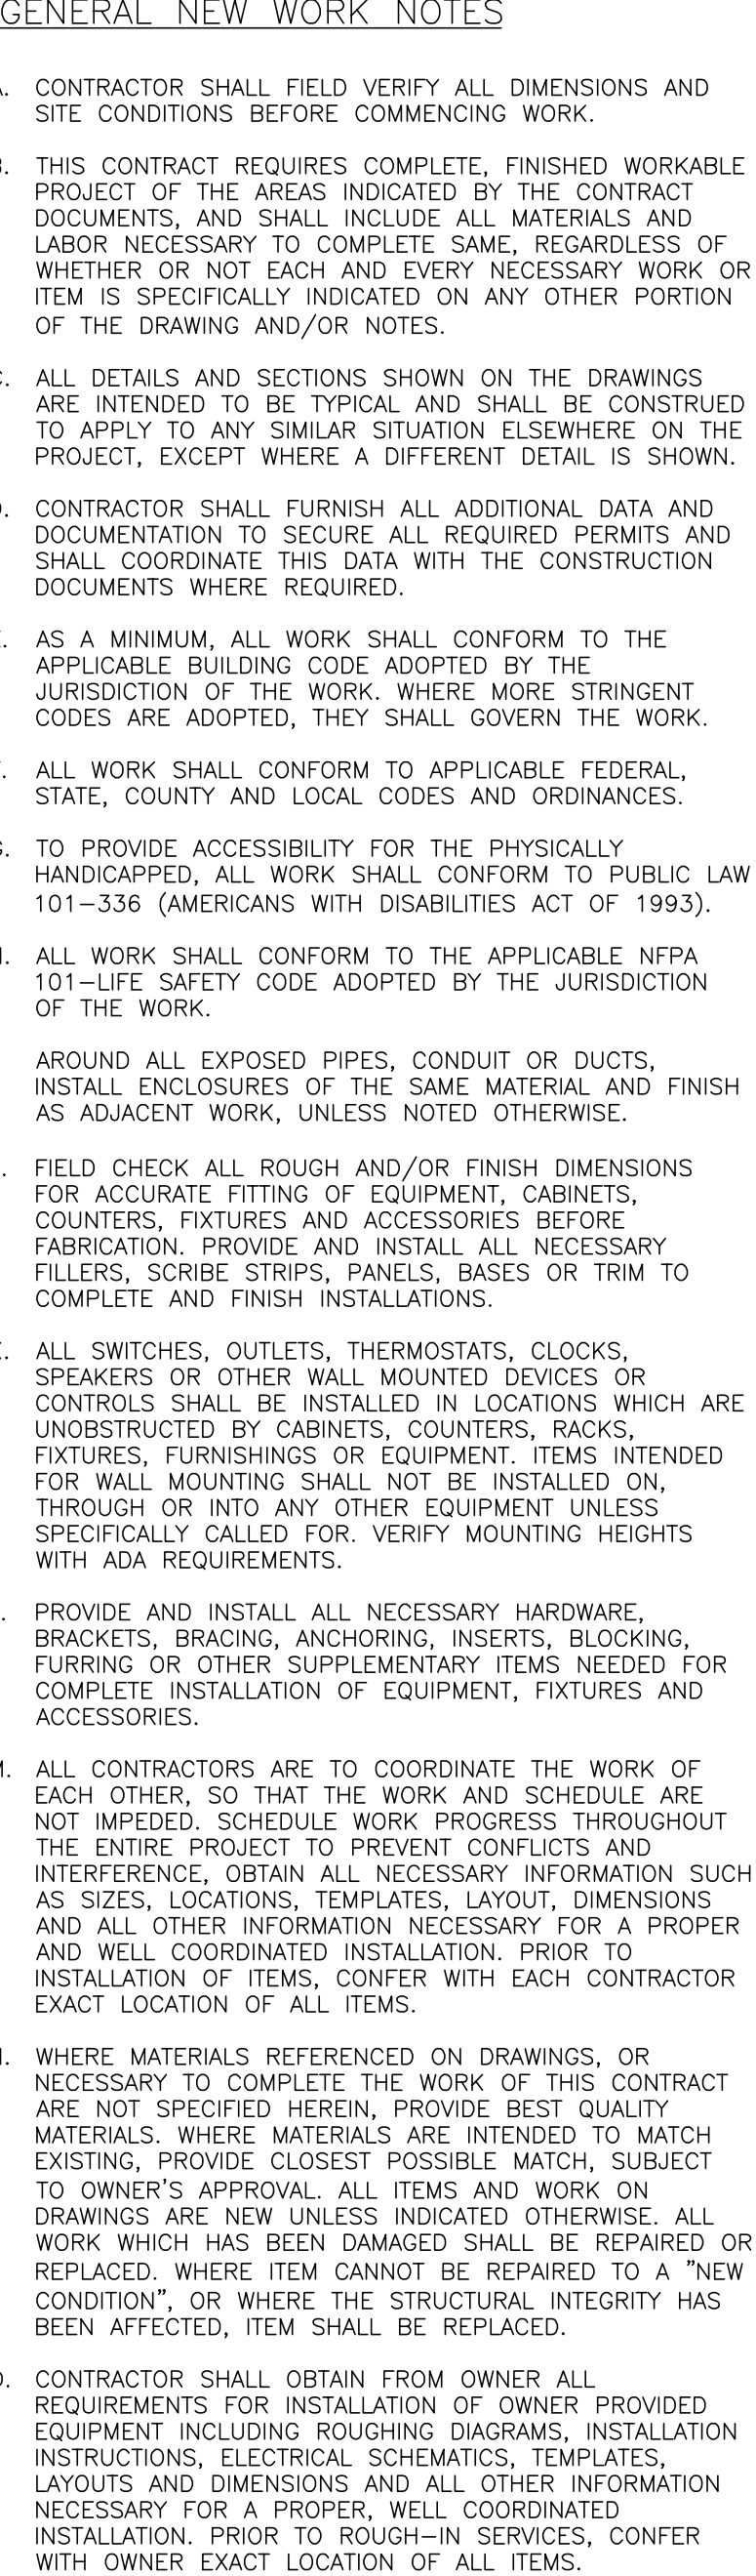TY1.02B



GENERAL SHEET NOTES

- COORDINATE DEVICE MOUNTING HEIGHTS FOR MILLWORK AND FURNITURE WITH ARCHITECTURAL DRAWINGS.
- DETERMINE BEST LOCATION FOR NEW SECURITY CAMERAS BASED ON SITE CONDITIONS AND EXISTING LOCATIONS IN FIELD. PLACE NEW SECURITY CAMERAS AT EXISTING CAMERA LOCATION WHERE POSSIBLE.

DRAWN BY: <u>JMT</u>	
REVIEWED BY: <u>JMT</u>	
DATE: <u>07-19-19</u>	
PROJECT NO.: <u>1808</u>	
REVISIONS	
	ADDENDUM 3 08/14/19
	CBE-6 07/31/20
	
SHEET NUMBER	
TY1.02C	




SECOND FLOOR PLAN — AREA D — SECURITY
SCALE: 1/8" = 1'-0"

GENERAL NEW WORK NOTES

- CONTRACTOR SHALL FIELD VERIFY ALL DIMENSIONS AND SITE CONDITIONS BEFORE COMMENCING WORK.
- THIS CONTRACT REQUIRES COMPLETE, FINISHED WORKABLE PROJECT OF THE AREAS INDICATED BY THE CONTRACT DOCUMENTS, AND SHALL INCLUDE ALL MATERIALS AND LABOR NECESSARY TO COMPLETE SAME, REGARDLESS OF WHETHER OR NOT EACH AND EVERY NECESSARY WORK OR ITEM IS SPECIFICALLY INDICATED ON ANY OTHER PORTION OF THE DRAWING AND/OR NOTES.
- ALL DETAILS AND SECTIONS SHOWN ON THE DRAWINGS ARE INTENDED TO BE TYPICAL AND SHALL BE CONSTRUED TO APPLY TO ANY SIMILAR SITUATION ELSEWHERE ON THE PROJECT, EXCEPT WHERE A DIFFERENT DETAIL IS SHOWN.
- CONTRACTOR SHALL FURNISH ALL ADDITIONAL DATA AND DOCUMENTATION TO SECURE ALL REQUIRED PERMITS AND SHALL COORDINATE THIS DATA WITH THE CONSTRUCTION DOCUMENTS WHERE REQUIRED.
- AS A MINIMUM, ALL WORK SHALL CONFORM TO THE APPLICABLE BUILDING CODE ADOPTED BY THE JURISDICTION OF THE WORK, WHERE MORE STRINGENT CODES ARE ADOPTED, THEY SHALL GOVERN THE WORK.
- ALL WORK SHALL CONFORM TO APPLICABLE FEDERAL, STATE, COUNTY AND LOCAL CODES AND ORDINANCES.
- TO PROVIDE ACCESSIBILITY FOR THE PHYSICALLY HANDICAPPED, ALL WORK SHALL CONFORM TO PUBLIC LAW 101-336 (AMERICANS WITH DISABILITIES ACT OF 1993).
- ALL WORK SHALL CONFORM TO THE APPLICABLE NFPA 101-LIFE SAFETY CODE ADOPTED BY THE JURISDICTION OF THE WORK.
- AROUND ALL EXPOSED PIPES, CONDUIT OR DUCTS, INSTALL ENCLOSURES OF THE SAME MATERIAL AND FINISH AS ADJACENT WORK, UNLESS NOTED OTHERWISE.
- FIELD CHECK ALL ROUGH AND/OR FINISH DIMENSIONS FOR ACCURATE FITTING OF EQUIPMENT, CABINETS, COUNTERS, FIXTURES AND ACCESSORIES BEFORE FABRICATION. PROVIDE AND INSTALL ALL NECESSARY FILLERS, SCRIBE STRIPS, PANELS, BASES OR TRIM TO COMPLETE AND FINISH INSTALLATIONS.
- ALL SWITCHES, OUTLETS, THERMOSTATS, CLOCKS, SPEAKERS OR OTHER WALL MOUNTED DEVICES OR CONTROLS SHALL BE INSTALLED IN LOCATIONS WHICH ARE UNOBSTRUCTED BY CABINETS, COUNTERS, RACKS, FIXTURES, FURNISHINGS OR EQUIPMENT. ITEMS INTENDED FOR WALL MOUNTING SHALL NOT BE INSTALLED ON, THROUGH OR INTO ANY OTHER EQUIPMENT UNLESS SPECIFICALLY CALLED FOR. VERIFY MOUNTING HEIGHTS WITH ADA REQUIREMENTS.
- PROVIDE AND INSTALL ALL NECESSARY HARDWARE, BRACKETS, BRACING, ANCHORING, INSERTS, BLOCKING, FURRING OR OTHER SUPPLEMENTARY ITEMS NEEDED FOR COMPLETE INSTALLATION OF EQUIPMENT, FIXTURES AND ACCESSORIES.
- ALL CONTRACTORS ARE TO COORDINATE THE WORK OF EACH OTHER, SO THAT THE WORK AND SCHEDULE ARE NOT IMPEDED, SCHEDULE WORK PROGRESS THROUGHOUT THE ENTIRE PROJECT TO PREVENT CONFLICTS AND INTERFERENCE. OBTAIN ALL NECESSARY INFORMATION SUCH AS SIZES, LOCATIONS, TEMPLATES, LAYOUT, DIMENSIONS AND ALL OTHER INFORMATION NECESSARY FOR A PROPER AND WELL COORDINATED INSTALLATION. PRIOR TO INSTALLATION OF ITEMS, CONFER WITH EACH CONTRACTOR EXACT LOCATION OF ALL ITEMS.
- WHERE MATERIALS REFERENCED ON DRAWINGS, OR NECESSARY TO COMPLETE THE WORK OF THIS CONTRACT ARE NOT SPECIFIED HEREIN, PROVIDE BEST QUALITY MATERIALS. WHERE MATERIALS ARE INTENDED TO MATCH EXISTING, PROVIDE CLOSEST POSSIBLE MATCH, SUBJECT TO OWNER'S APPROVAL. ALL ITEMS AND WORK ON DRAWINGS ARE NEW UNLESS INDICATED OTHERWISE. ALL WORK WHICH HAS BEEN DAMAGED SHALL BE REPAIRED OR REPLACED, WHERE ITEM CANNOT BE REPAIRED TO A "NEW CONDITION", OR WHERE THE STRUCTURAL INTEGRITY HAS BEEN AFFECTED, ITEM SHALL BE REPLACED.
- CONTRACTOR SHALL OBTAIN FROM OWNER ALL REQUIREMENTS FOR INSTALLATION OF OWNER PROVIDED EQUIPMENT INCLUDING ROUGHING DIAGRAMS, INSTALLATION INSTRUCTIONS, ELECTRICAL SCHEMATICS, TEMPLATES, LAYOUTS AND DIMENSIONS AND ALL OTHER INFORMATION NECESSARY FOR A PROPER, WELL COORDINATED INSTALLATION. PRIOR TO ROUGH-IN SERVICES, CONFER WITH OWNER EXACT LOCATION OF ALL ITEMS.

GENERAL SHEET NOTES

- COORDINATE DEVICE MOUNTING HEIGHTS FOR MILLWORK AND FURNITURE WITH ARCHITECTURAL DRAWINGS.

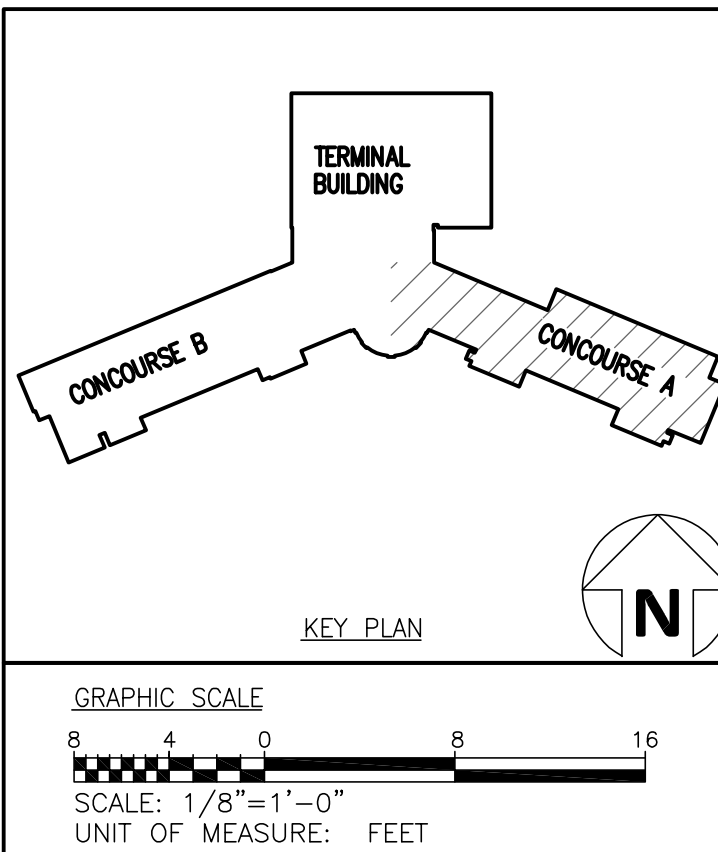

Fayetteville Regional Airport — Airline Terminal Improvements Part 2


SECOND FLOOR PLAN — AREA D — SECURITY

400 Airport Road
Fayetteville, North Carolina 28306

DRAWN BY: JMT
REVIEWED BY: JMT
DATE: 07-18-19
PROJECT NO.: 1808

REVISIONS
A MODIFIED 08/14/19
SHEET NUMBER
TY1.02D


ENLARGED PLAN – TELECOM ROOM B129

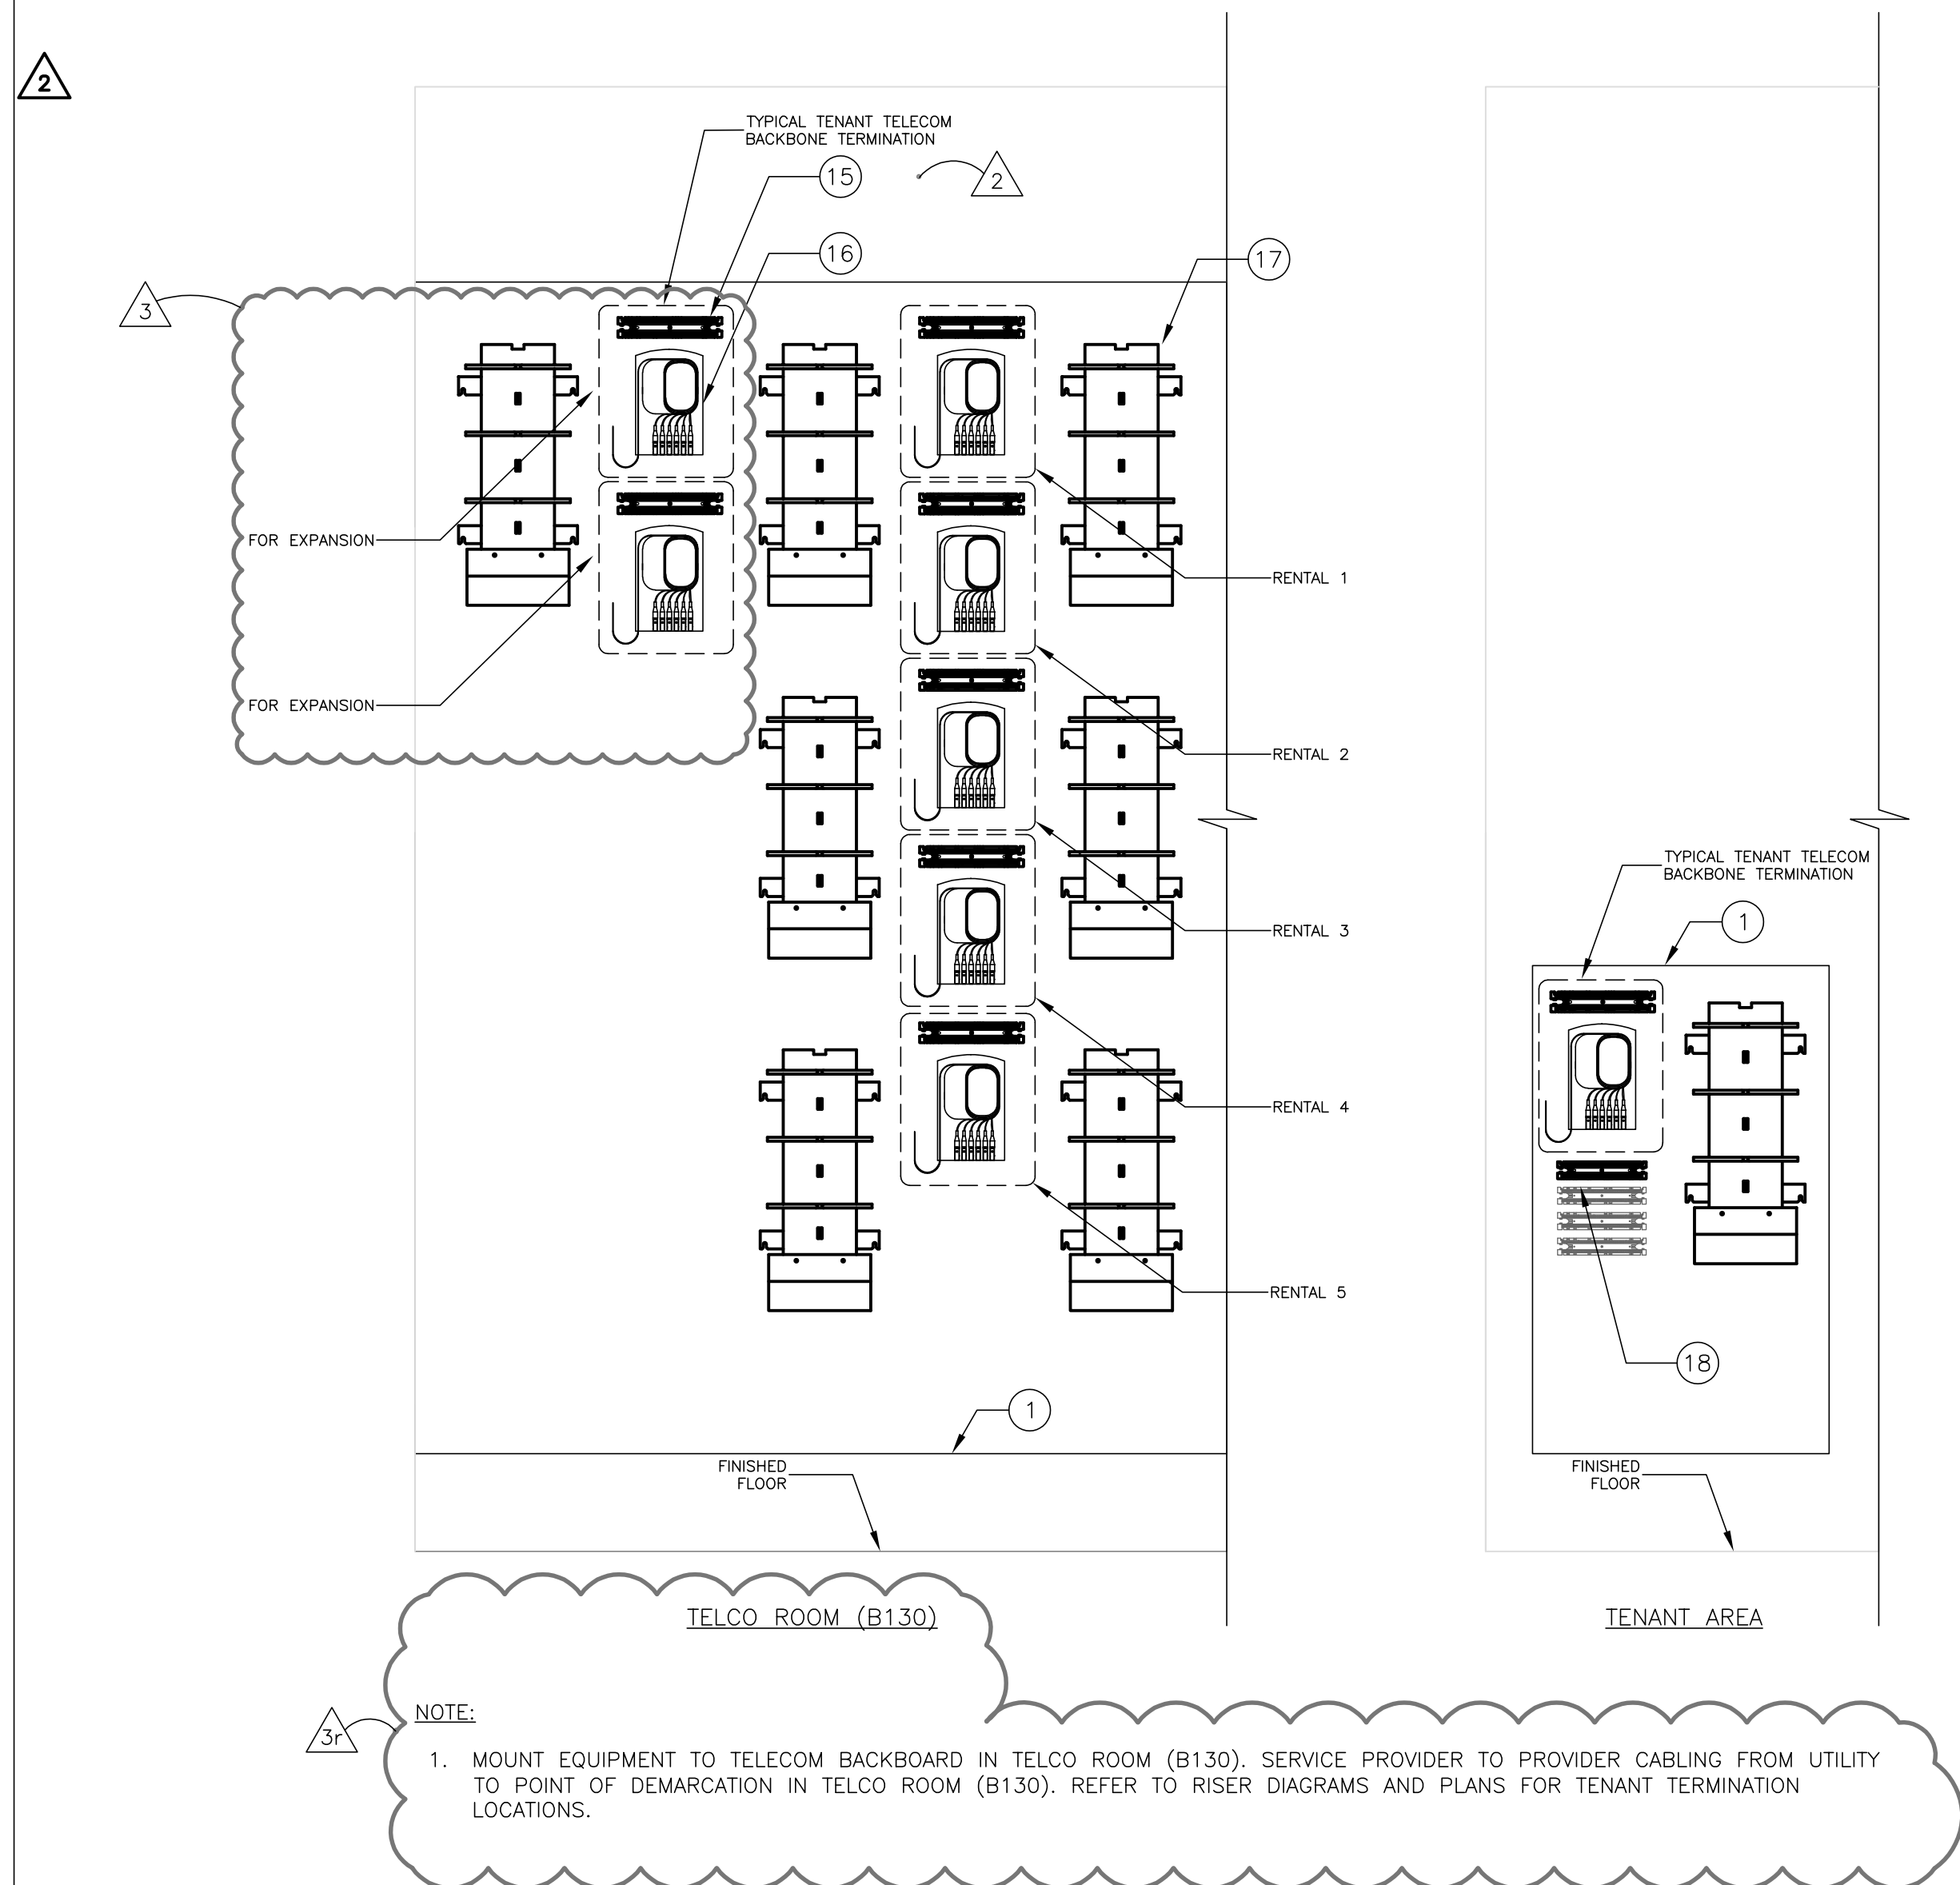SCALE:
1/2"=1'-0" 1

TENANT BACKBONE CABLING DISTRIBUTION

SCALE:
NONE 3

RACK ELEVATION 1

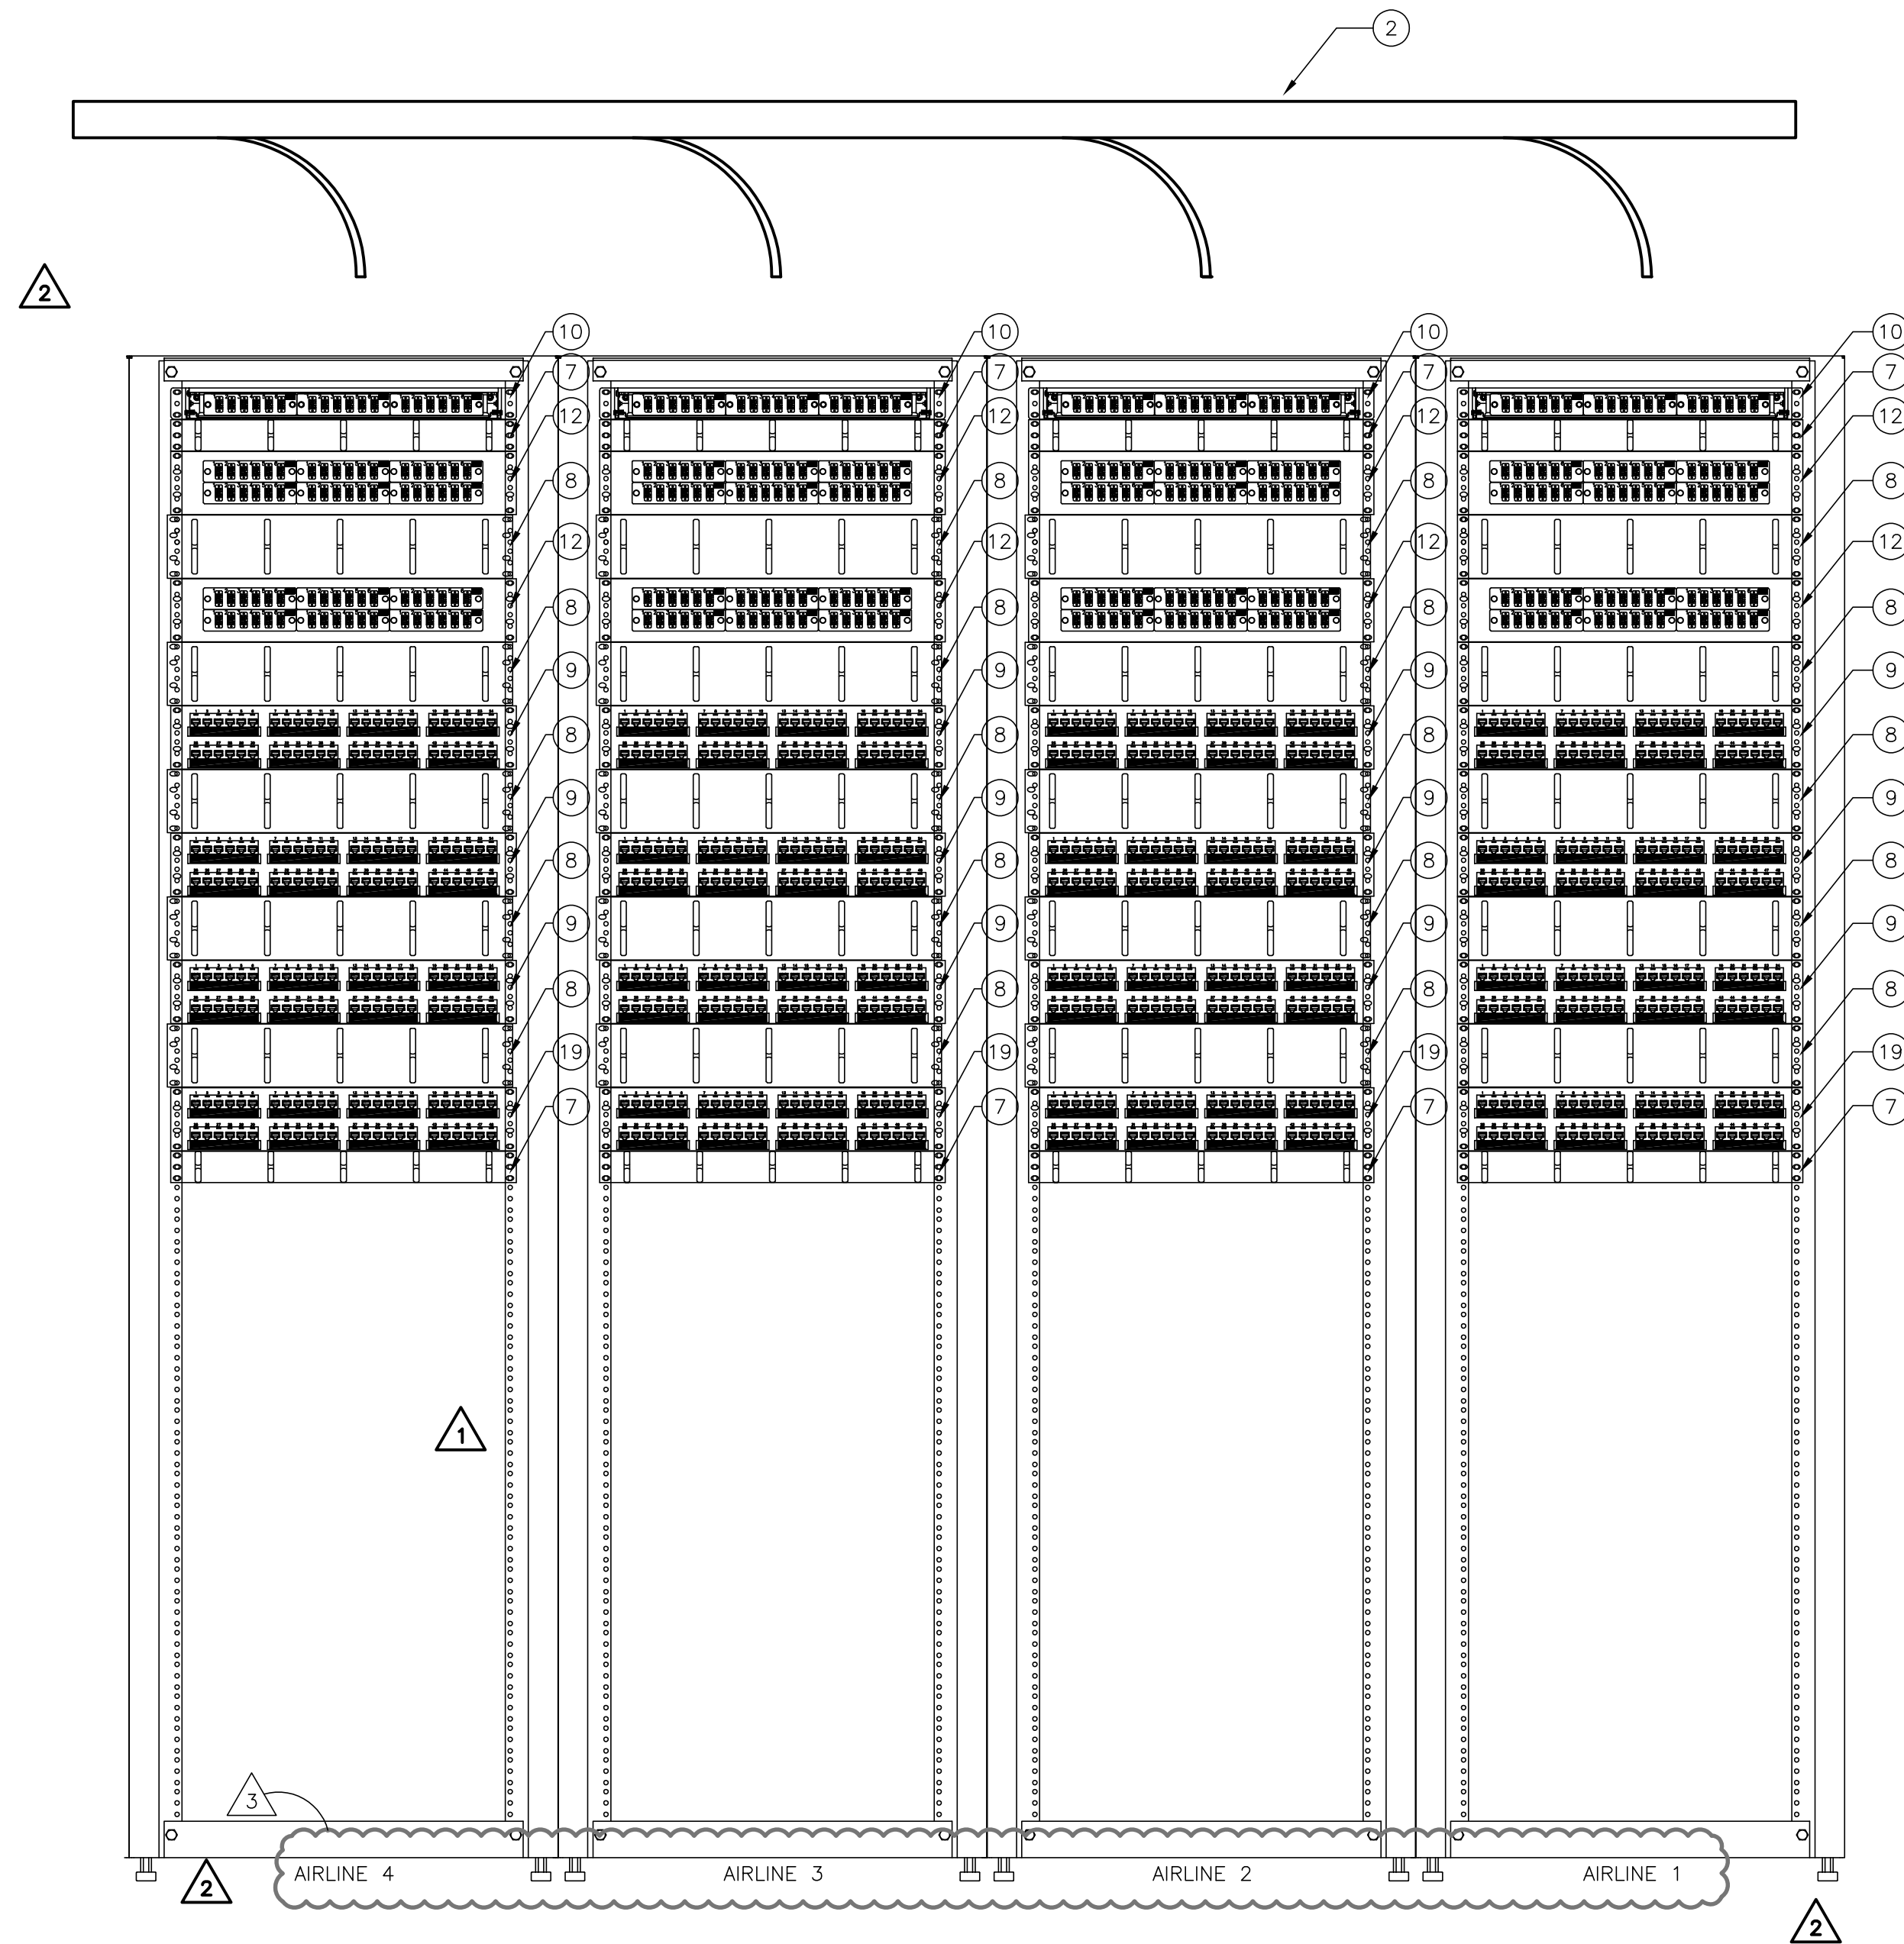SCALE:
NONE 2

RACK ELEVATION 2


SCALE:
NONE 4

GENERAL NOTES

- A. CONTRACTOR SHALL FIELD VERIFY ALL DIMENSIONS AND SITE CONDITIONS BEFORE COMMENCING WORK.
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- C. ALL DETAILS AND SECTIONS SHOWN ON THE DRAWINGS ARE INTENDED TO BE TYPICAL AND SHALL BE CONSTRUCTED TO APPLY TO ANY SIMILAR SITUATION ELSEWHERE ON THE PROJECT, EXCEPT WHERE A DIFFERENT DETAIL IS SHOWN.
- D. AS A MINIMUM, ALL WORK SHALL CONFORM TO THE APPLICABLE BUILDING CODE ADOPTED BY THE JURISDICTION OF THE WORK, WHERE MORE STRINGENT CODES ARE ADOPTED, THEY SHALL GOVERN THE WORK.
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- G. AROUND ALL EXPOSED PIPES, CONDUIT OR DUCTS, INSTALL ENCLOSURES OF THE SAME MATERIAL AND FINISH AS ADJACENT WORK, UNLESS NOTED OTHERWISE.
- H. FIELD CHECK ALL ROUGH AND/OR FINISH DIMENSIONS FOR ACCURATE FITTING OF EQUIPMENT, CABINETS, COUNTERS, FIXTURES AND ACCESSORIES BEFORE FABRICATION, PROVIDE AND INSTALL ALL NECESSARY FILLERS, SCRIBE STRIPS, PANELS, BASES OR TRIM TO COMPLETE AND FINISH INSTALLATIONS.
- I. ALL SWITCHES, OUTLETS, THERMOSTATS, CLOCKS, SPEAKERS OR OTHER WALL MOUNTED DEVICES OR CONTROLS SHALL BE INSTALLED IN LOCATIONS WHICH ARE UNOBSTRUCTED BY CABINETS, COUNTERS, RACKS, FIXTURES, FURNISHINGS OR EQUIPMENT. ITEMS INTENDED FOR WALL MOUNTING SHALL NOT BE INSTALLED ON, THROUGH OR INTO ANY OTHER EQUIPMENT UNLESS SPECIFICALLY CALLED FOR. VERIFY MOUNTING HEIGHTS WITH ADA REQUIREMENTS.
- J. PROVIDE AND INSTALL ALL NECESSARY HARDWARE, BRACKETS, BRACING, ANCHORING, INSERTS, BLOCKING, FURRING OR OTHER SUPPLEMENTARY ITEMS NEEDED FOR COMPLETE INSTALLATION OF EQUIPMENT, FIXTURES AND ACCESSORIES.
- K. ALL CONTRACTORS ARE TO COORDINATE THE WORK OF EACH OTHER, SO THAT THE WORK AND SCHEDULE ARE NOT IMPEDED. SCHEDULE WORK PROGRESS THROUGHOUT THE ENTIRE PROJECT TO PREVENT CONFLICTS AND INTERFERENCE. OBTAIN ALL NECESSARY INFORMATION SUCH AS SIZES, LOCATIONS, TEMPLATES, LAYOUT, DIMENSIONS AND ALL OTHER INFORMATION NECESSARY FOR A PROPER AND WELL COORDINATED INSTALLATION. PRIOR TO INSTALLATION OF ITEMS, CONFER WITH EACH CONTRACTOR EXACT LOCATION OF ALL ITEMS.
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- M. CONTRACTOR SHALL OBTAIN FROM OWNER ALL REQUIREMENTS FOR INSTALLATION OF OWNER PROVIDED EQUIPMENT INCLUDING ROUTING DIAGRAMS, INSTALLATION INSTRUCTIONS, ELECTRICAL SCHEMATICS, TEMPLATES, LAYOUTS AND DIMENSIONS AND ALL OTHER INFORMATION NECESSARY FOR A PROPER, WELL COORDINATED INSTALLATION. PRIOR TO ROUGH-IN SERVICES, CONFER WITH OWNER EXACT LOCATION OF ALL ITEMS.
- N. ALL CABLES SHALL BE NEATLY BUNDLED AND DRESSED INTO GROUPS OF NO MORE THAN 24 CABLES.
- O. ALL CABLES SHALL BE ROUTED USING VERTICAL AND HORIZONTAL MANAGEMENT SYSTEMS.
- P. COORDINATE CONDUIT AND POWER SYSTEMS TO BE INSTALLED IN TELECOMMUNICATIONS ROOMS.

DRAWING NOTES:


- 1 3/4" PLYWOOD, AC GRADE, VOID FREE, FIRE-RETARDANT WITH RATING STAMP VISIBLE. MOUNT PLYWOOD AT 8-IN ABOVE FINISHED FLOOR.
- 2 12-IN CABLE RUNWAY. MOUNT AT 8-FT ABOVE FINISHED FLOOR.
- 3 20-IN X 2-IN TELECOMMUNICATIONS GROUND BAR, MOUNTED AT 12-IN ABOVE FINISHED FLOOR.
- 4 FOUR (4) 4-IN EMT SLEEVES BETWEEN ROOM B129 AND B130. MAINTAIN FIRE RATING OF WALL AFTER CABLE INSTALLATION.
- 5 45RU TELECOMMUNICATIONS CABINET, 36-IN DEEP, WITH KEYED LOCKABLE DOORS. EACH USER MUST HAVE A SEPARATE KEY.
- 6 12-IN WIDE RADIUS DROPOUT, MOUNTED TO CABLE RUNWAY. ALIGN WITH CABINET CABLE MANAGEMENT SYSTEM.
- 7 1RU HORIZONTAL CABLE MANAGEMENT
- 8 2RU HORIZONTAL CABLE MANAGEMENT
- 9 2RU 48-PORT CATEGORY 6 PATCH PANEL, FOR HORIZONTAL CABLING
- 10 1RU FIBER OPTIC PATCH PANEL WITH OS2 LC MODULES, FOR BACKBONE CABLING
- 11 1RU FIBER OPTIC PATCH PANEL WITH OM3 LC MODULES, FOR BACKBONE CABLING
- 12 2RU FIBER OPTIC PATCH PANEL WITH OM3 LC MODULES, FOR HORIZONTAL CABLING.
- 13 45RU TELECOMMUNICATIONS CABINET, 42-IN DEEP, WITH KEYED LOCKABLE DOORS. CABINETS MAY NOT USE CH-751 TYPE LOCKS. PROVIDE UNIQUE LOCK AND KEY FOR EACH CABINET. EACH USER MUST HAVE A SEPARATE KEY.
- 14 NOT USED.
- 15 25-PAIR CAT5 COPPER WALL MOUNT BLOCK.
- 16 6-STRAND FIBER SPLICER AND TERMINATION WALL BOX INCLUDE CABLE LOOP, SPLICER MANAGEMENT, AND 6 LC CONNECTIONS.
- 17 WALL MOUNT CABLE MANAGEMENT.
- 18 TENANT STATION CABLING DISTRIBUTION PROVIDE CAT6 110 BLOCKS TO SUPPORT ALL TENANT STATION CABLING.
- 19 2RU CATEGORY 3 PATCH PANEL, FOR BACKBONE CABLING.
- 20 CONTRACTOR SHALL PROVIDE ALL NECESSARY CONNECTIONS FROM EXISTING AIRLINE CABLING IN B130 TO NEW AIRLINE RACKS IN B129. COORDINATE THIS EFFORT IN FIELD WITH AIRLINE IT PERSONNEL.

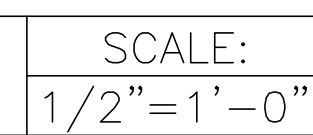

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SHEET ADDED


T4.02

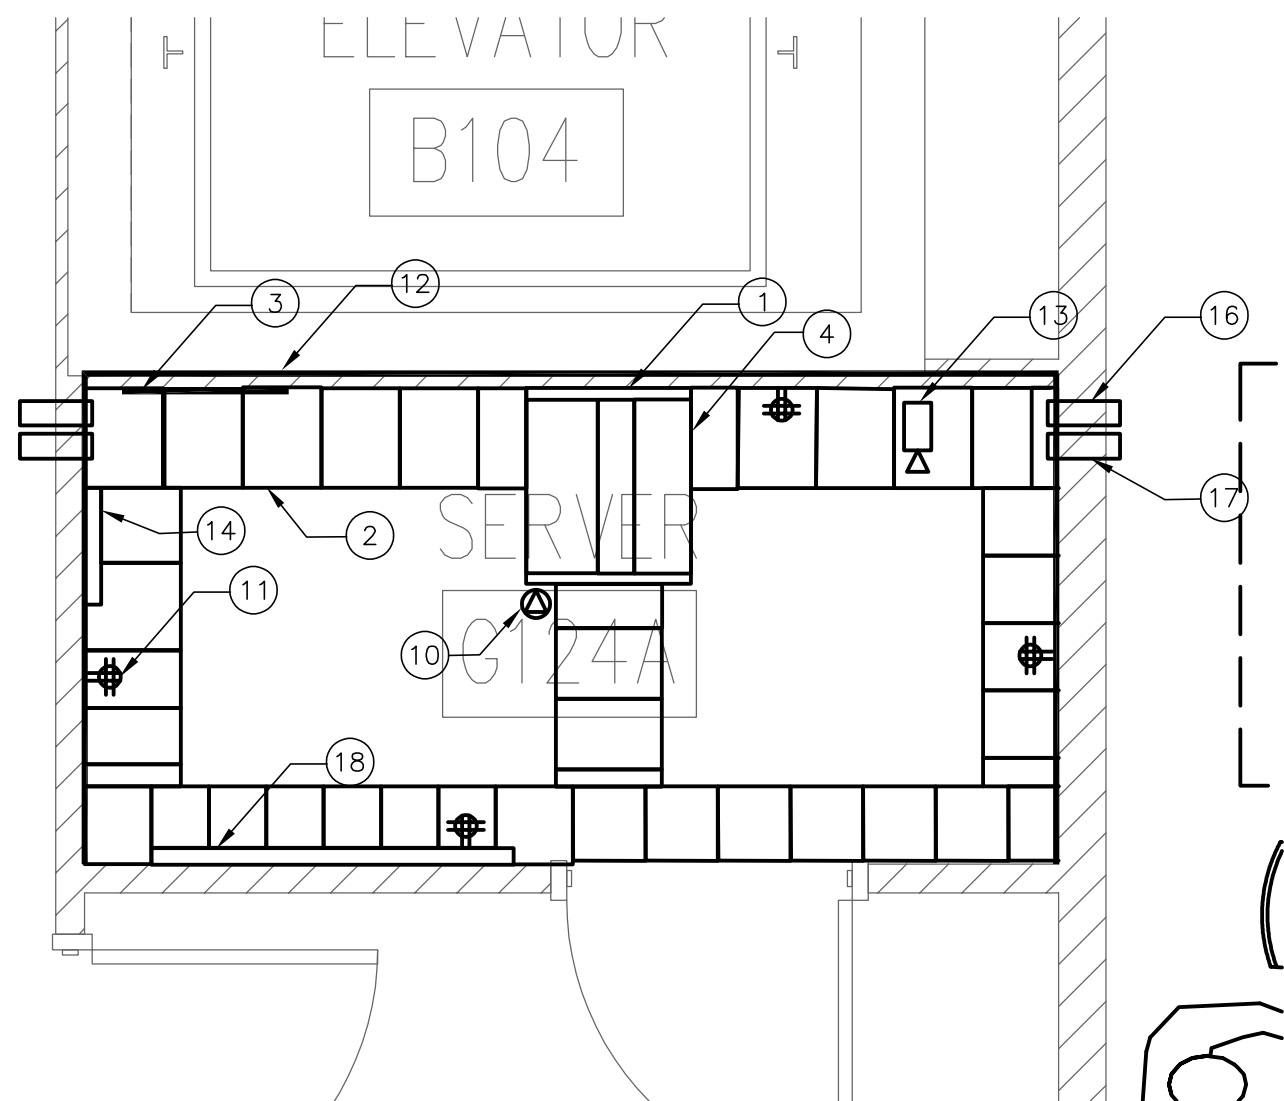

ENLARGED PLAN – SERVER G124A

SCALE:
1/2"=1'-0"

1

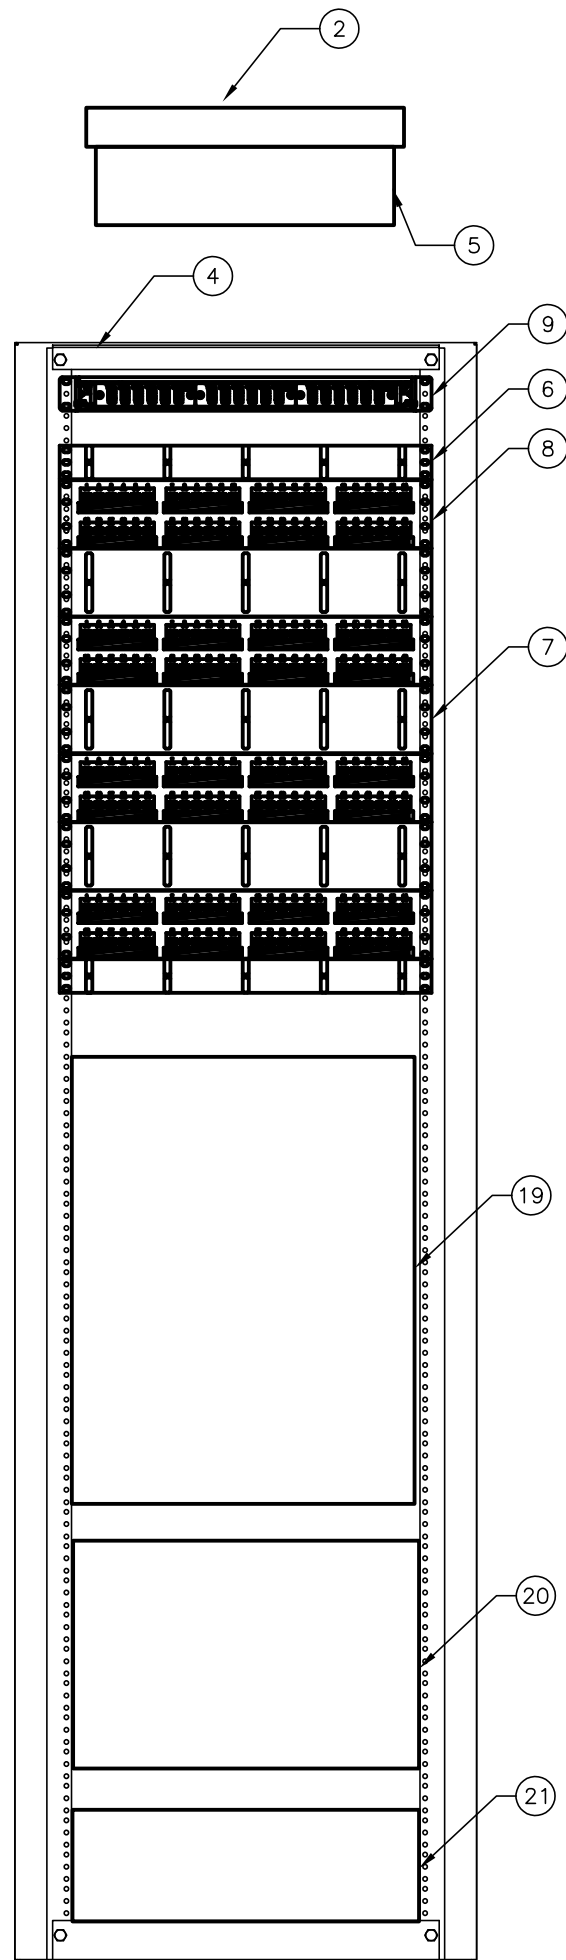

RACK ELEVATION 1

SCALE:
NONE

2

DRAWING NOTES:

- 1 3-IN VERTICAL CABLE MANAGEMENT
- 2 12" CABLE RUNWAY, MOUNT AT 8'-0" AFF
- 3 20-IN X 2-IN TELECOMMUNICATIONS GROUND BAR, MOUNTED AT 12-IN ABOVE FINISHED FLOOR.
- 4 45RU TELECOMMUNICATIONS RACK
- 5 12-IN WIDE RADIUS DROPOUT, MOUNTED TO CABLE RUNWAY. ALIGN WITH CABINET CABLE MANAGEMENT SYSTEM.
- 6 1RU HORIZONTAL CABLE MANAGEMENT
- 7 2RU HORIZONTAL CABLE MANAGEMENT
- 8 2RU 48-PORT CATEGORY 6 PATCH PANEL, FOR HORIZONTAL CABLING
- 9 1RU FIBER OPTIC PATCH PANEL WITH OM3 LC MODULES, FOR BACKBONE CABLING
- 10 CEILING MOUNTED NEMA L5-30P OUTLET-30 AMP/120 VAC COORDINATE IN FIELD TO MATCH PROJECT STANDARD
- 11 QUAD OUTLET - 20 AMP/120 VAC
- 12 3/4" FIRE-RETARDANT PLYWOOD
- 13 WALL MOUNT SECURITY CAMERA. SEE SECURITY DRAWINGS AND CAMERA SCHEDULE.
- 14 WALL MOUNT 100-PR 110 BLOCK, FOR TERMINATION OF COPPER BACKBONE CABLING. MOUNT AT 6'-0" AFF
- 15 3-IN VERTICAL CABLE MANAGEMENT
- 16 4" CONDUIT SLEEVE, FOR SECOND FLOOR STATION AND SECURITY CABLING DISTRIBUTION
- 17 4" CONDUIT SLEEVE, FOR FUTURE GROWTH
- 18 RESERVE SPACE FOR WALL MOUNT ACCESS CONTROL UNITS
- 19 15RU RACK SPACE RESERVED FOR OFE ACTIVE NETWORK EQUIPMENT.
- 20 5RU RACK SPACE RESERVED FOR EXISTING ACTIVE SECURITY EQUIPMENT
- 21 4RU RACK SPACE RESERVED FOR OFE UPS AND POWER SUPPLY

SHEET ADDED

Fayetteville Regional Airport – Airline Terminal Improvements Part 2


400 Airport Road
Fayetteville, North Carolina 28306

DRAWN BY: JMT
REVIEWED BY: JMT
DATE: 07-19-19
PROJECT NO.: 1808

REVISIONS	
3	08/10/20
7	11/30/20
11	


SHEET NUMBER

T4.03

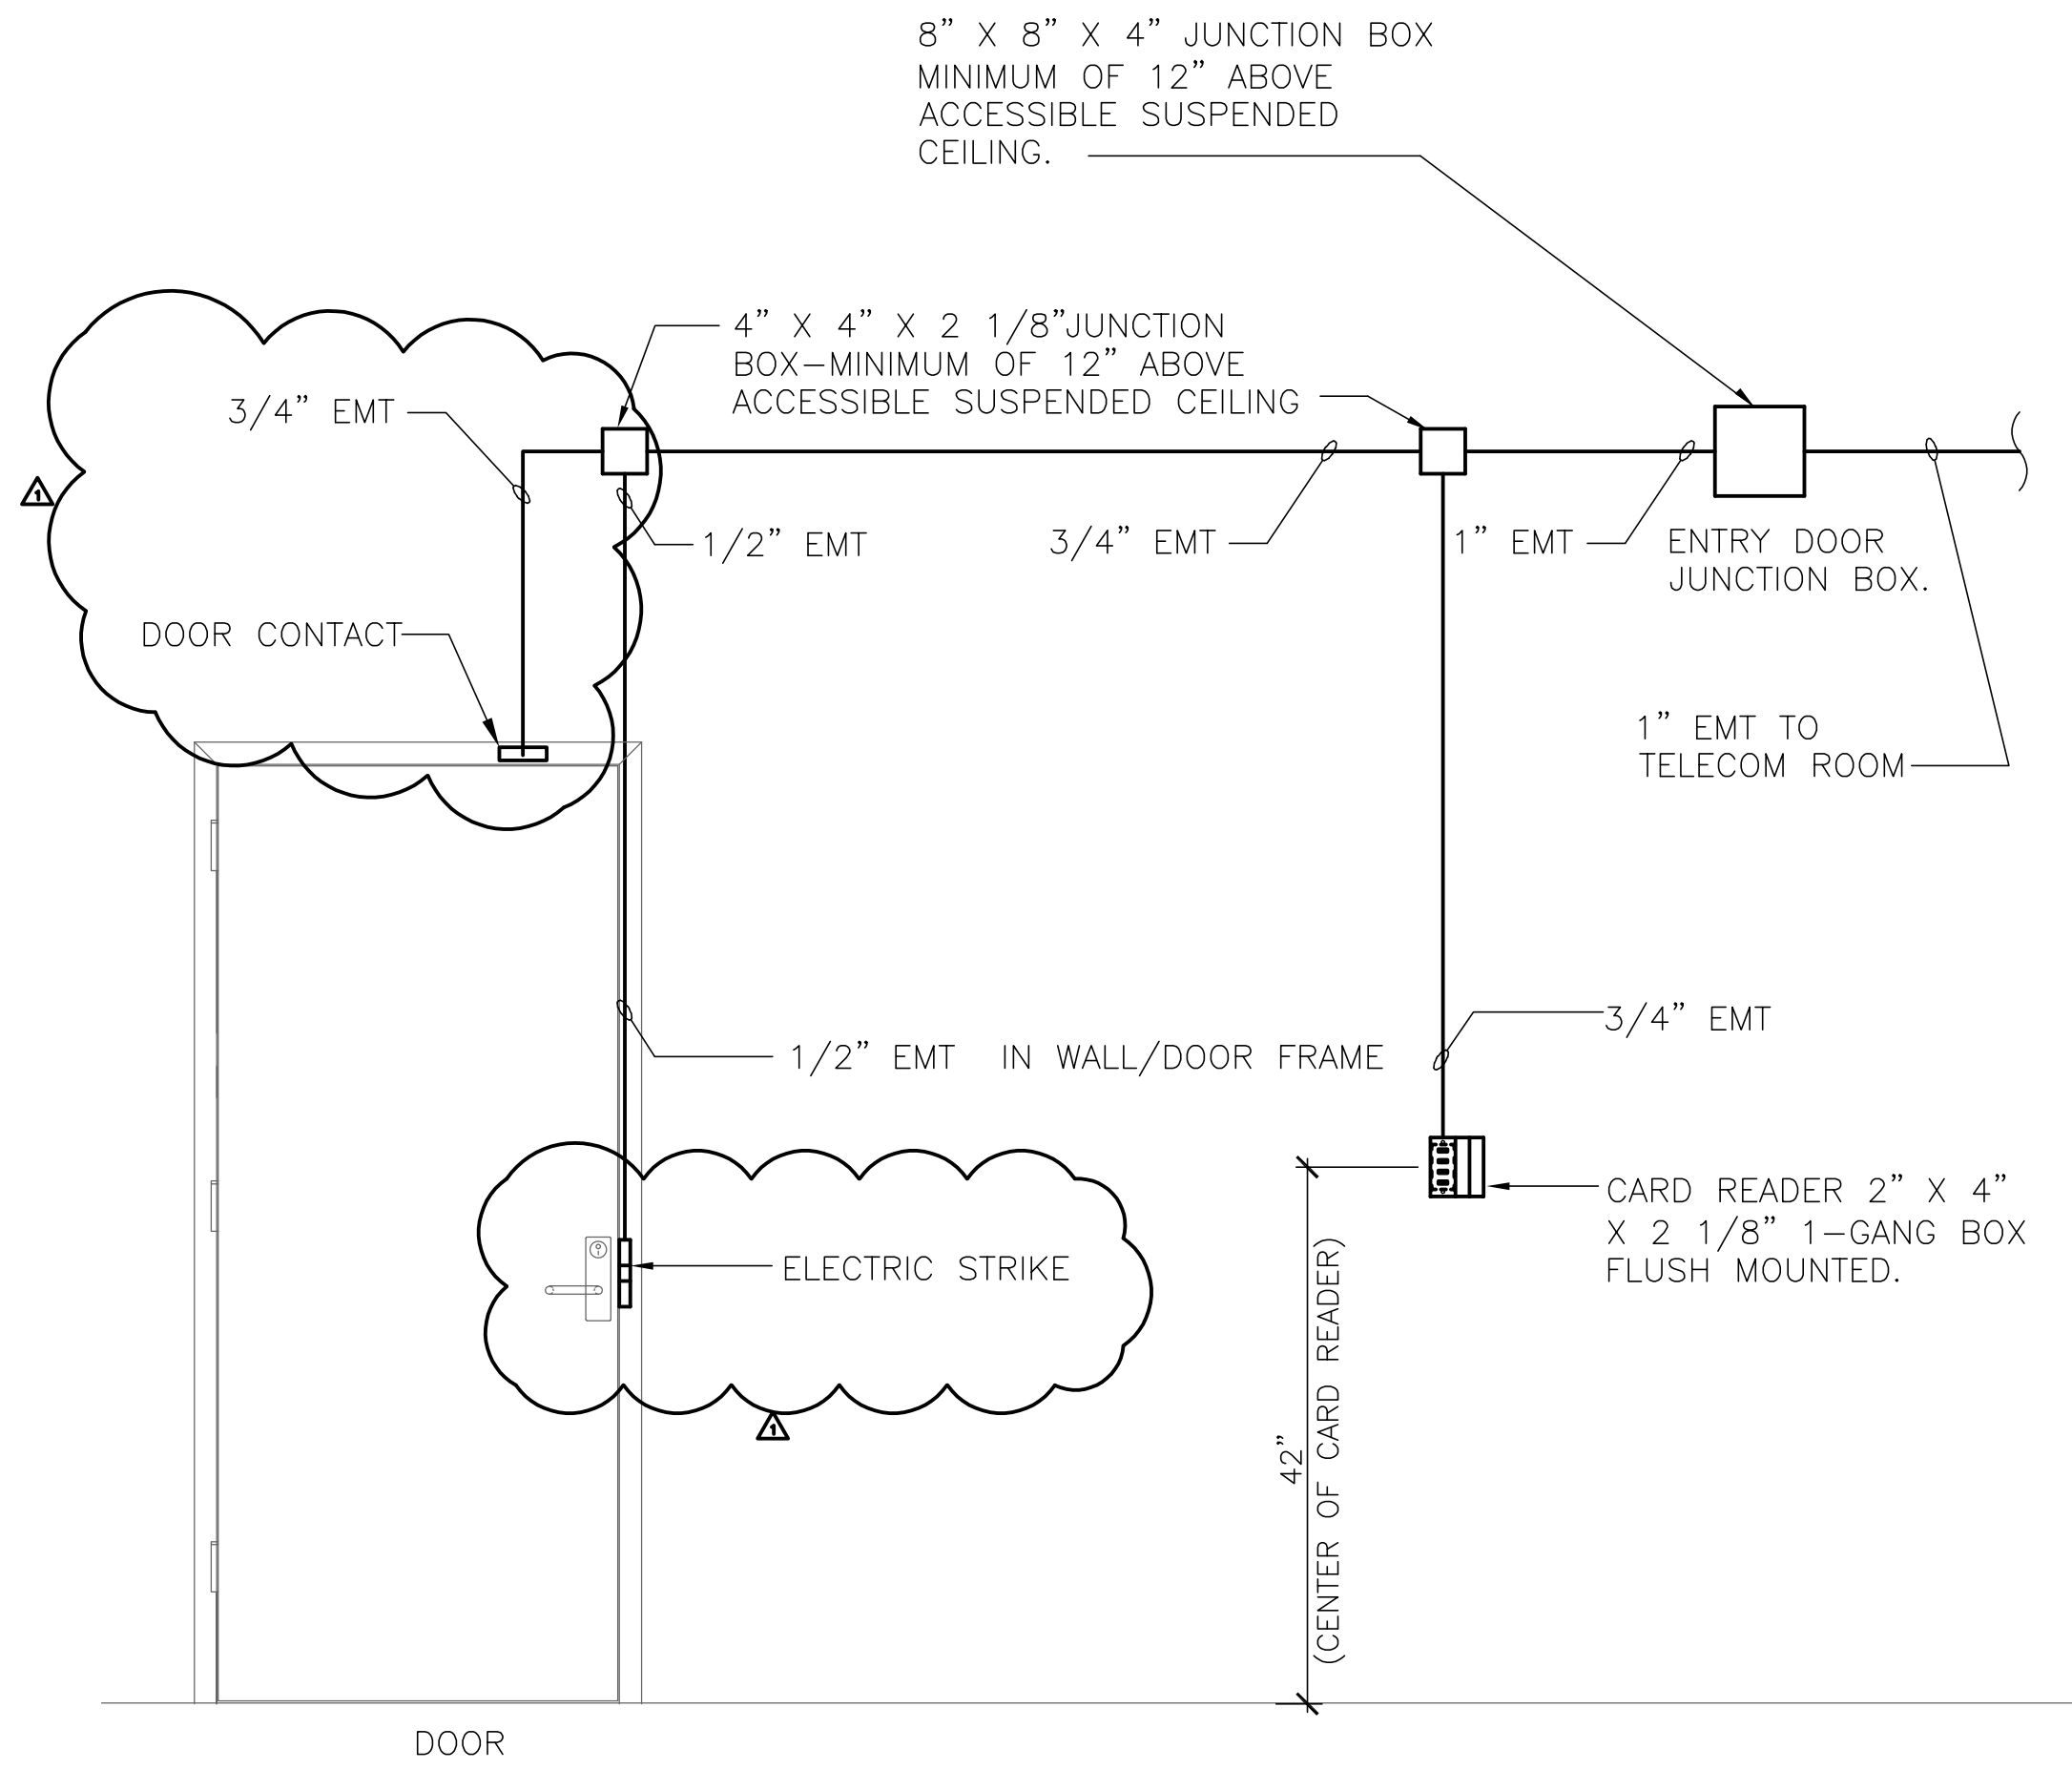

GENERAL NOTES

1. PROVIDE (1) CAT 6 CABLE FROM EACH CARD READER LOCATION TO TELECOM ROOM.
2. PROVIDE PULL WIRES IN ALL CONDUITS.

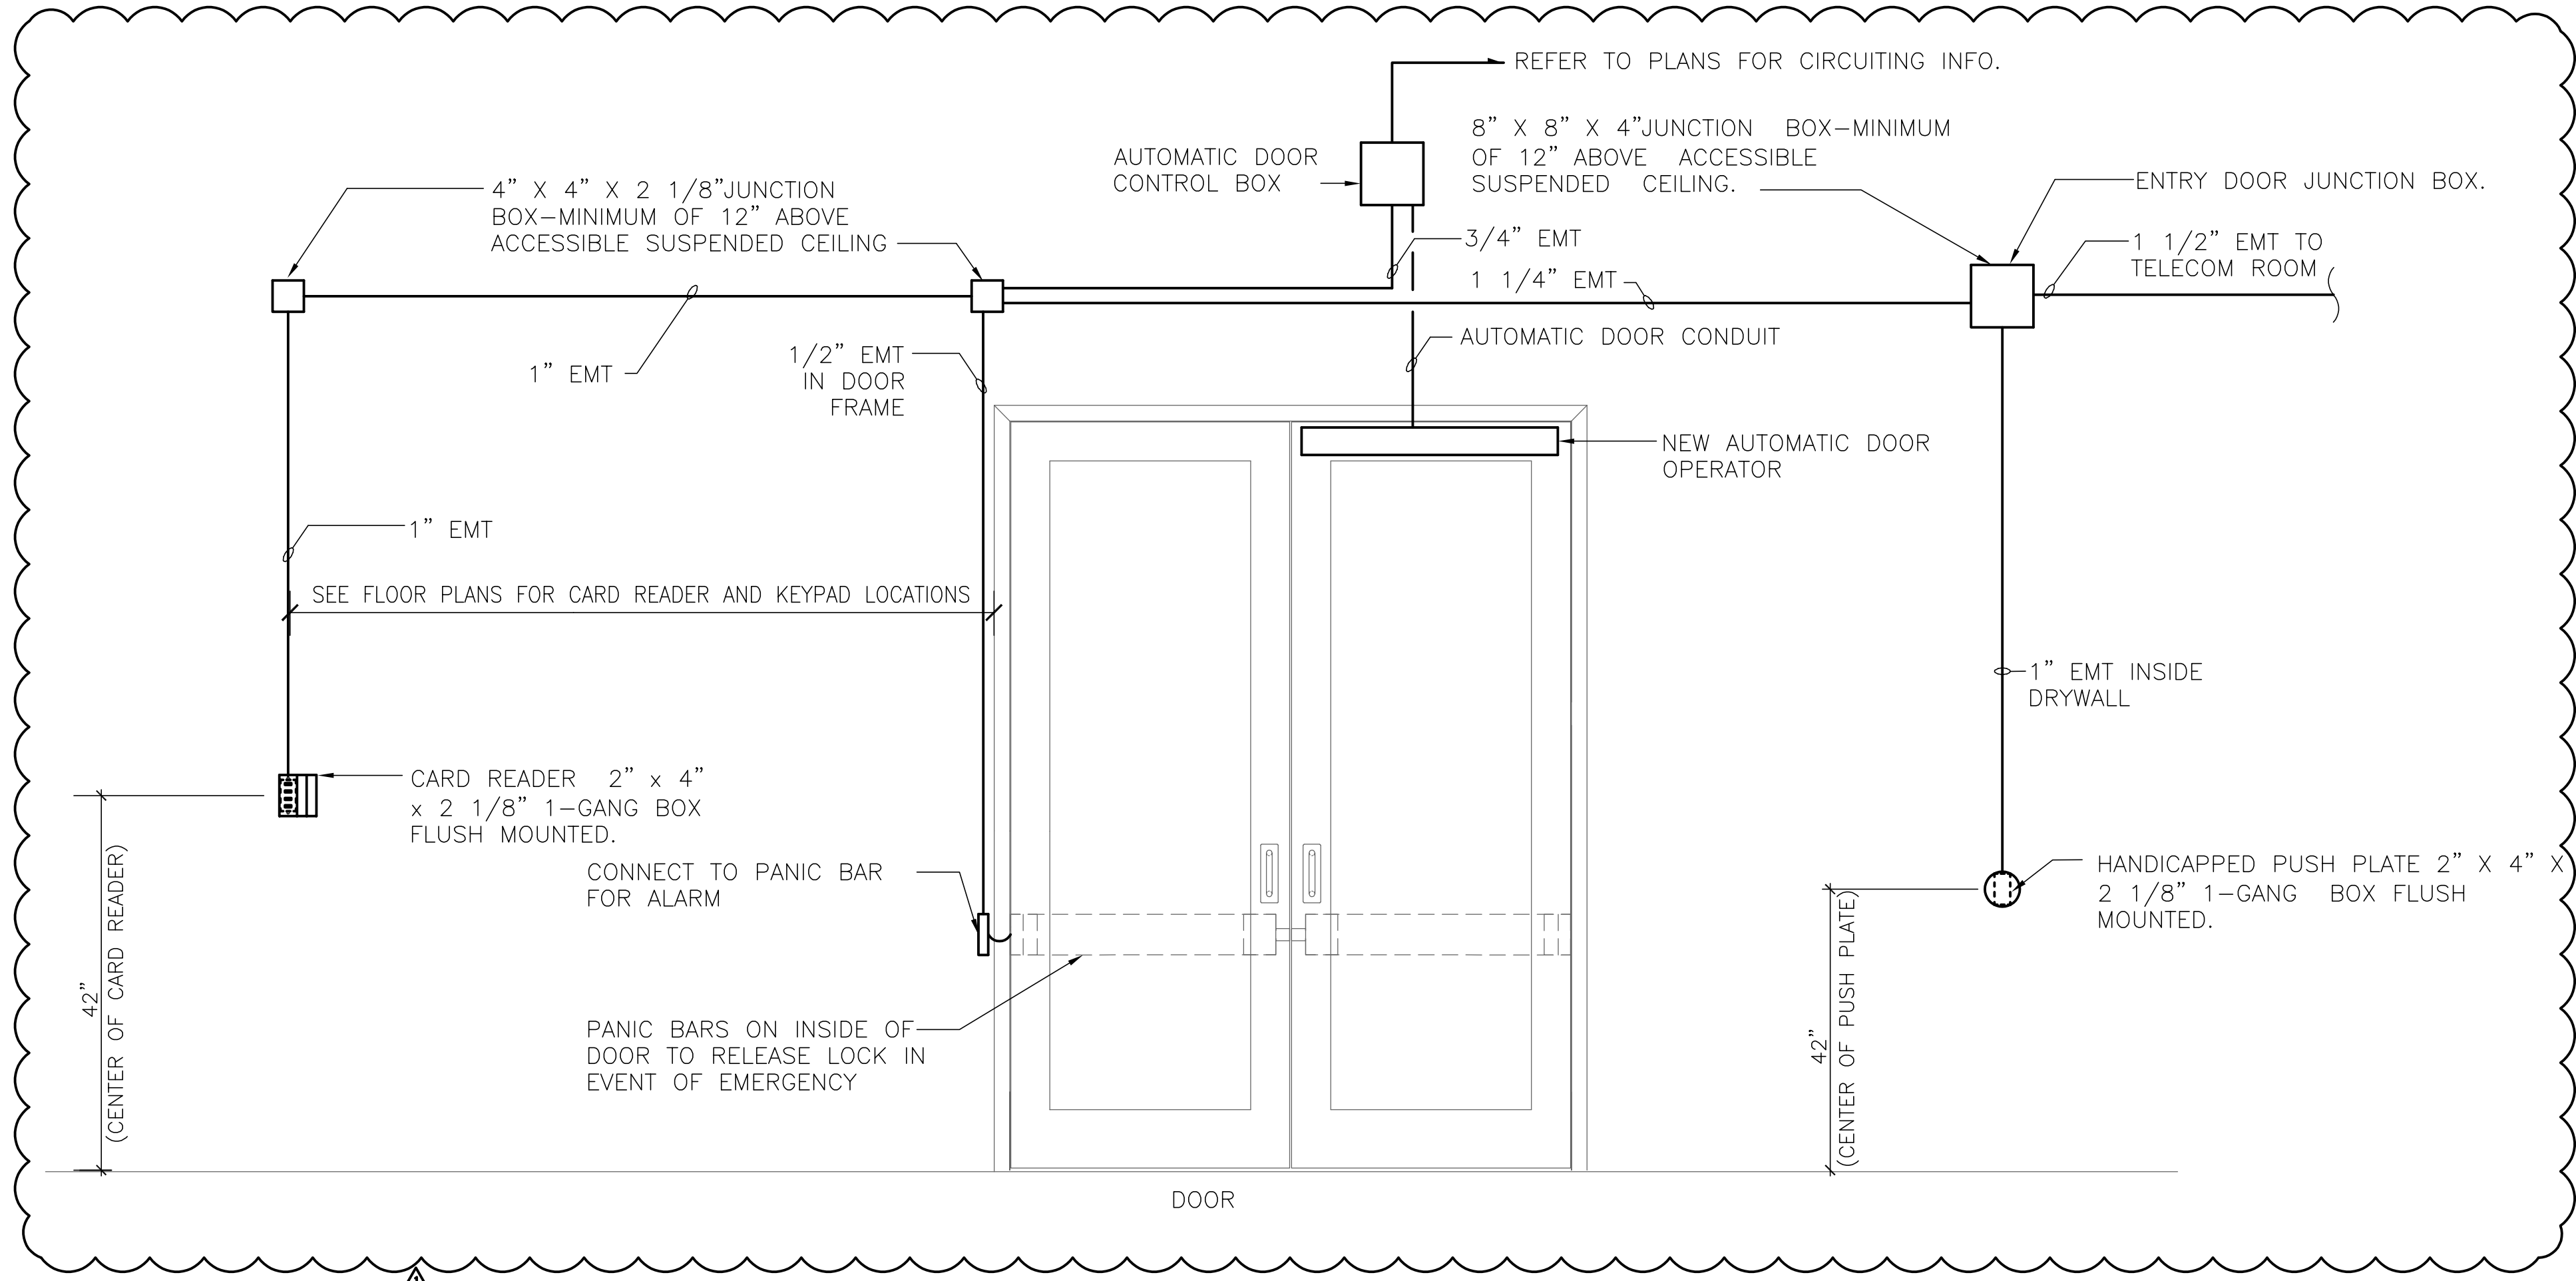

GENERAL NOTES


1. PROVIDE (1) CAT 6 CABLE FROM EACH CARD READER LOCATION TO TELECOM ROOM.
2. PROVIDE PULL WIRES IN ALL CONDUITS.

ACCESS CONTROL – SINGLE DOOR WITH READER DETAIL

SCALE: NONE 1


ACCESS CONTROL – DOUBLE DOOR DETAIL

SCALE: NONE 2

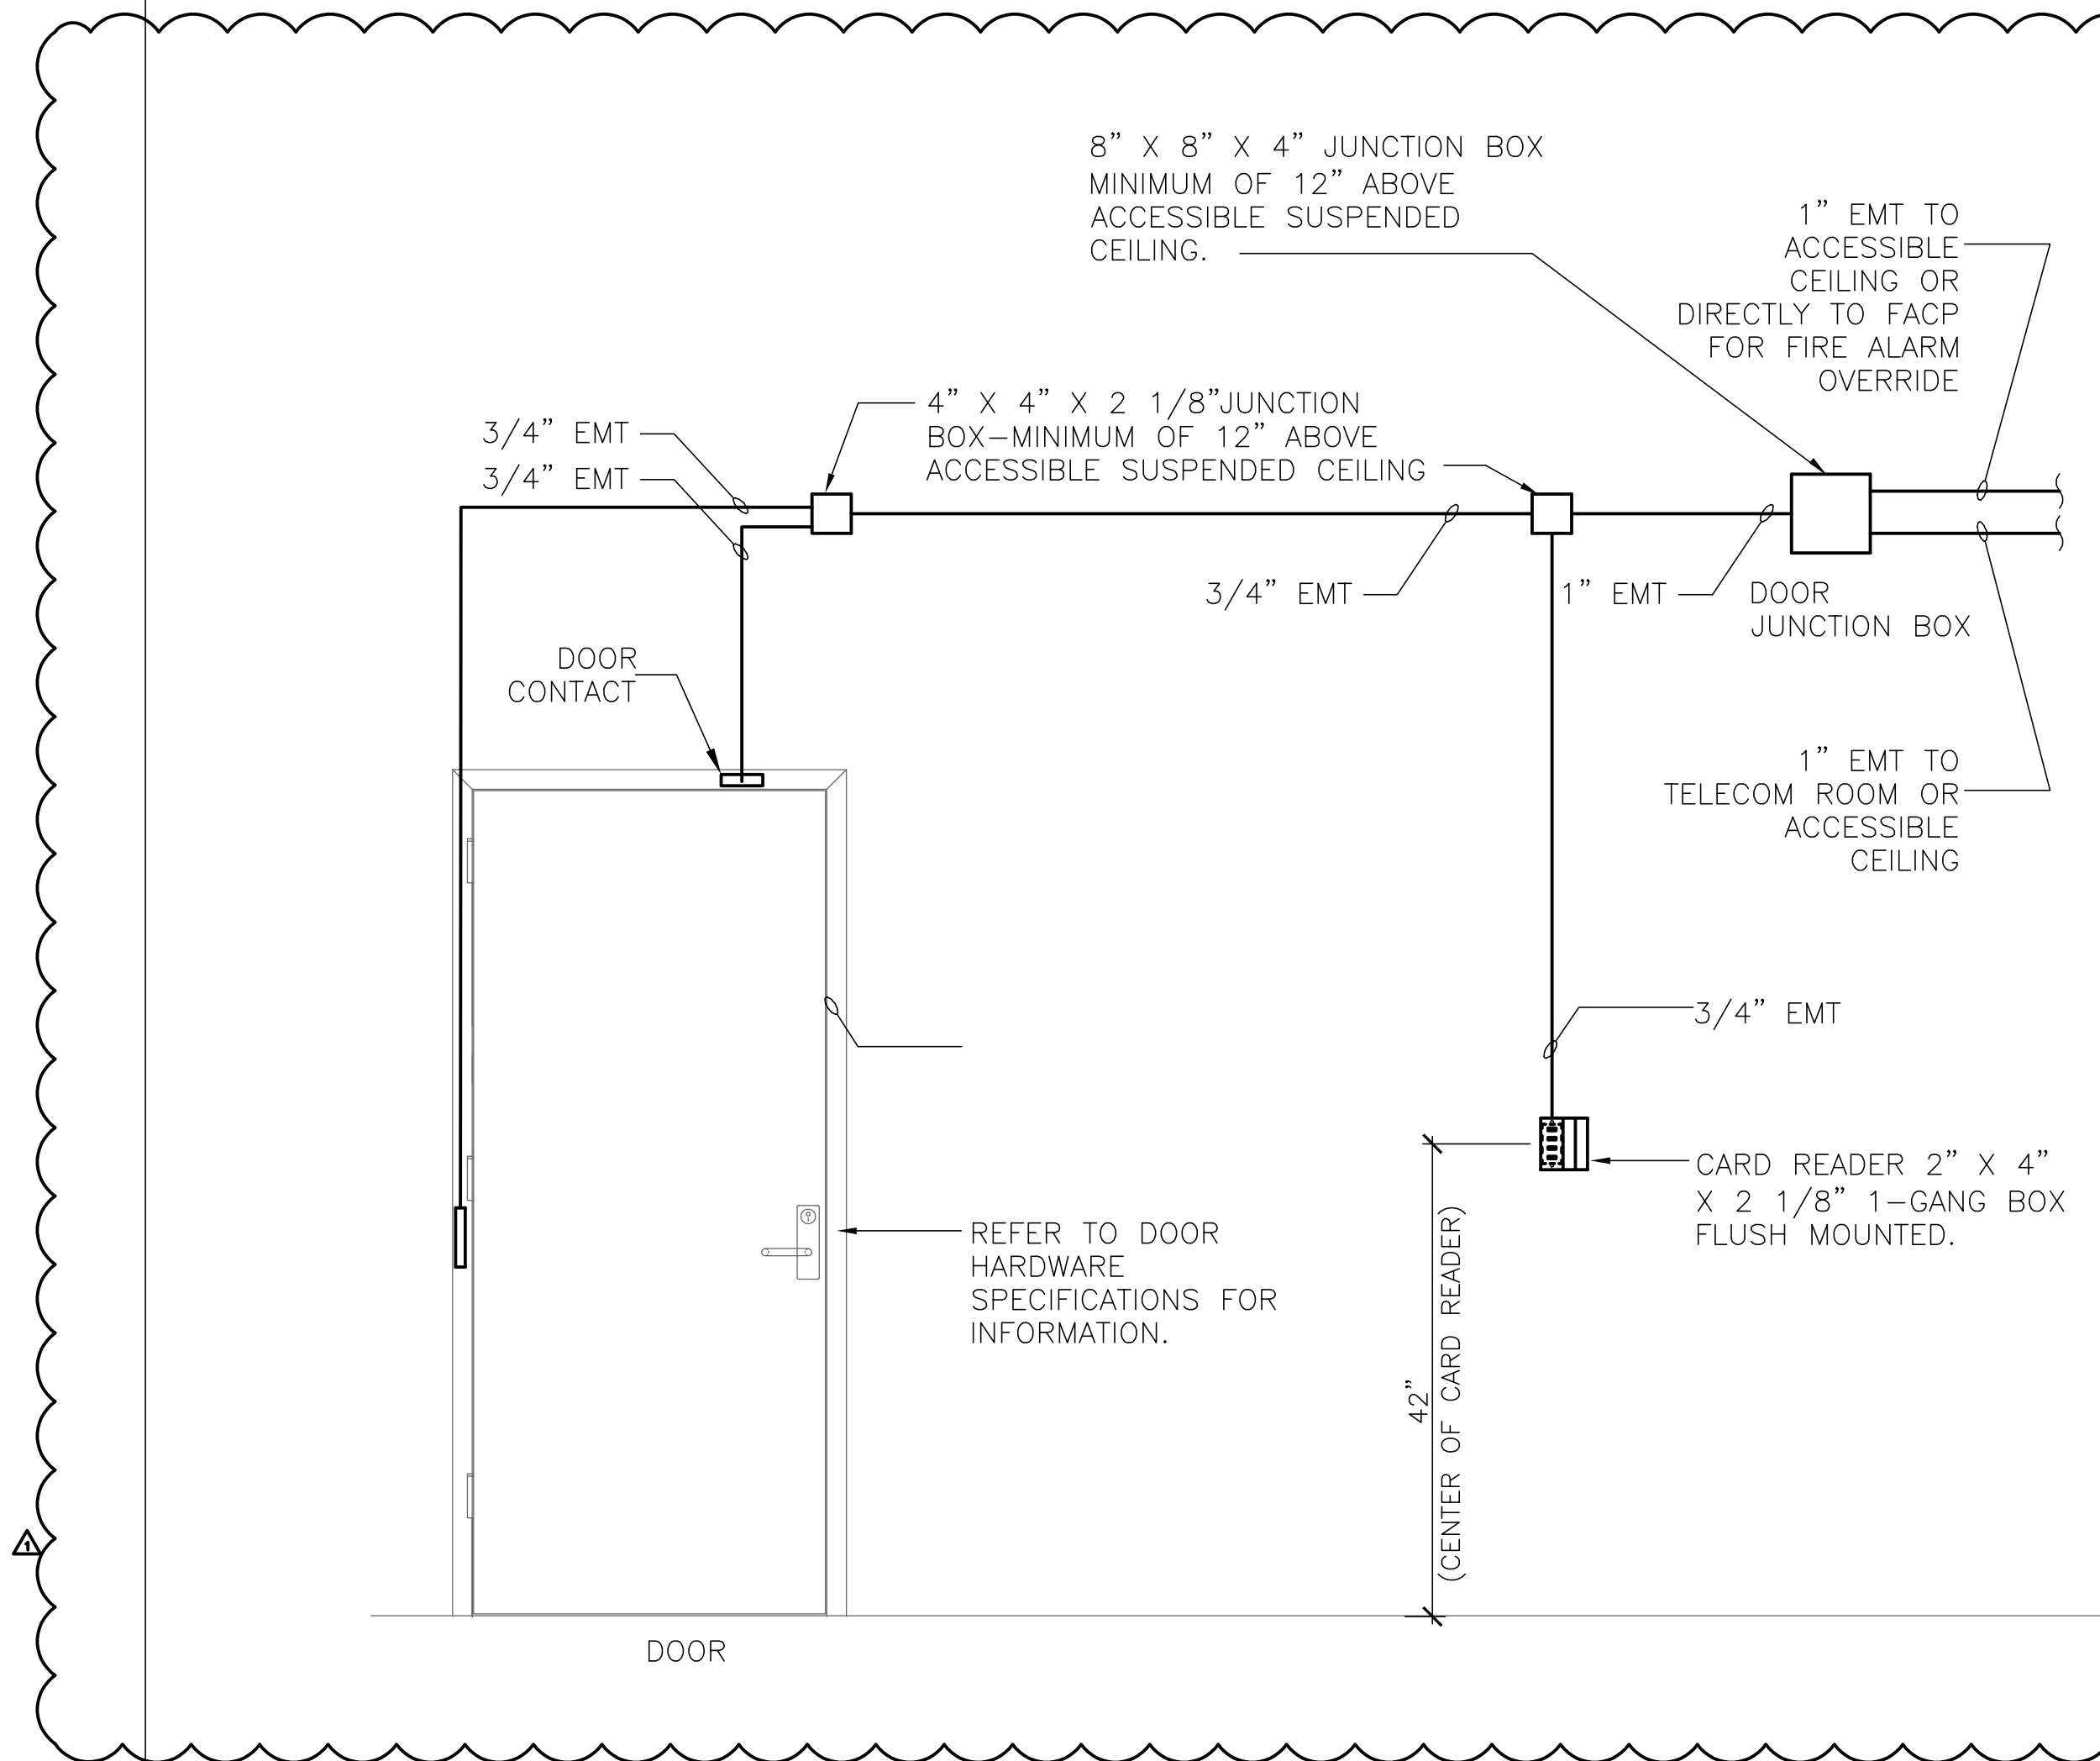


ACCESS CONTROL – THROUGH-HINGE DETAIL

SCALE: NONE 3

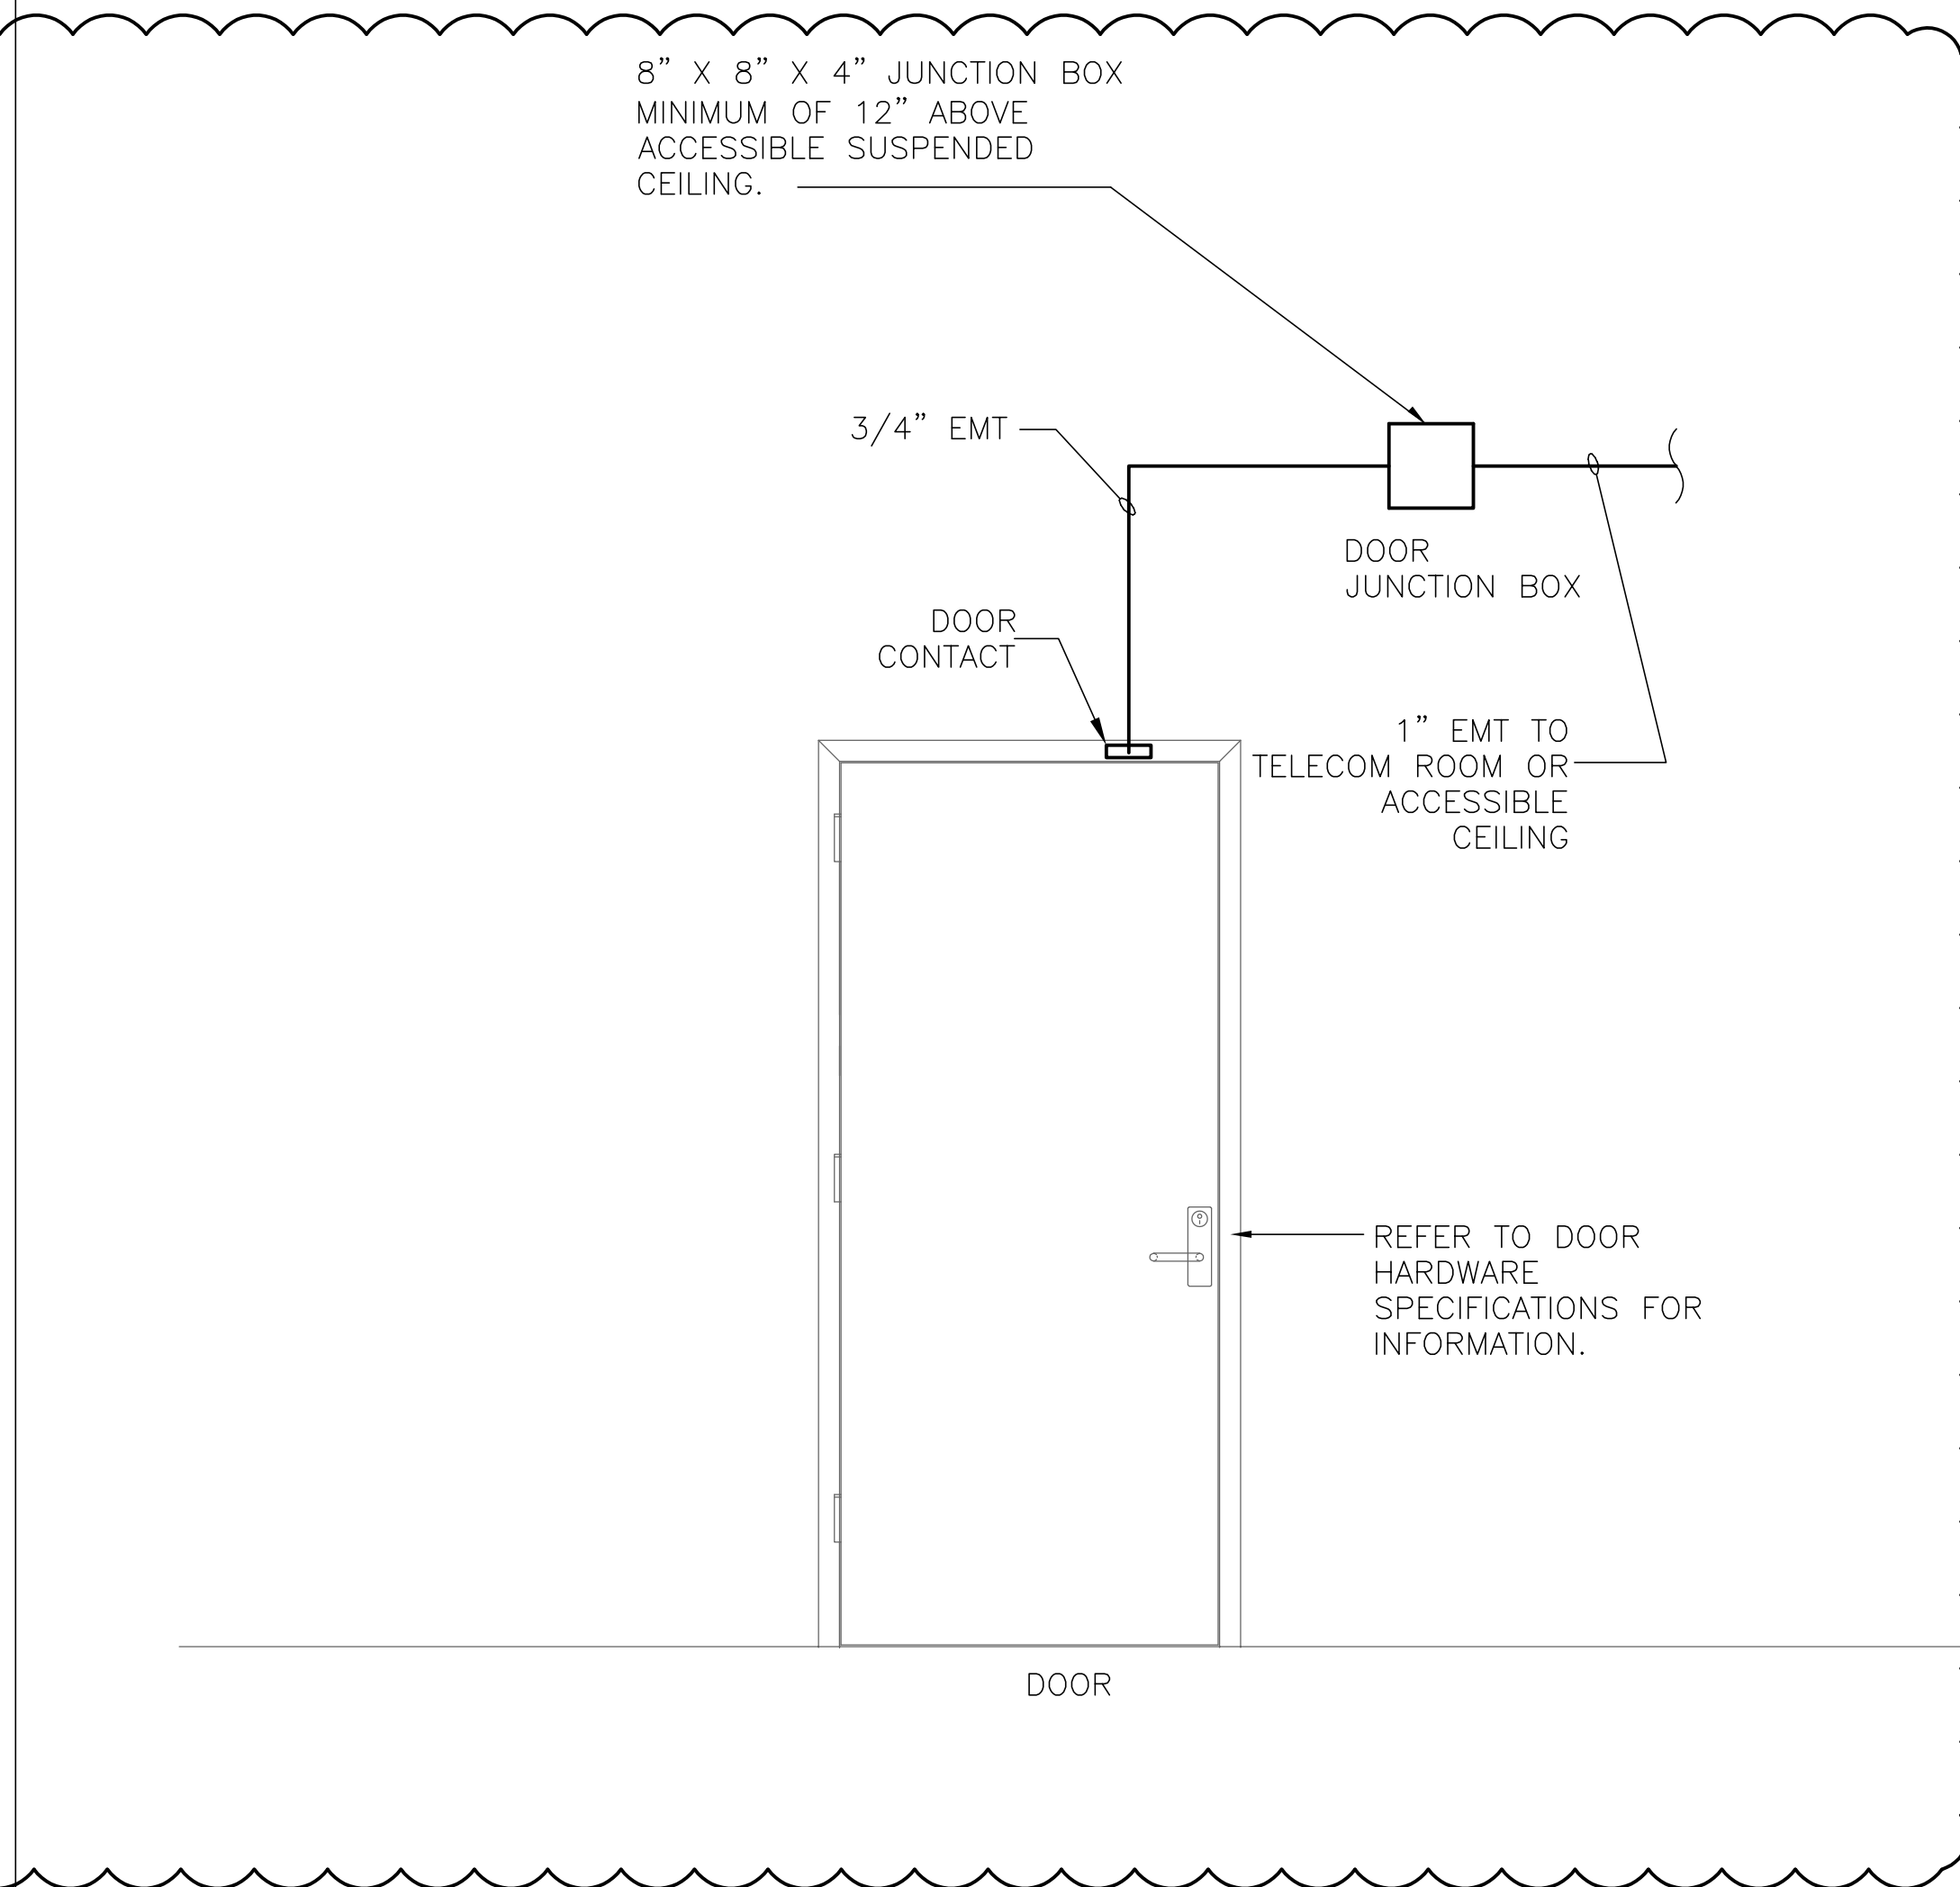

ACCESS CONTROL – SINGLE DOOR, NO READER DETAIL


SCALE: NONE 4

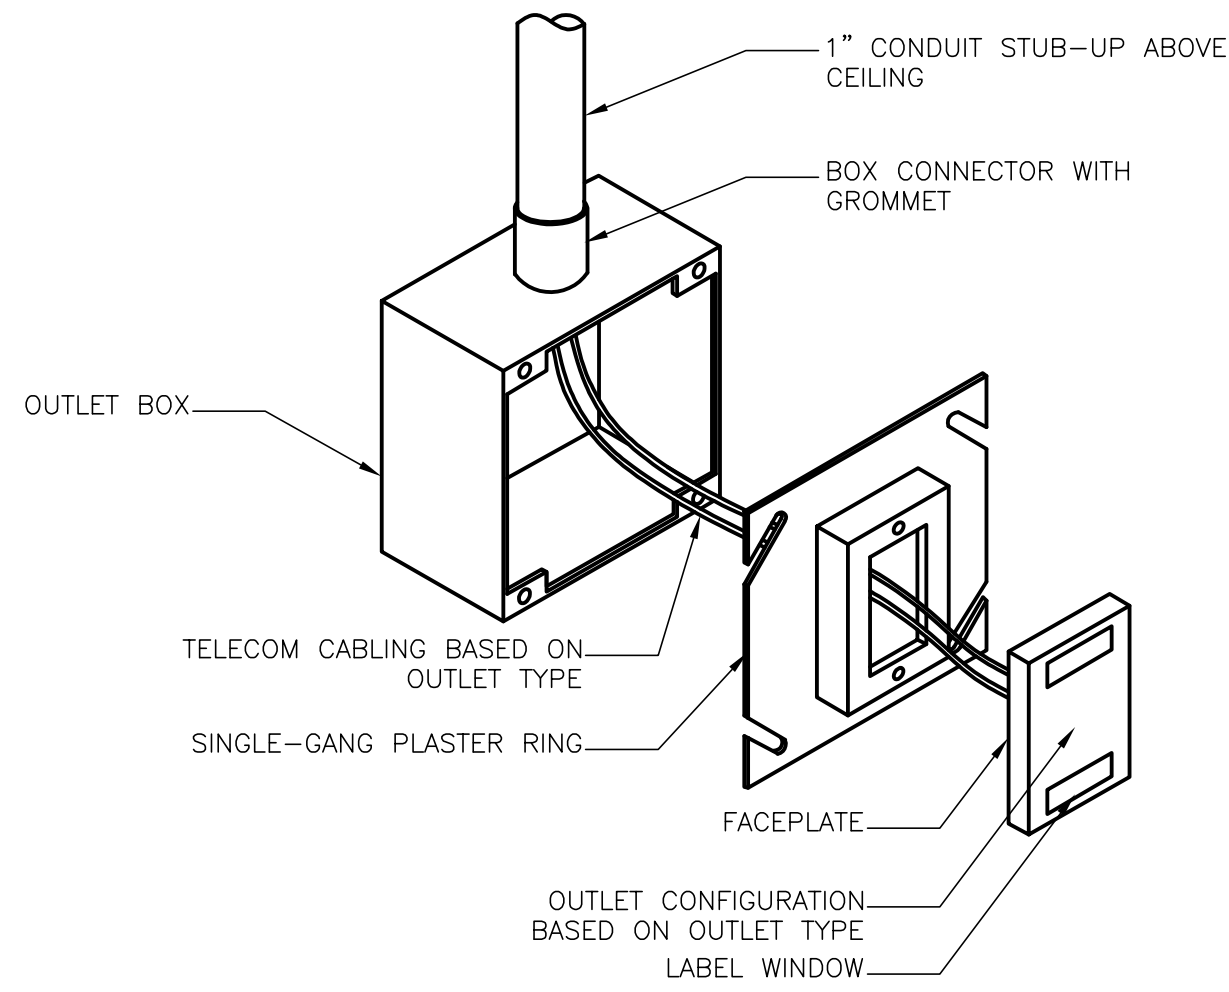

DATA OUTLET DETAIL

SCALE:
NONE


1

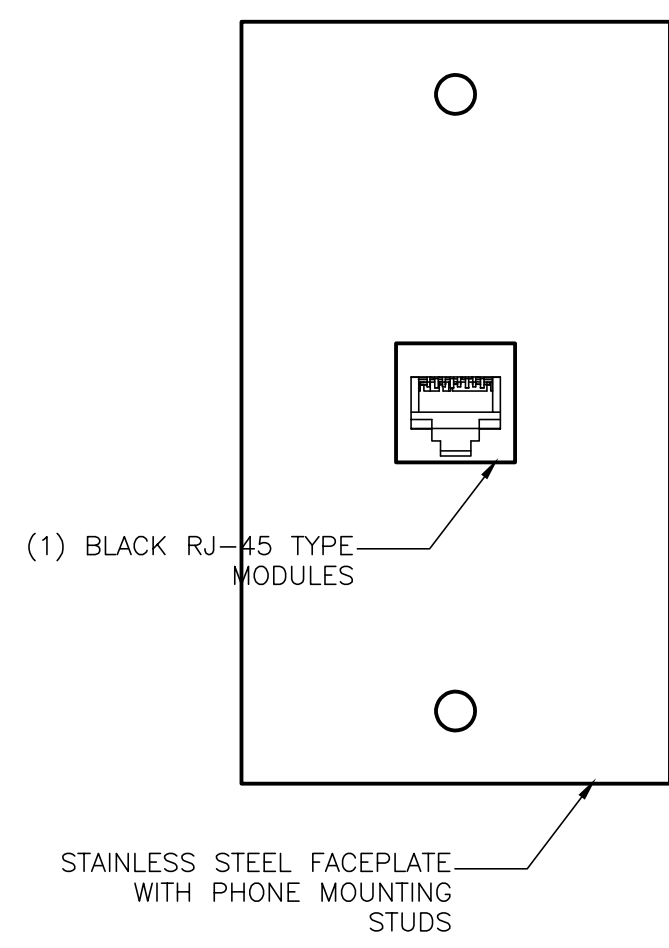

WALL PHONE FACEPLATE

SCALE:
NONE


2

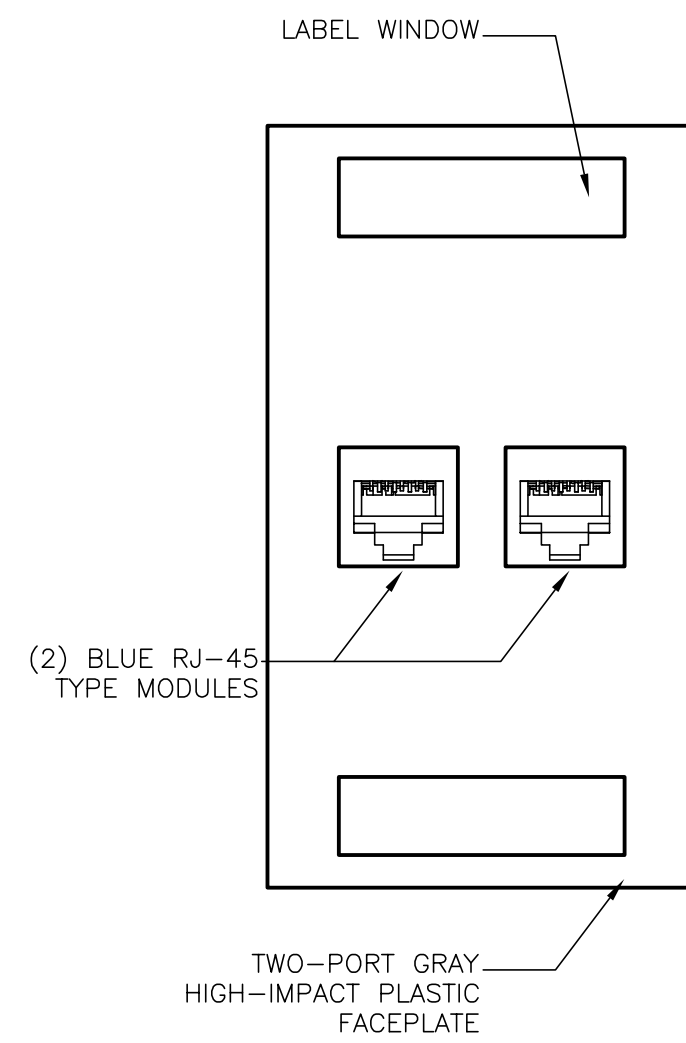

TYPICAL 2-PORT DATA FACEPLATE

SCALE:
NONE


3

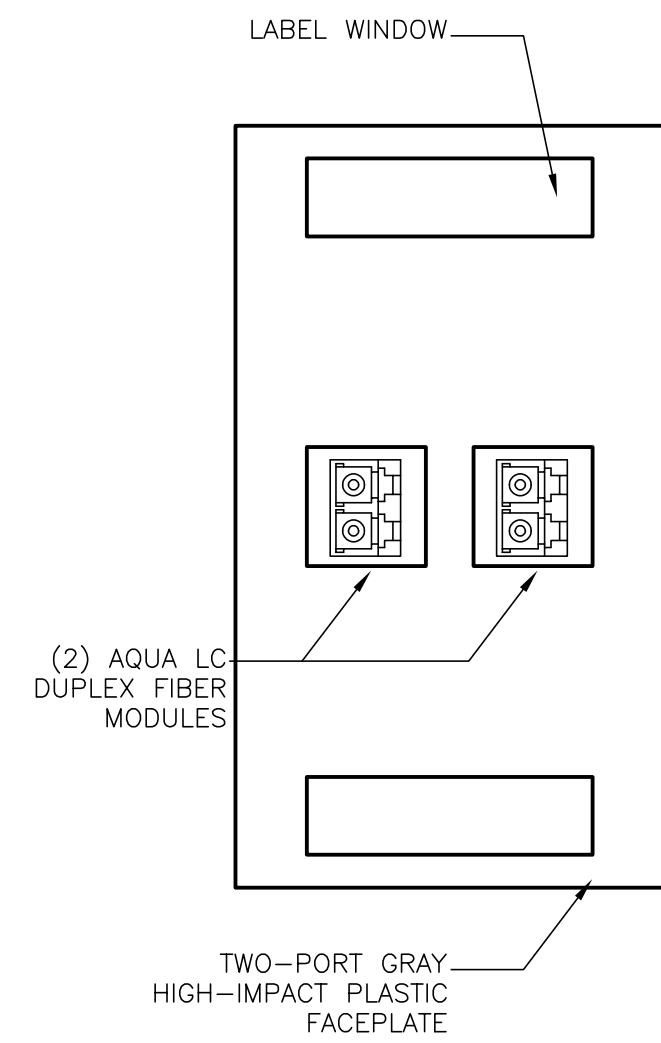

TYPICAL 2-PORT FIBER FACEPLATE

SCALE:
NONE


4

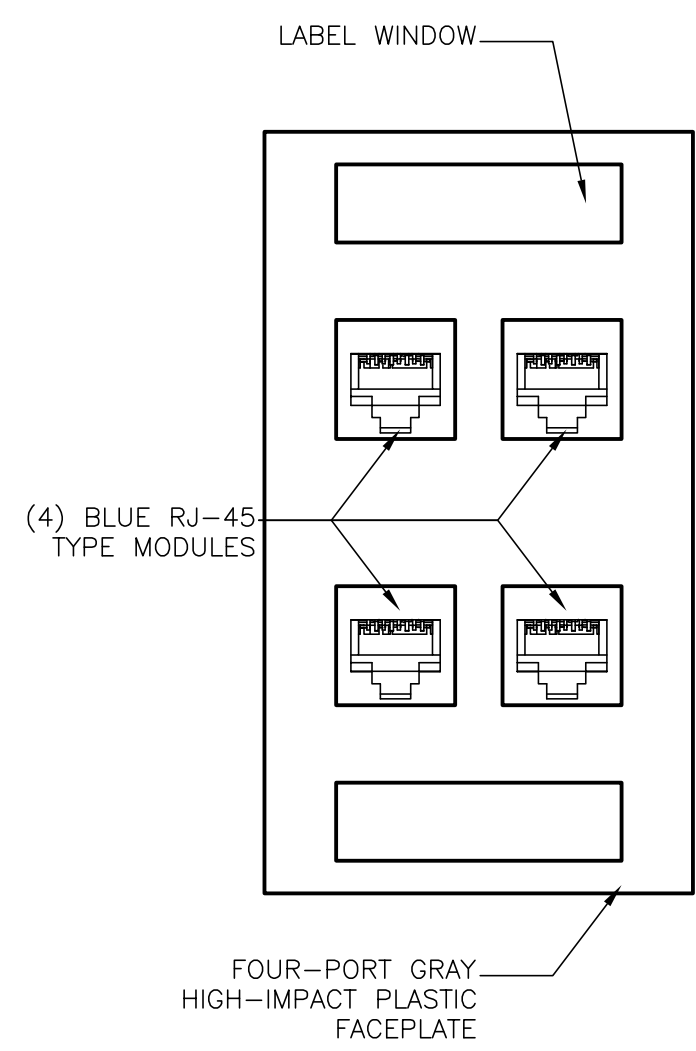

TYPICAL 4-PORT DATA FACEPLATE

SCALE:
NONE


5

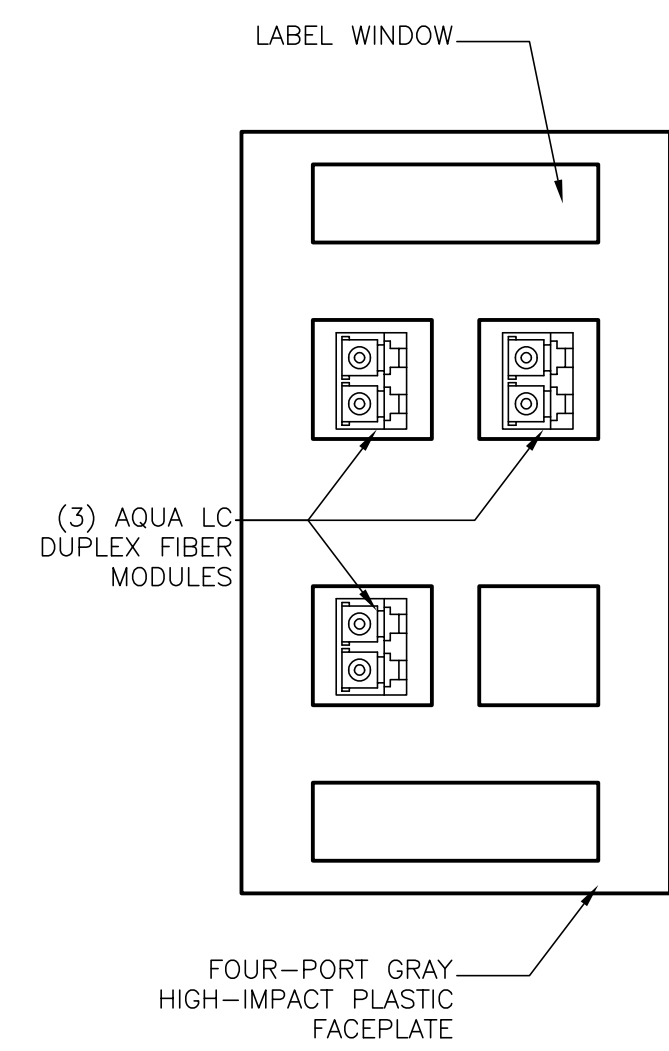

TYPICAL 3-PORT FIBER FACEPLATE

SCALE:
NONE


6

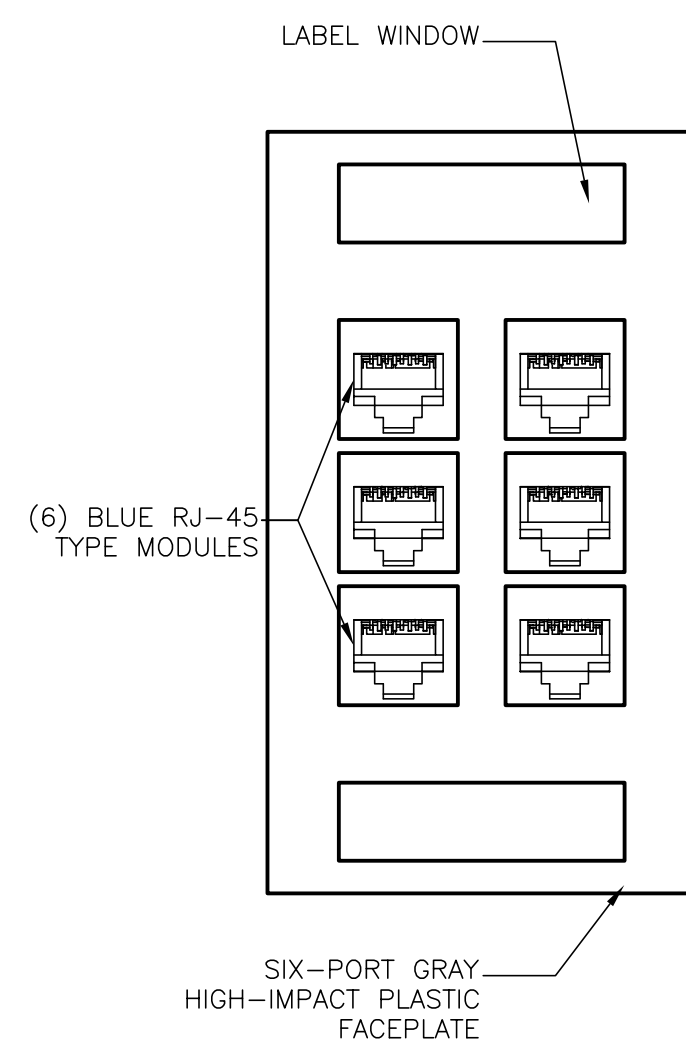

TYPICAL 6-PORT DATA FACEPLATE

SCALE:
NONE


7

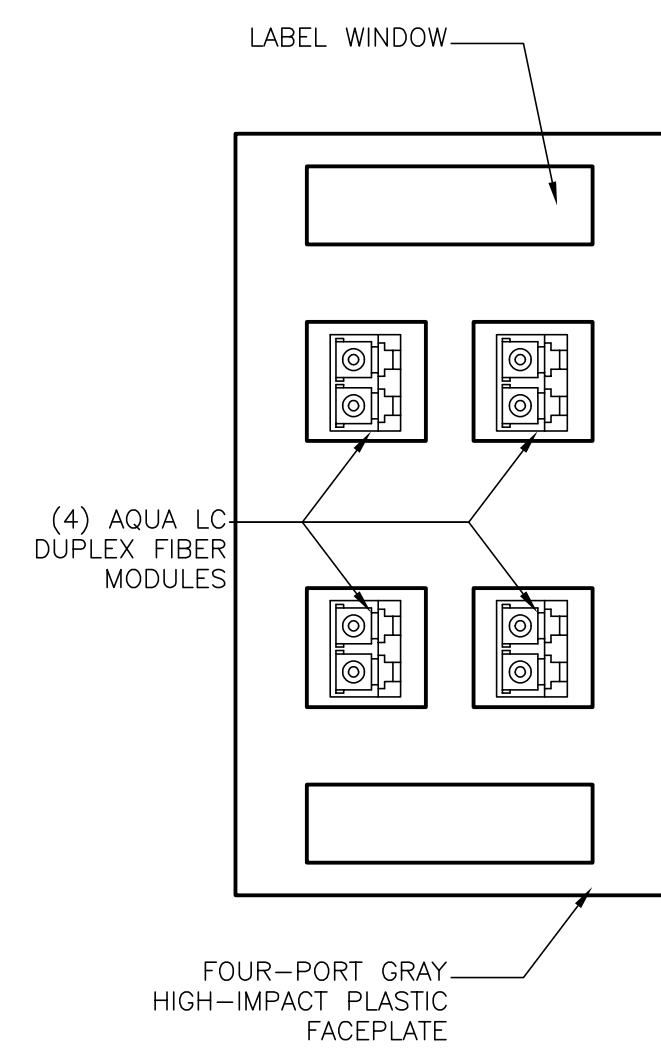

TYPICAL 4-PORT FIBER FACEPLATE

SCALE:
NONE



8

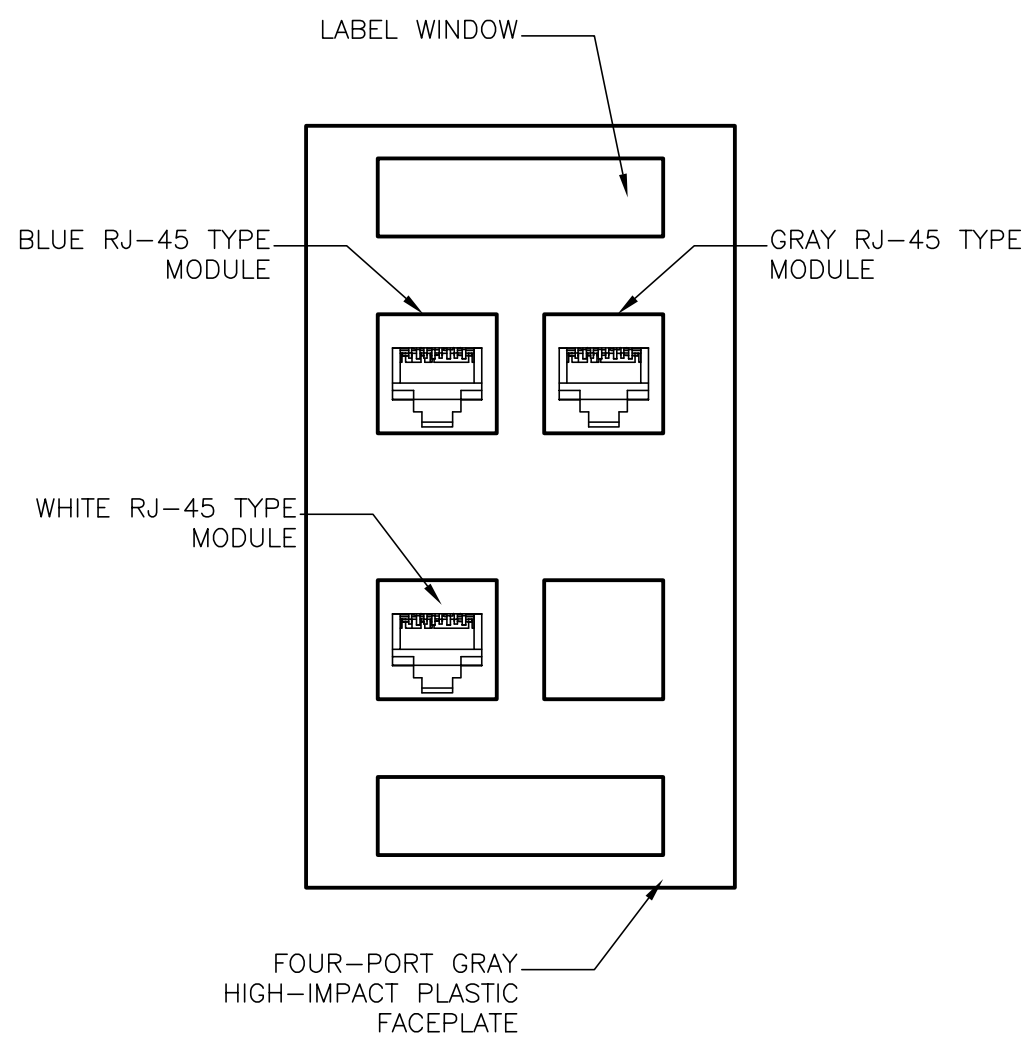

TYPICAL AIRLINE OFFICE DATA FACEPLATE

SCALE:
NONE


9

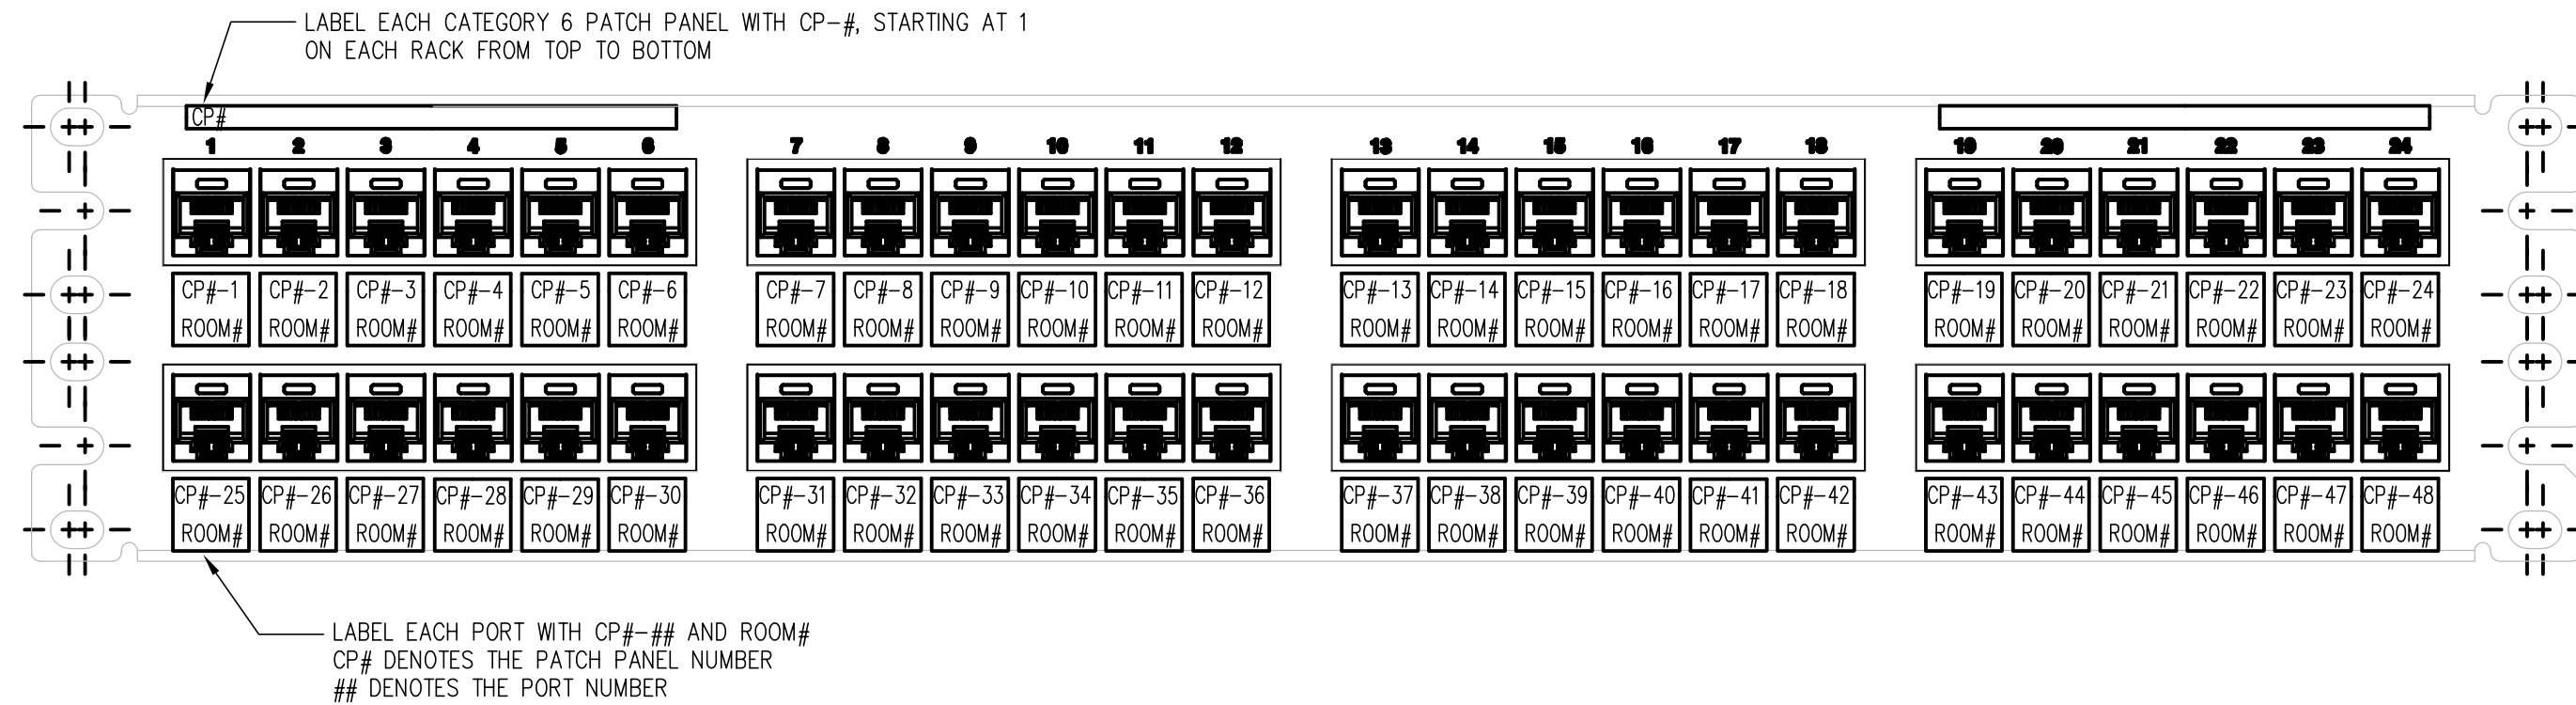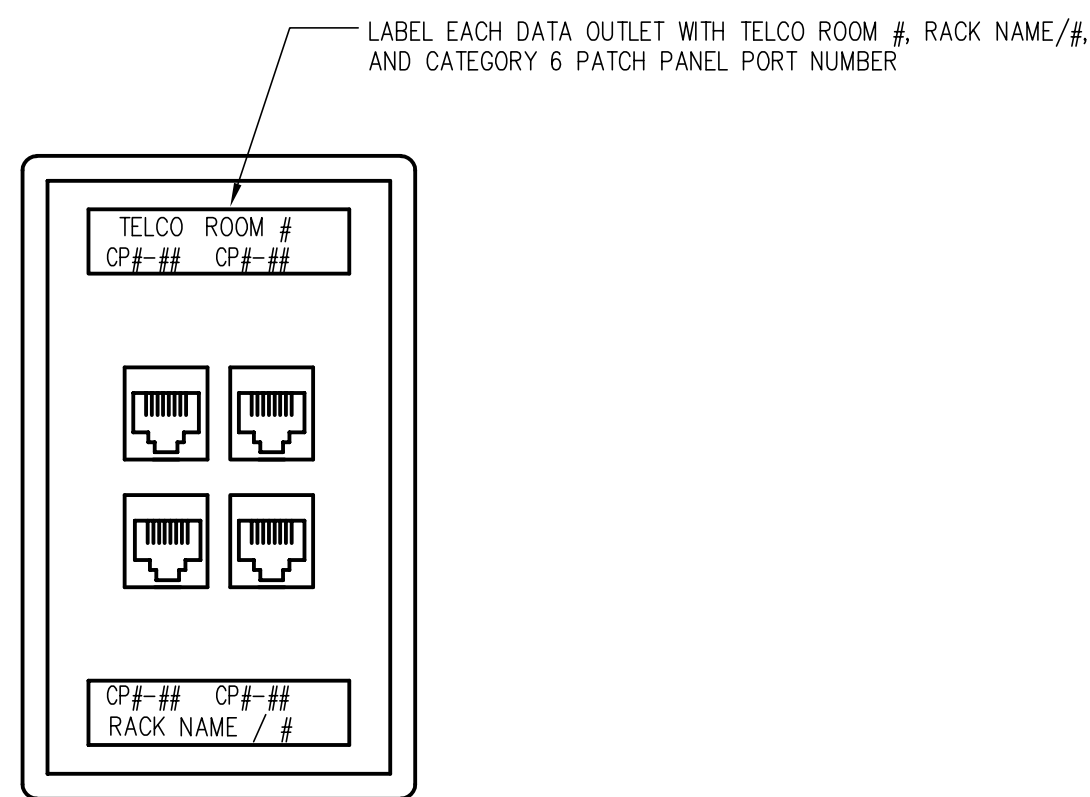

TYPICAL OUTLET LABEL DETAIL


SCALE:
NONE

10

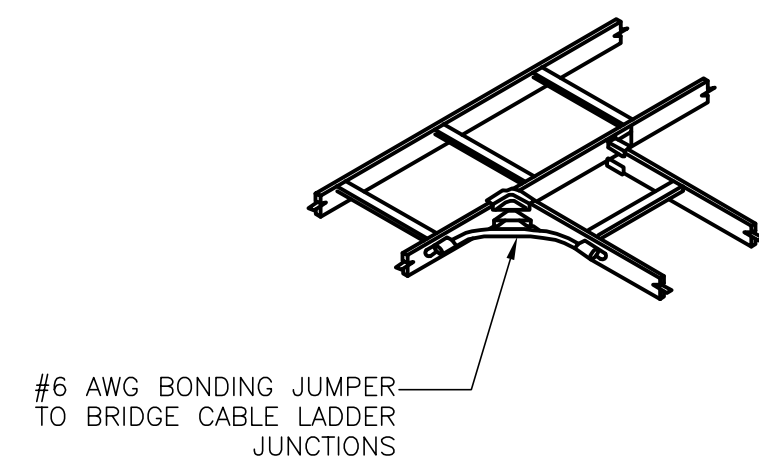


LADDER RACK BUTT SPLICE

SCALE: NONE 1

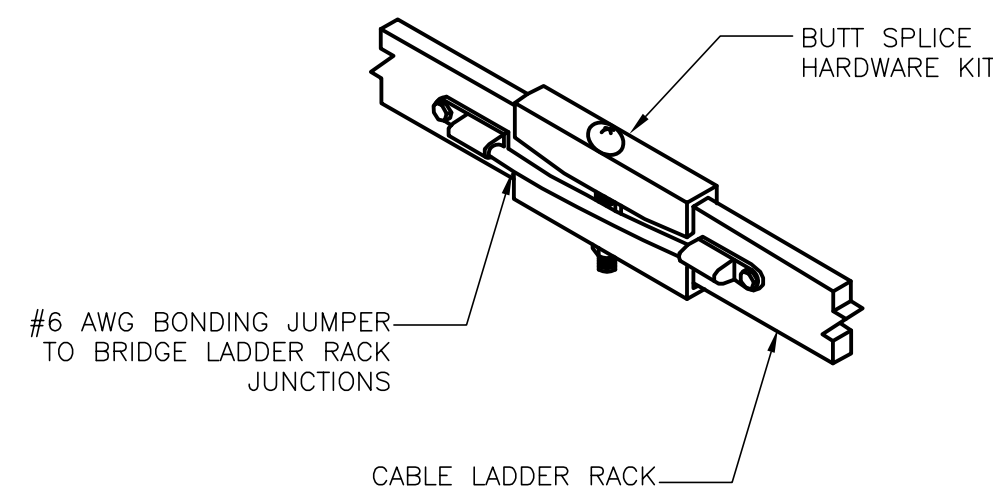


LADDER RACK JUNCTION SPLICE

SCALE: NONE 2

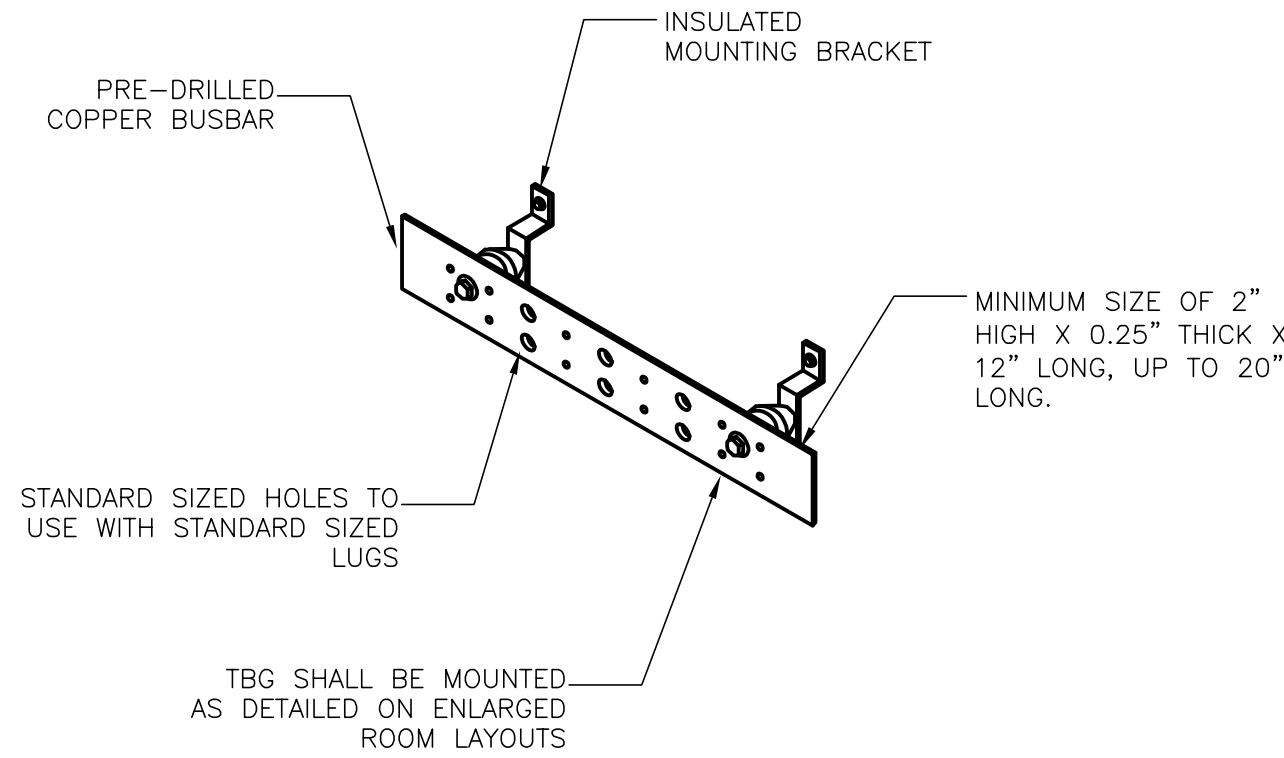


GROUND BUSBAR DETAIL

SCALE: NONE 3

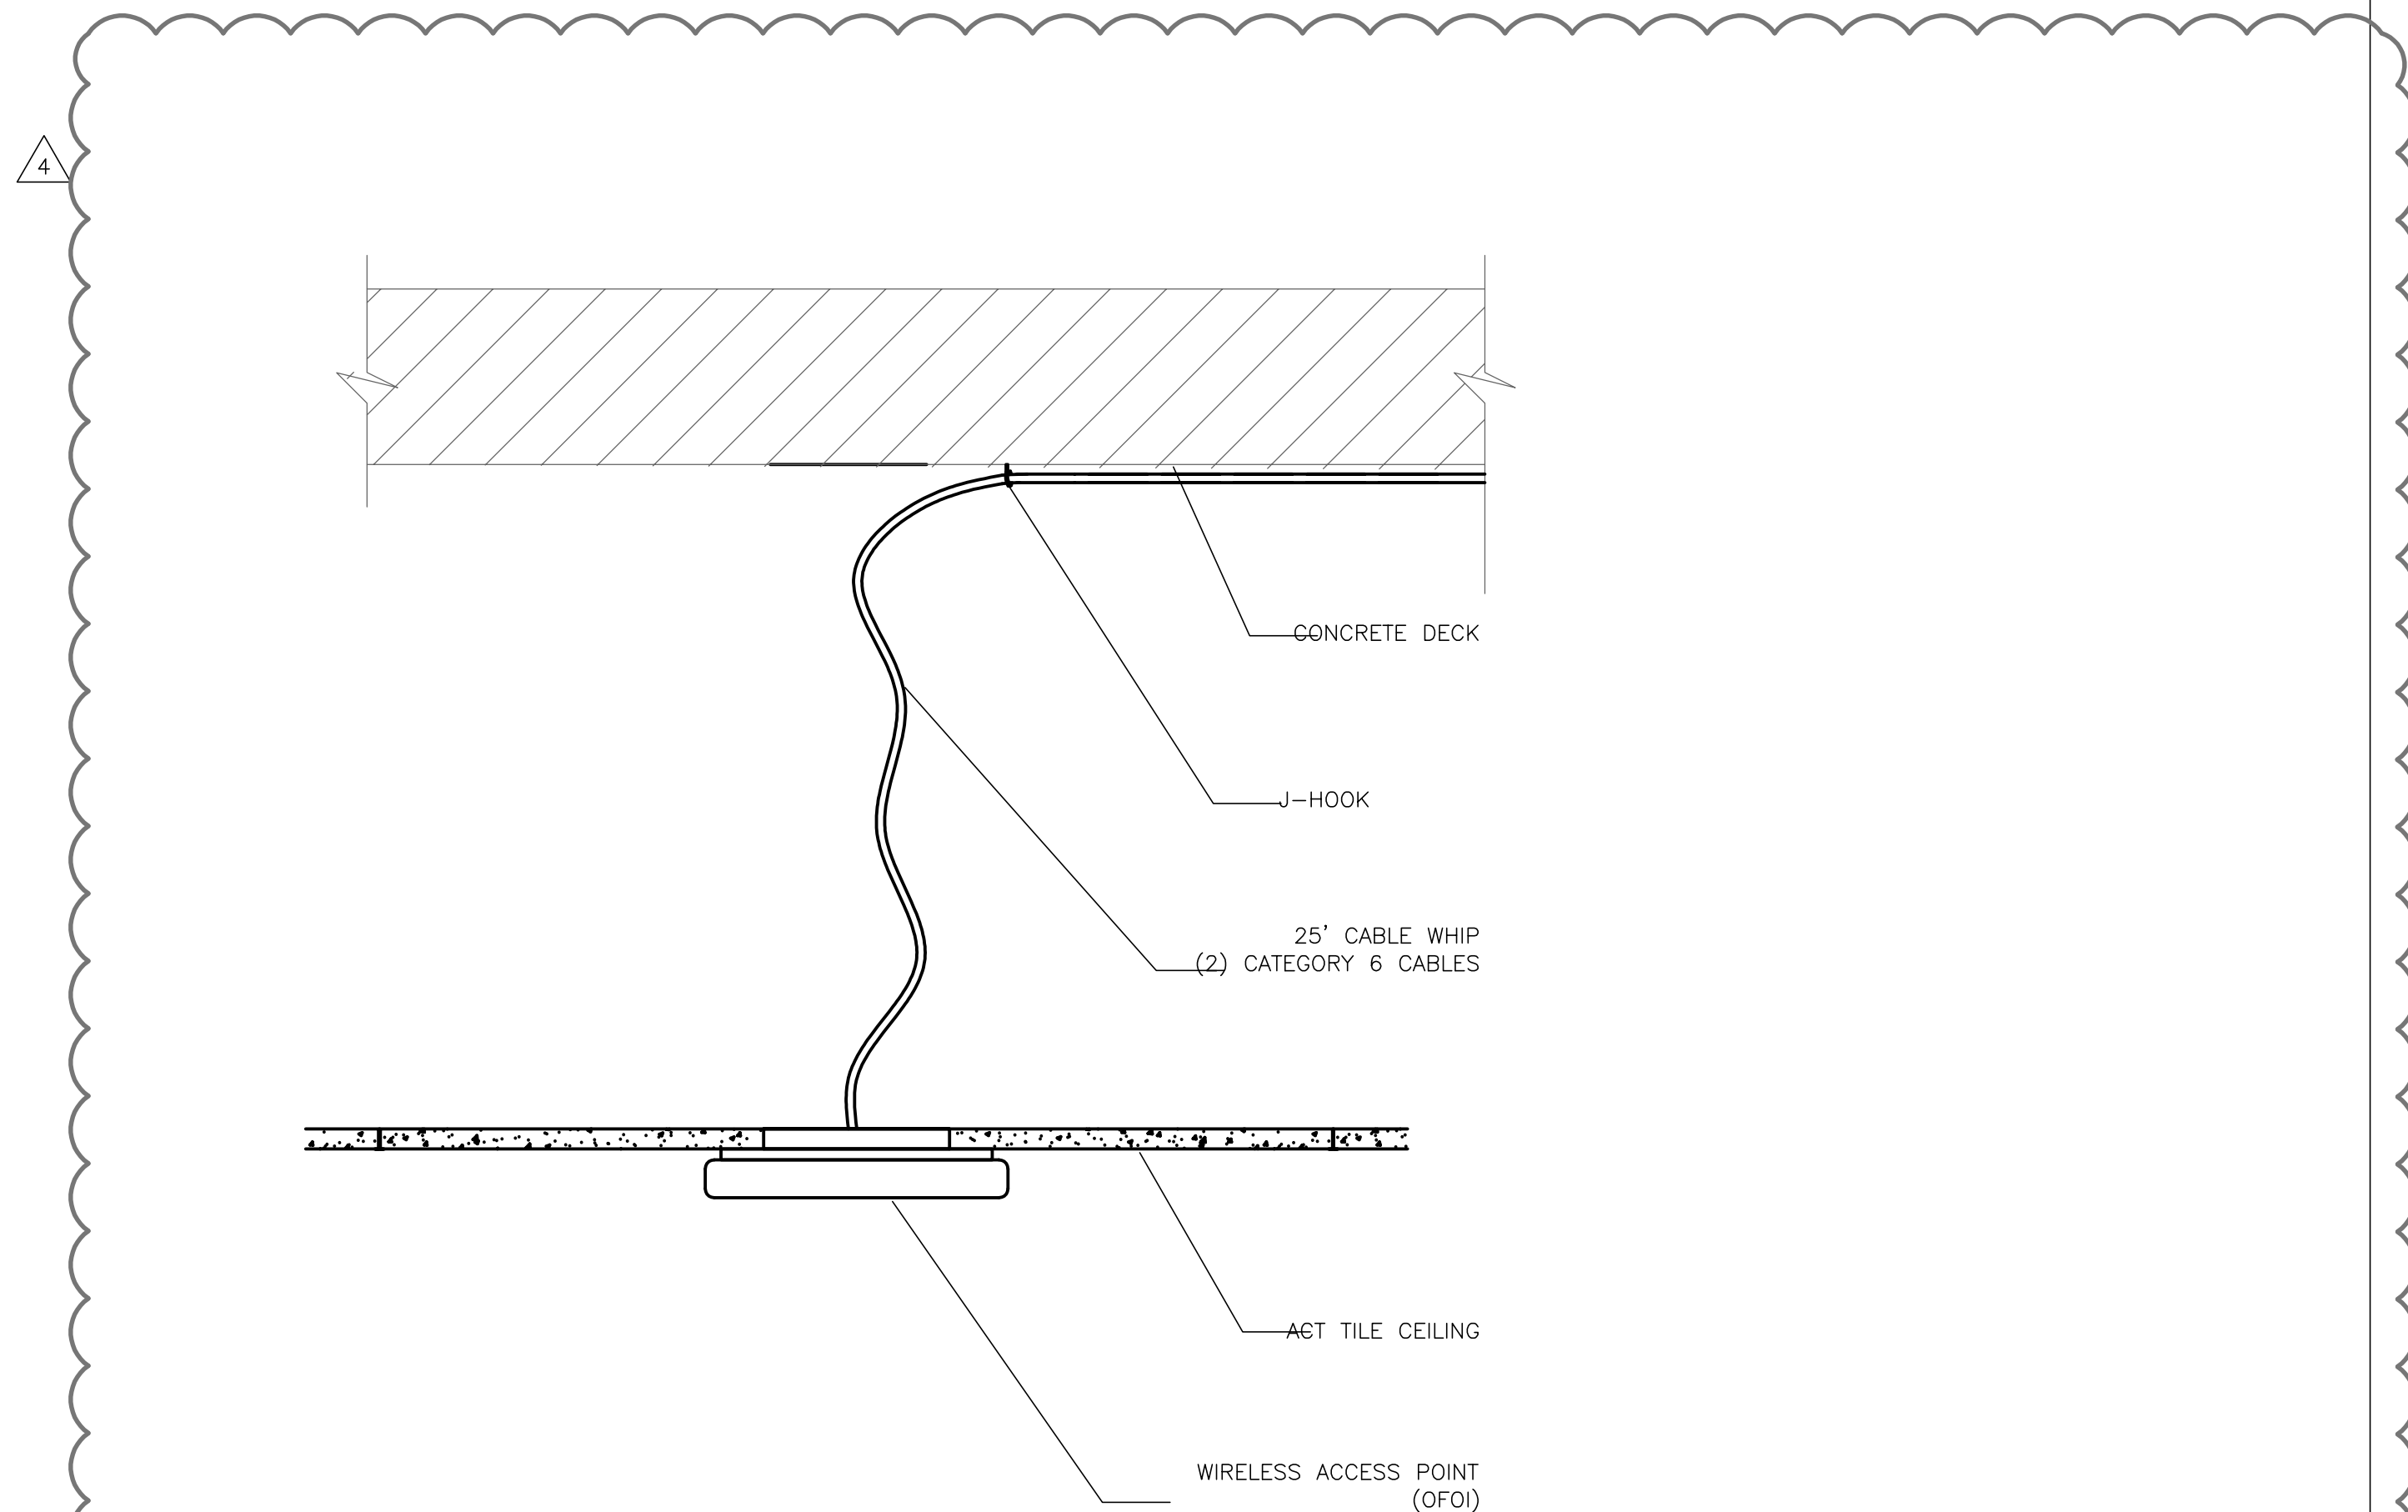


WIRELESS ACCESS POINT MOUNTING DETAIL

SCALE: NONE 5

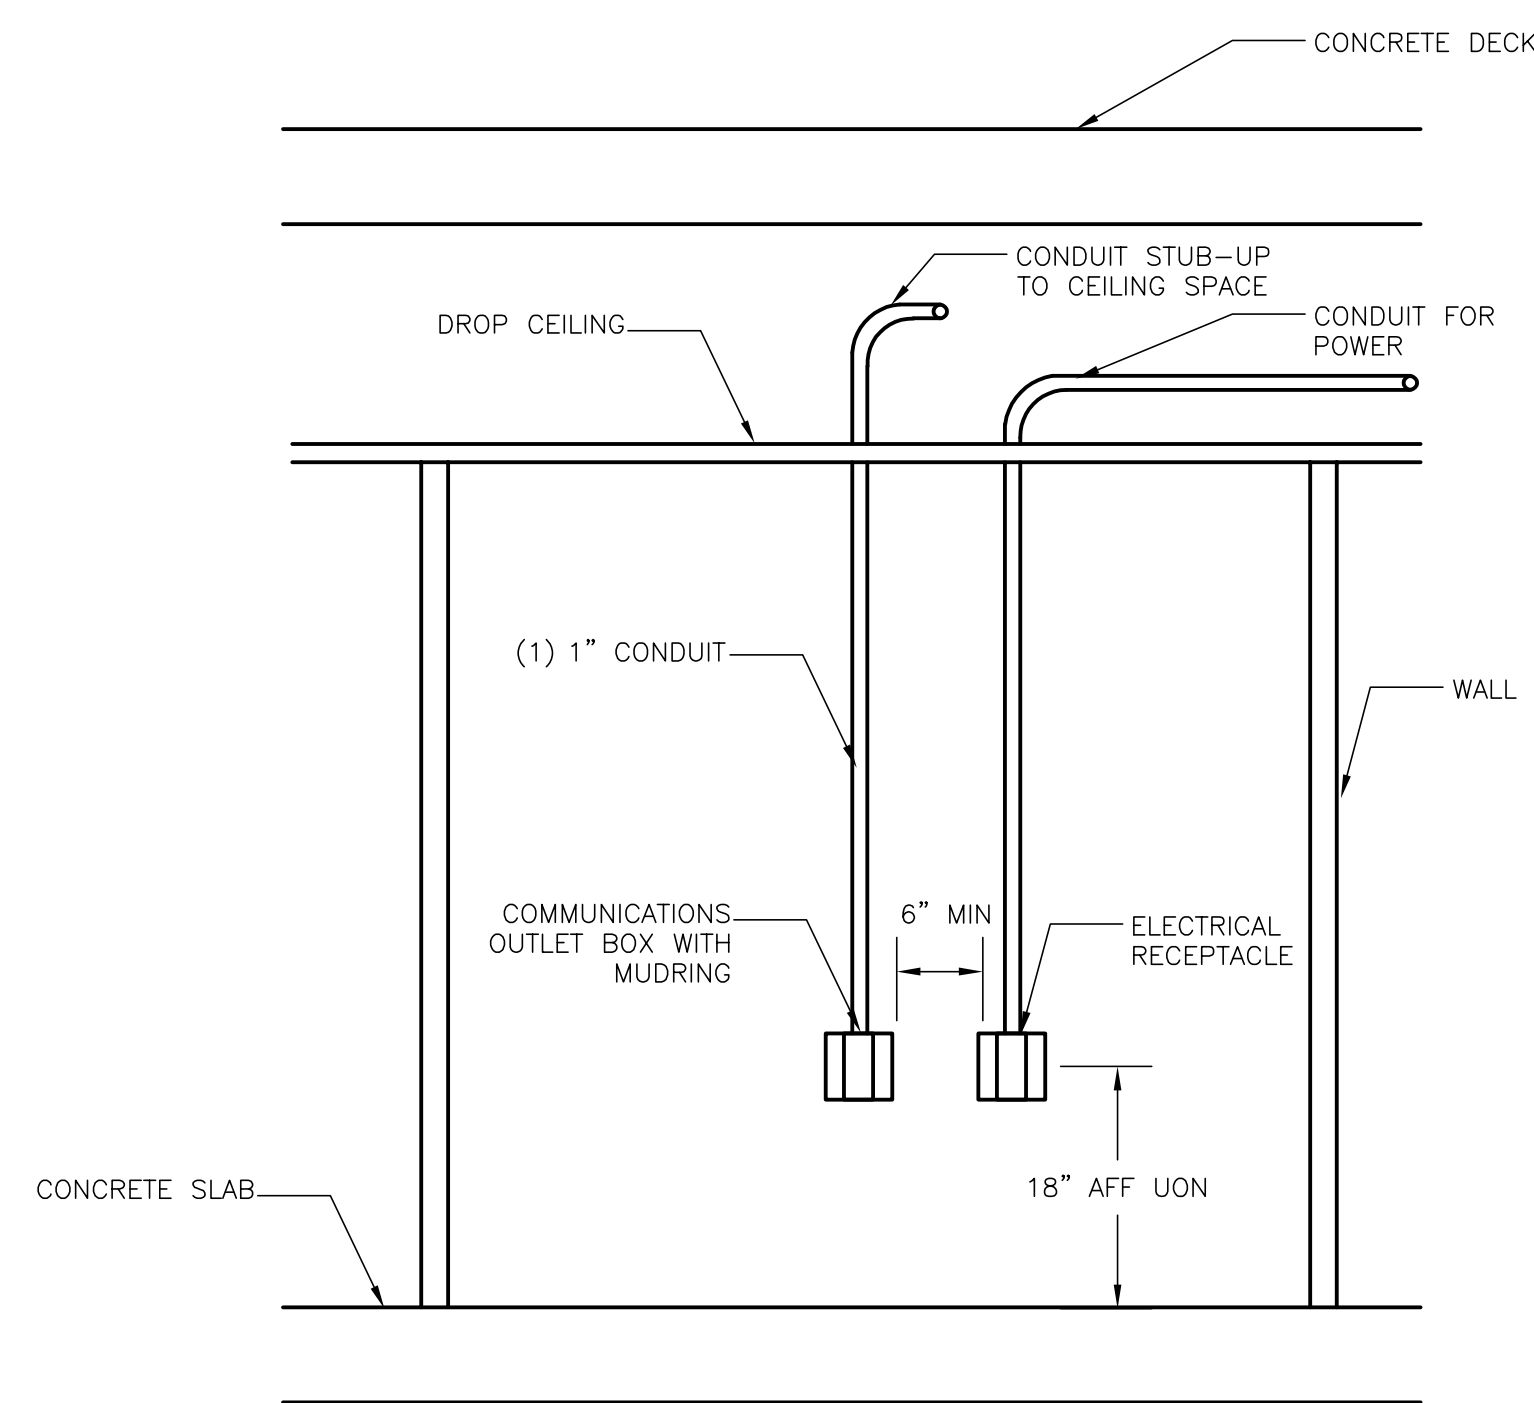


TYPICAL OUTLET BOX DETAIL


SCALE: NONE 4

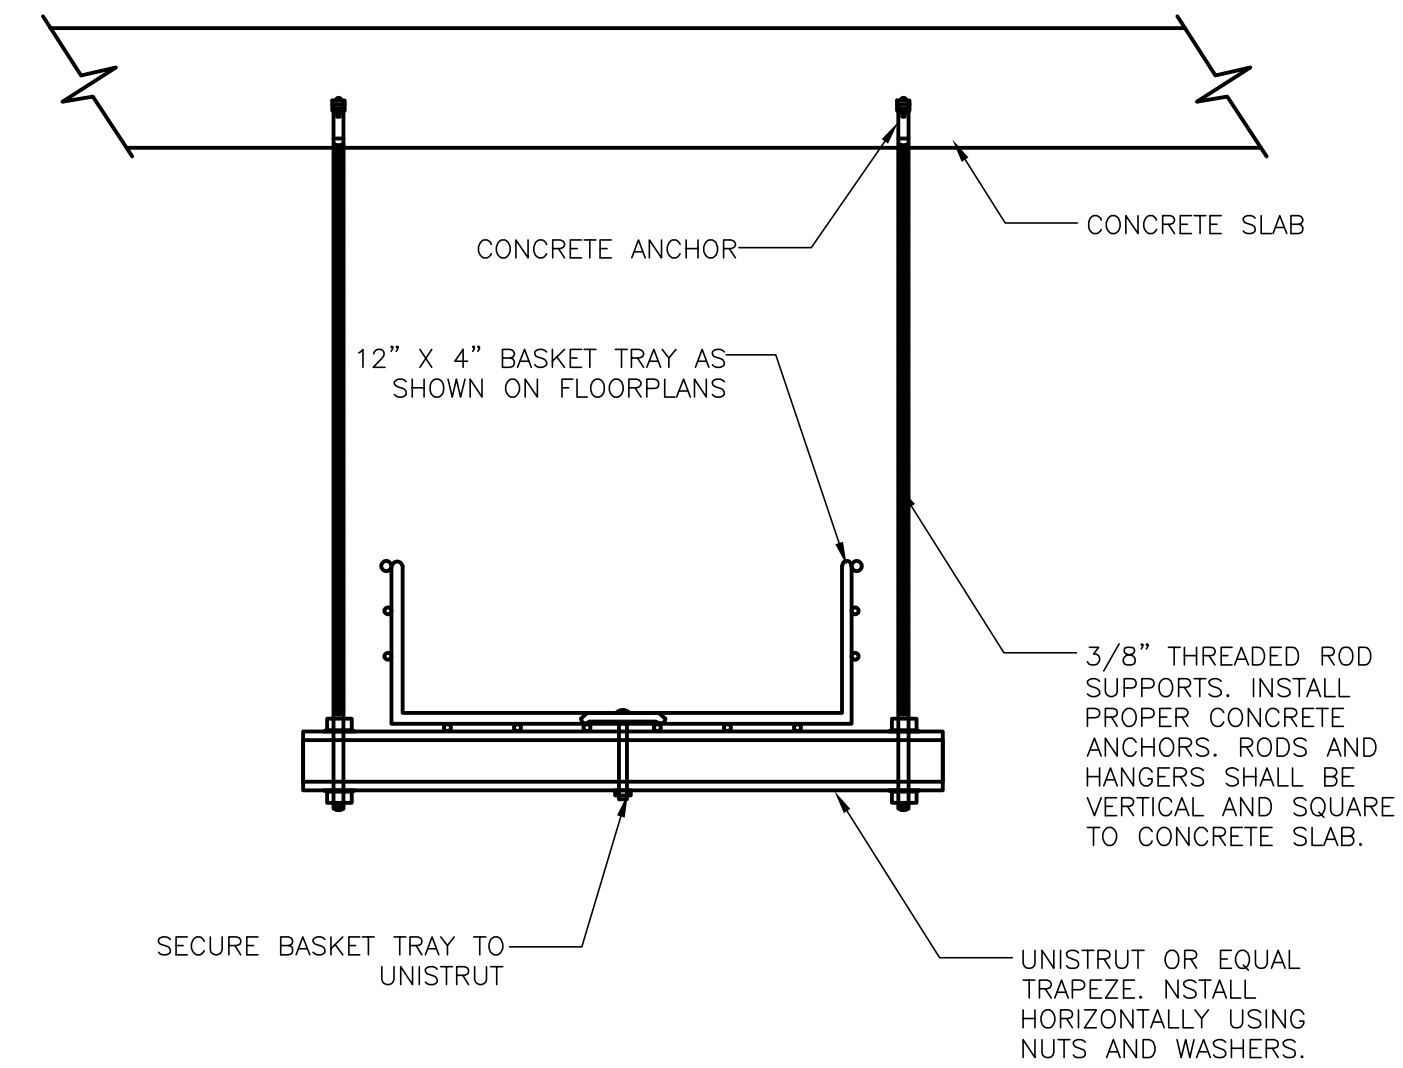


TYPICAL CABLE TRAY MOUNTING DETAIL

SCALE: NONE 5

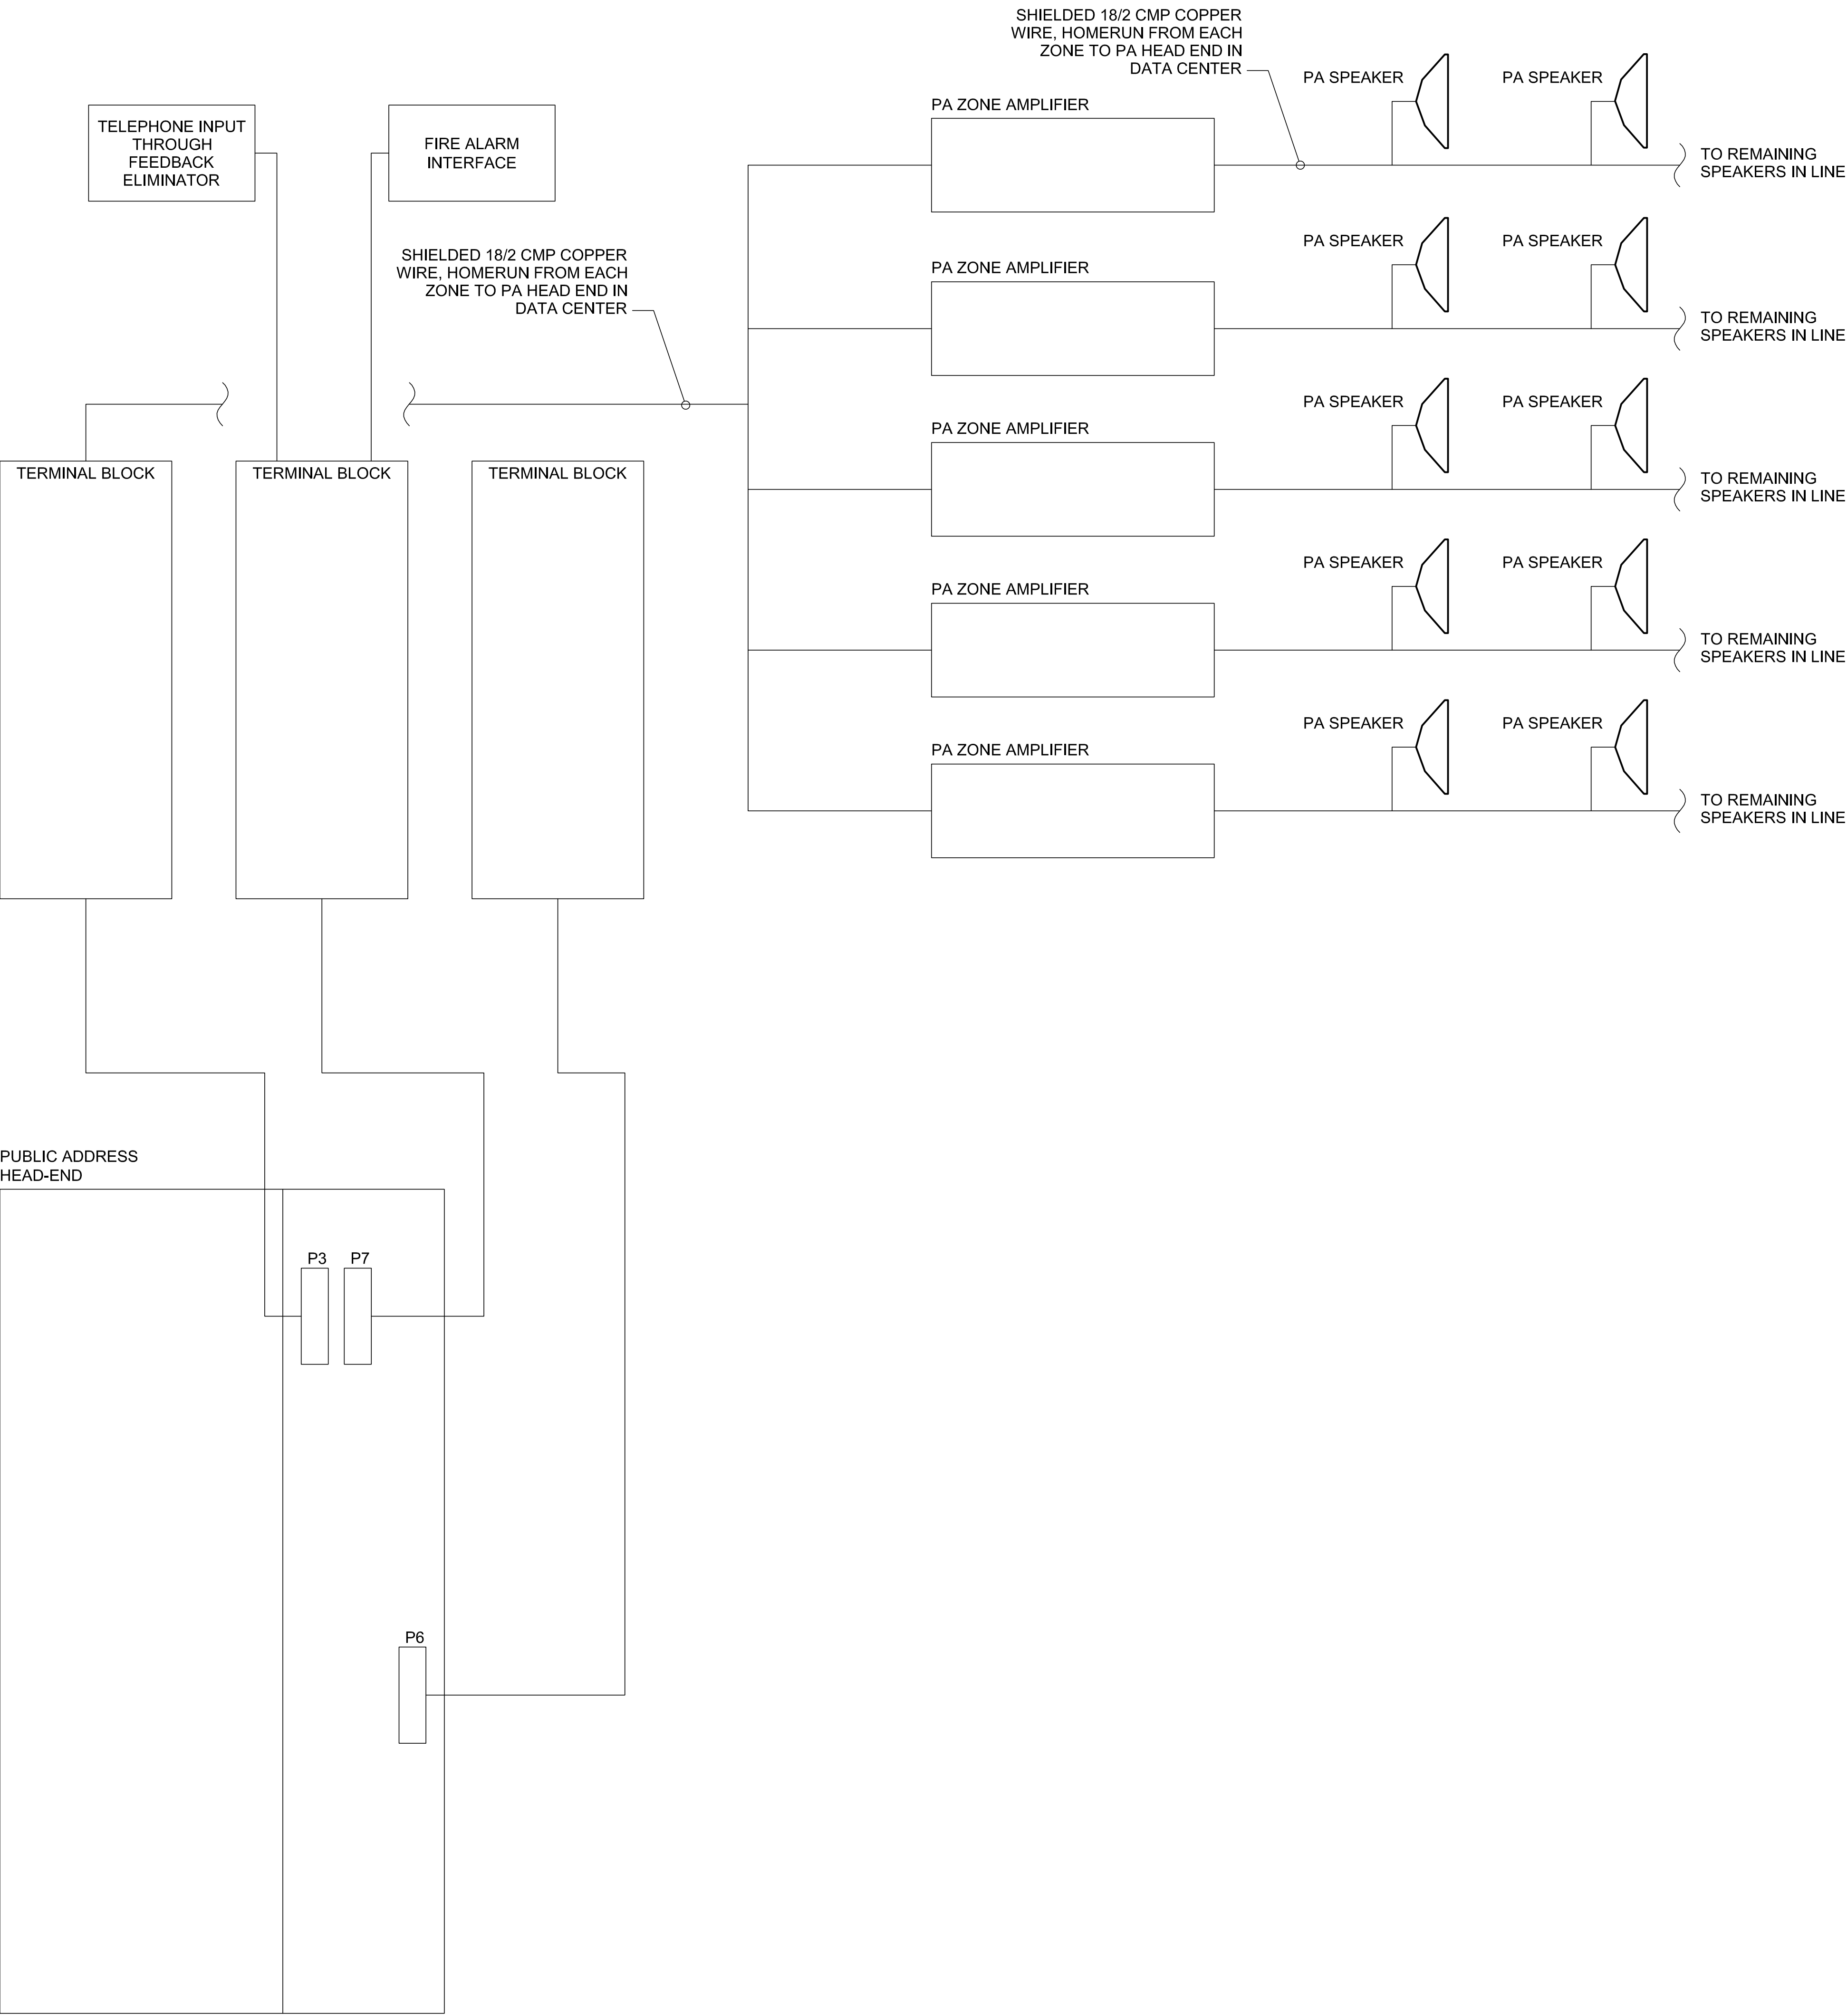

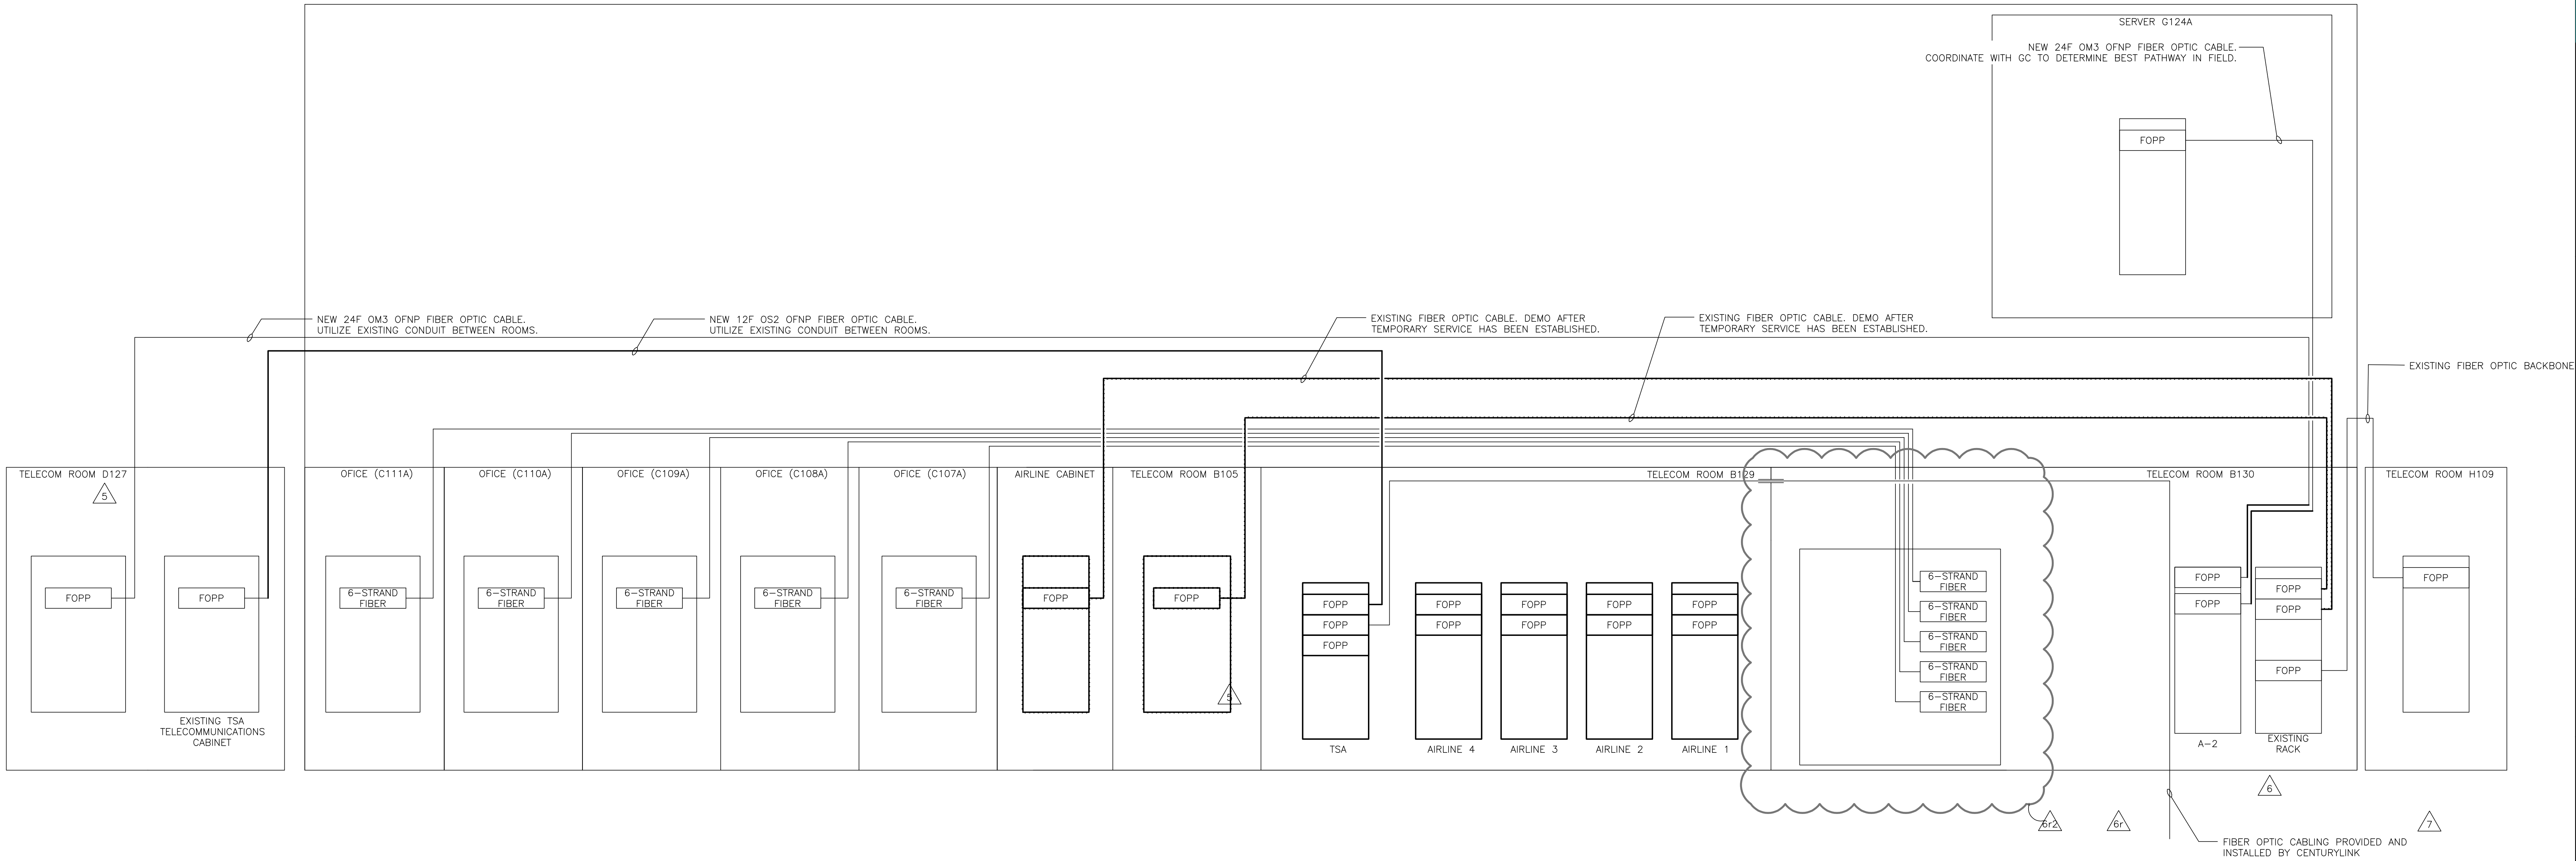

FIBER OPTIC RISER DIAGRAM
SCALE: NONE

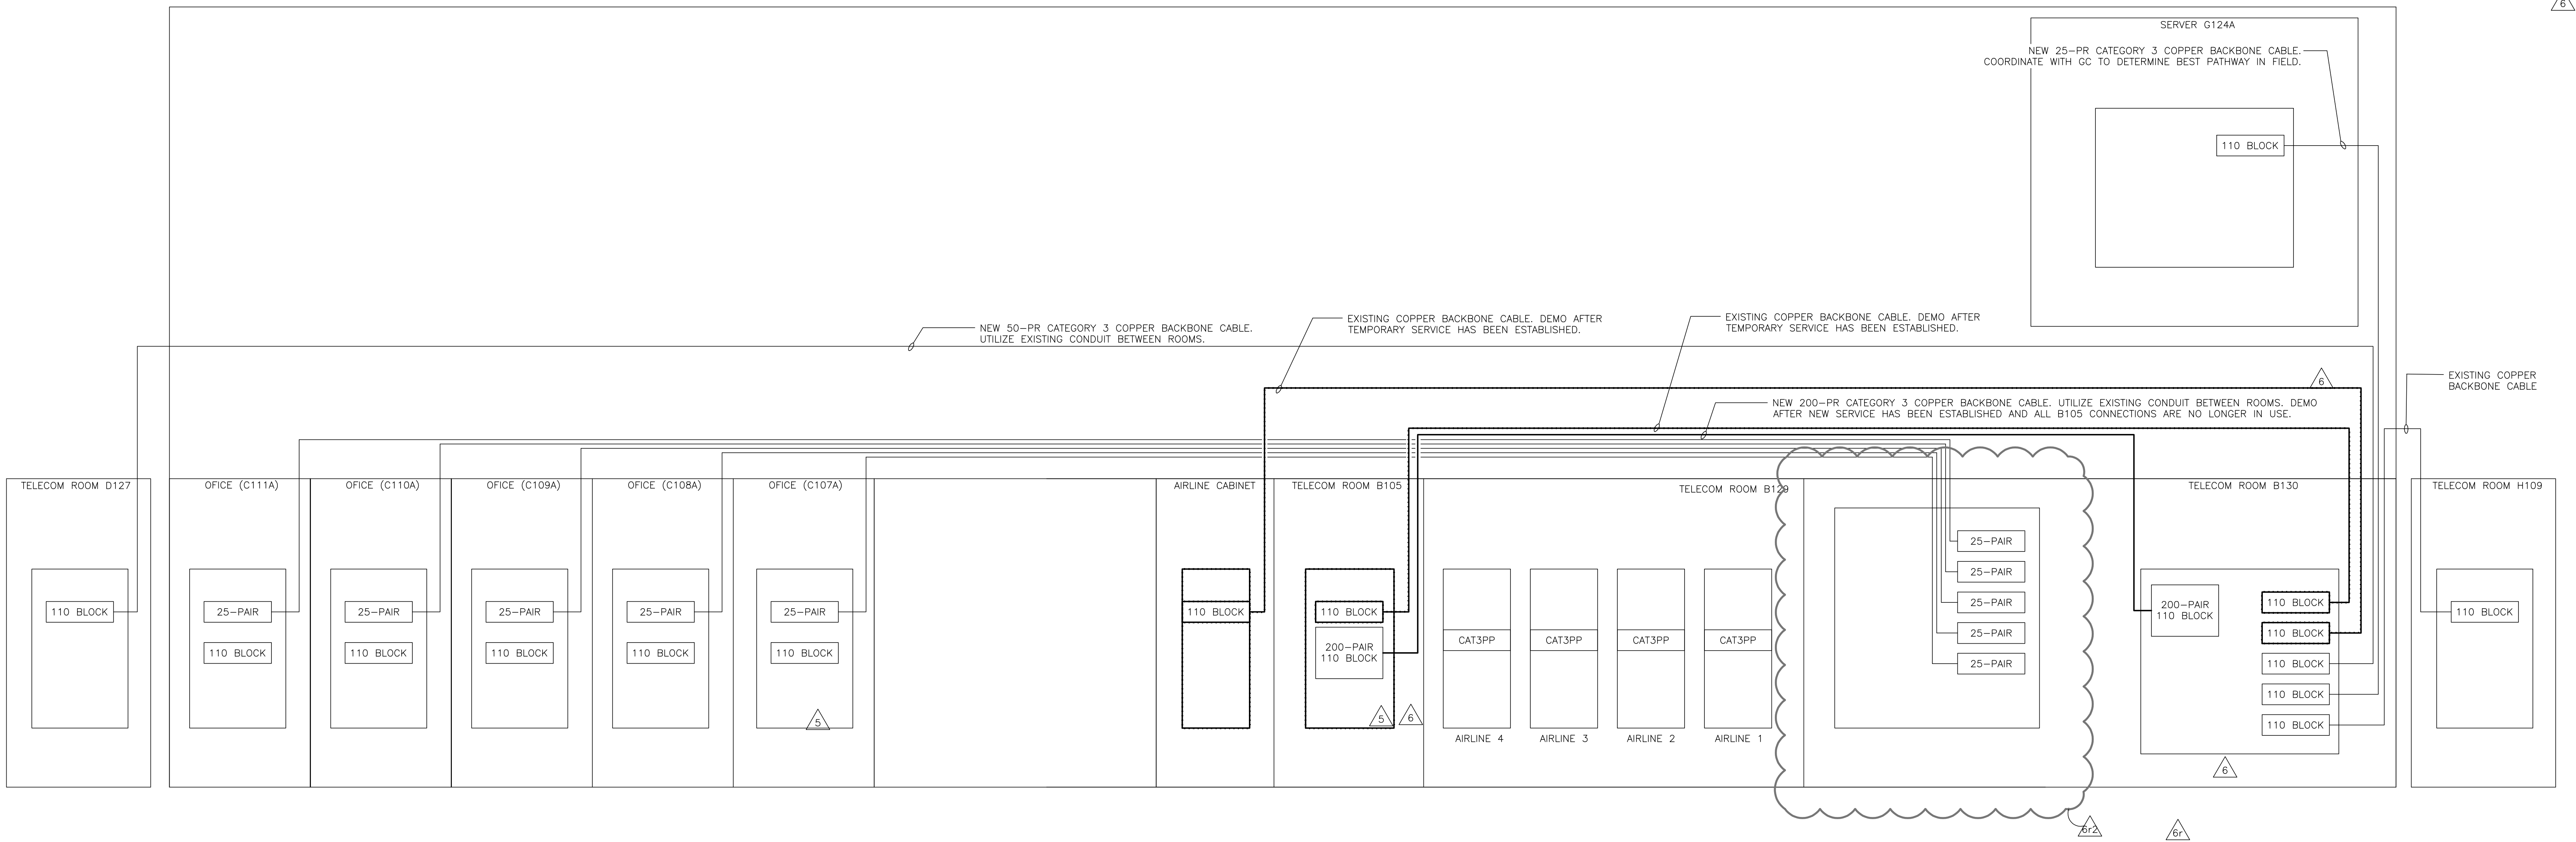

COPPER RISER DIAGRAM
SCALE: NONE

NOTE:
1. PROVIDE 6F OS2 OFNP CABLING FOR ALL 6-STRAND FIBER CONNECTIONS.
2. ALL FIBER CABLING FROM UTILITY, ACTIVE EQUIPMENT AND PATCH CORDS REQUIRED TO ESTABLISH TELECOM SERVICE SHALL BE PROVIDED BY THE TELECOM SERVICE PROVIDER AT TIME OF SERVICE ACTIVATION.

NOTE:
1. PROVIDE CATEGORY 3 COPPER CABLING FOR ALL 25-PAIR CONNECTIONS.
2. ALL COPPER CABLING FROM UTILITY, ACTIVE EQUIPMENT AND PATCH CORDS REQUIRED TO ESTABLISH TELECOM SERVICE SHALL BE PROVIDED BY THE TELECOM SERVICE PROVIDER AT TIME OF SERVICE ACTIVATION.

3

SECURITY CAMERA SCHEDULE					
ID	LOCATION	AREA	CAMERA TYPE	MOUNTING TYPE	TELCO ROOM
C1	EXTERIOR	LEVEL 1 AREA A	180-DEG	WALL-MOUNTED	TELCO B130
C2	EXTERIOR	LEVEL 1 AREA A	180-DEG	WALL-MOUNTED	TELCO B130
C3	INTERIOR	LEVEL 1 AREA A	180-DEG	WALL-MOUNTED	TELCO B130
C4	INTERIOR	LEVEL 1 AREA A	180-DEG	WALL-MOUNTED	TELCO B130
C5	INTERIOR	LEVEL 1 AREA A	180-DEG	RECESSED CEILING MOUNTED	TELCO B130
C6	INTERIOR	LEVEL 1 AREA A	180-DEG	RECESSED CEILING MOUNTED	TELCO B130
C7	INTERIOR	LEVEL 1 AREA A	180-DEG	RECESSED CEILING MOUNTED	TELCO B130
C8	INTERIOR	LEVEL 1 AREA A	180-DEG	RECESSED CEILING MOUNTED	TELCO B130
C9	INTERIOR	LEVEL 1 AREA A	180-DEG	RECESSED CEILING MOUNTED	TELCO B130
C10	INTERIOR	LEVEL 1 AREA A	180-DEG	RECESSED CEILING MOUNTED	TELCO B130
C11	INTERIOR	LEVEL 1 AREA A	180-DEG	RECESSED CEILING MOUNTED	TELCO B130
C12	INTERIOR	LEVEL 1 AREA A	180-DEG	RECESSED CEILING MOUNTED	TELCO B130
C13	INTERIOR	LEVEL 1 AREA A	180-DEG	RECESSED CEILING MOUNTED	TELCO B130
C14	INTERIOR	LEVEL 1 AREA A	180-DEG	RECESSED CEILING MOUNTED	TELCO B130
C15	INTERIOR	LEVEL 1 AREA B	180-DEG	RECESSED CEILING MOUNTED	TELCO B130
C16	INTERIOR	LEVEL 1 AREA B	180-DEG	RECESSED CEILING MOUNTED	TELCO B130
C17	INTERIOR	LEVEL 1 AREA B	180-DEG	RECESSED CEILING MOUNTED	TELCO B130
C18	INTERIOR	LEVEL 1 AREA B	180-DEG	RECESSED CEILING MOUNTED	TELCO B130
C19	INTERIOR	LEVEL 1 AREA B	180-DEG	RECESSED CEILING MOUNTED	TELCO B130
C20	INTERIOR	LEVEL 1 AREA B	180-DEG	RECESSED CEILING MOUNTED	TELCO B130
C21	INTERIOR	LEVEL 1 AREA B	180-DEG	RECESSED CEILING MOUNTED	TELCO B130
C22	INTERIOR	LEVEL 1 AREA B	180-DEG	RECESSED CEILING MOUNTED	TELCO B130
C23	INTERIOR	LEVEL 1 AREA B	180-DEG	RECESSED CEILING MOUNTED	TELCO B130
C24	INTERIOR	LEVEL 1 AREA B	180-DEG	RECESSED CEILING MOUNTED	TELCO B130
C25	INTERIOR	LEVEL 1 AREA B	180-DEG	RECESSED CEILING MOUNTED	TELCO B130
C26	EXTERIOR	LEVEL 1 AREA B	180-DEG	WALL MOUNTED	TELCO B130
C27	EXTERIOR	LEVEL 1 AREA B	180-DEG	WALL MOUNTED	TELCO B130
C28	EXTERIOR	LEVEL 1 AREA B	180-DEG	WALL MOUNTED	TELCO B130
C30	EXTERIOR	LEVEL 1 AREA B	180-DEG	WALL MOUNTED	TELCO B130
C31	EXTERIOR	LEVEL 1 AREA B	180-DEG	WALL MOUNTED	TELCO B130
C32	EXTERIOR	LEVEL 1 AREA B	180-DEG	WALL MOUNTED	TELCO B130
C33	EXTERIOR	LEVEL 1 AREA A	180-DEG	WALL MOUNTED	TELCO B130
C34	EXTERIOR	LEVEL 1 AREA A	180-DEG	WALL MOUNTED	TELCO B130
C35	EXTERIOR	LEVEL 1 AREA A	180-DEG	WALL MOUNTED	TELCO B130
C36	EXTERIOR	LEVEL 1 AREA A	180-DEG	WALL MOUNTED	TELCO B130
C37	EXTERIOR	LEVEL 1 AREA A	180-DEG	WALL MOUNTED	TELCO B130
C38	INTERIOR	LEVEL 1 AREA A	180-DEG	WALL MOUNTED	TELCO B130
C39	INTERIOR	LEVEL 1 AREA A	360-DEG	WALL MOUNTED	TELCO B130
C40	INTERIOR	LEVEL 1 AREA A	180-DEG	WALL MOUNTED	TELCO B130
C41	INTERIOR	LEVEL 1 AREA B	180-DEG	WALL MOUNTED	TELCO B130
C42	INTERIOR	LEVEL 1 AREA B	180-DEG	WALL MOUNTED	TELCO B130
C43	INTERIOR	LEVEL 2 AREA A	180-DEG	RECESSED CEILING MOUNTED	SERVER G124A
C44	INTERIOR	LEVEL 2 AREA A	180-DEG	RECESSED CEILING MOUNTED	SERVER G124A
C45	INTERIOR	LEVEL 2 AREA B	360-DEG	RECESSED CEILING MOUNTED	SERVER G124A
C46	INTERIOR	LEVEL 2 AREA B	180-DEG	RECESSED CEILING MOUNTED	SERVER G124A
C47	INTERIOR	LEVEL 2 AREA B	180-DEG	RECESSED CEILING MOUNTED	SERVER G124A
C48	INTERIOR	LEVEL 2 AREA B	180-DEG	RECESSED CEILING MOUNTED	SERVER G124A
C49	INTERIOR	LEVEL 2 AREA B	180-DEG	RECESSED CEILING MOUNTED	SERVER G124A
C50	INTERIOR	LEVEL 2 AREA B	180-DEG	RECESSED CEILING MOUNTED	TELCO B130
C51	INTERIOR	LEVEL 2 AREA B	180-DEG	RECESSED CEILING MOUNTED	TELCO B130
C52	INTERIOR	LEVEL 2 AREA B	180-DEG	WALL MOUNTED	TELCO B130
C53	INTERIOR	LEVEL 2 AREA B	180-DEG	RECESSED CEILING MOUNTED	TELCO B130
C54	INTERIOR	LEVEL 2 AREA B	180-DEG	RECESSED CEILING MOUNTED	TELCO B130
C55	INTERIOR	LEVEL 2 AREA B	180-DEG	WALL MOUNTED	TELCO B130
C56	INTERIOR	LEVEL 2 AREA B	180-DEG	WALL MOUNTED	TELCO B130
C57	INTERIOR	LEVEL 2 AREA D	180-DEG	RECESSED CEILING MOUNTED	TELCO B130
C58	INTERIOR	LEVEL 2 AREA C	180-DEG	RECESSED CEILING MOUNTED	TELCO B130
C59	INTERIOR	LEVEL 2 AREA C	180-DEG	RECESSED CEILING MOUNTED	SERVER G124A

3

SECURITY CAMERA SCHEDULE					
ID	LOCATION	AREA	CAMERA TYPE	MOUNTING TYPE	TELCO ROOM
C60	INTERIOR	LEVEL 2 AREA C	180-DEG	RECESSED CEILING MOUNTED	SERVER G124A
C61	INTERIOR	LEVEL 2 AREA C	180-DEG	RECESSED CEILING MOUNTED	SERVER G124A
C62	EXTERIOR	LEVEL 1 AREA A	180-DEG	WALL MOUNTED	TELCO B130
C63	EXTERIOR	LEVEL 1 AREA A	180-DEG	WALL MOUNTED	TELCO B130
C64	EXTERIOR	LEVEL 1 AREA A	180-DEG	WALL MOUNTED	TELCO B130
C65	EXTERIOR	LEVEL 1 AREA B	180-DEG	WALL MOUNTED	TELCO B130
C66	EXTERIOR	LEVEL 1 AREA B	180-DEG	WALL MOUNTED	TELCO B130
C67	EXTERIOR	LEVEL 1 AREA B	180-DEG	WALL MOUNTED	TELCO B130
C68	EXTERIOR	LEVEL 1 AREA B	180-DEG	WALL MOUNTED	TELCO B130
C69	EXTERIOR	LEVEL 1 AREA B	180-DEG	WALL MOUNTED	TELCO B130
C70	INTERIOR	LEVEL 2 AREA D	180-DEG	RECESSED CEILING MOUNTED	SERVER G124A
C71	EXTERIOR	LEVEL 1 AREA A	180-DEG	WALL MOUNTED	TELCO B130
C72	INTERIOR	LEVEL 1 AREA A	180-DEG	RECESSED CEILING MOUNTED	TELCO B130
C73	INTERIOR	LEVEL 1 AREA A	180-DEG	RECESSED CEILING MOUNTED	TELCO B130
C74	INTERIOR	LEVEL 1 AREA A	180-DEG	RECESSED CEILING MOUNTED	TELCO B130
C75	INTERIOR	LEVEL 1 AREA A	180-DEG	RECESSED CEILING MOUNTED	TELCO B130
C76	INTERIOR	LEVEL 1 AREA B	180-DEG	WALL MOUNTED	TELCO B130
C77	INTERIOR	LEVEL 1 AREA B	180-DEG	RECESSED CEILING MOUNTED	TELCO B130
C78	INTERIOR	LEVEL 1 AREA B	180-DEG	RECESSED CEILING MOUNTED	TELCO B130
C79	EXTERIOR	LEVEL 1 AREA C	180-DEG	WALL MOUNTED	TELCO D127
C80	EXTERIOR	LEVEL 1 AREA C	180-DEG	WALL MOUNTED	TELCO D127
C81	EXTERIOR	LEVEL 1 AREA C	180-DEG	RECESSED CEILING MOUNTED	TELCO D127
C82	INTERIOR	LEVEL 1 AREA C	180-DEG	WALL MOUNTED	TELCO D127
C83	EXTERIOR	LEVEL 1 AREA C	180-DEG	RECESSED CEILING MOUNTED	TELCO D127
C84	EXTERIOR	LEVEL 2 AREA A	PTZ	WALL MOUNTED	SERVER G124A
C85	EXTERIOR	LEVEL 2 AREA B	PTZ	WALL MOUNTED	SERVER G124A
C86	EXTERIOR	LEVEL 2 AREA B	PTZ	WALL MOUNTED	SERVER G124A
C87	INTERIOR	LEVEL 2 AREA B	180-DEG	WALL MOUNTED	TELCO B130
C88	INTERIOR	LEVEL 2 AREA B	180-DEG	RECESSED CEILING MOUNTED	SERVER G124A
C89	EXTERIOR	LEVEL 2 AREA C	180-DEG	WALL MOUNTED	SERVER G124A
C90	EXTERIOR	LEVEL 2 AREA C	180-DEG	WALL MOUNTED	SERVER G124A
C91	EXTERIOR	LEVEL 2 AREA C	180-DEG	WALL MOUNTED	SERVER G124A
C92	EXTERIOR	LEVEL 2 AREA C	180-DEG	WALL MOUNTED	SERVER G124A
C93	EXTERIOR	LEVEL 2 AREA C	180-DEG	WALL MOUNTED	SERVER G124A
C94	EXTERIOR	LEVEL 2 AREA C	180-DEG	WALL MOUNTED	SERVER G124A
C95	EXTERIOR	LEVEL 2 AREA C	180-DEG	WALL MOUNTED	SERVER G124A
C96	EXTERIOR	LEVEL 2 AREA C	180-DEG	WALL MOUNTED	SERVER G124A
C97	EXTERIOR	LEVEL 2 AREA C	180-DEG	WALL MOUNTED	SERVER G124A
C98	INTERIOR	LEVEL 2 AREA C	180-DEG	RECESSED CEILING MOUNTED	SERVER G124A
C99	INTERIOR	LEVEL 2 AREA C	360-DEG	RECESSED CEILING MOUNTED	SERVER G124A
C100	INTERIOR	LEVEL 2 AREA C	180-DEG	RECESSED CEILING MOUNTED	SERVER G124A
C101	INTERIOR	LEVEL 2 AREA C	360-DEG	RECESSED CEILING MOUNTED	SERVER G124A
C102	INTERIOR	LEVEL 2 AREA C	180-DEG	RECESSED CEILING MOUNTED	SERVER G124A
C103	INTERIOR	LEVEL 2 AREA C	360-DEG	RECESSED CEILING MOUNTED	SERVER G124A
C104	INTERIOR	LEVEL 1 AREA A	180-DEG	WALL MOUNTED	TELCO B130
C105	INTERIOR	LEVEL 1 AREA B	180-DEG	WALL MOUNTED	TELCO B130
C106	INTERIOR	LEVEL 2 AREA A	180-DEG	WALL MOUNTED	SERVER G124A
C107	EXTERIOR	LEVEL 1 AREA B	180-DEG	WALL MOUNTED	TELCO B130
C108	EXTERIOR	LEVEL 1 AREA B	180-DEG	WALL MOUNTED	TELCO B130
C109	INTERIOR	LEVEL 1 AREA B	180-DEG	RECESSED CEILING MOUNTED	TELCO B130
C110	INTERIOR	LEVEL 1 AREA B	180-DEG	RECESSED CEILING MOUNTED	TELCO B130

GENERAL DEMOLITION NOTES

A. PROVIDE ALL PATCH PANELS AND ACTIVE EQUIPMENT REQUIRED TO SUPPORT CAMERAS TERMINATED IN EACH TELCO ROOM. COORDINATE WITH THE AIRPORT/FAYETTEVILLE IT IN FIELD TO DETERMINE BEST RACK MOUNT LOCATION FOR THIS EQUIPMENT. PROVIDE EQUIPMENT AS DESCRIBED IN SPECIFICATION SECTION 282000, 2.11, B, 1.

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RMF Project No: 2153223.F0

Fayetteville Regional Airport – Airline Terminal Improvements Part 2

TELECOMMUNICATIONS SCHEDULES

400 Airport Road
Fayetteville, North Carolina 28306

DRAWN BY: JMT
REVIEWED BY: JMT
DATE: 07-18-19
PROJECT NO.: 1808

REVISIONS		
1	DES-17	04/16/21
2	DES-18	04/28/21
3	DES-19	05/13/21

SHEET NUMBER

TN6.02

SHEET ADDED