PLUMBING SYMBOLS

GENERAL SYMBOLS

GENERAL ABBREVIATIONS

NOTE: THIS IS A STANDARD ABBREVIATION LIST. SOME ABBREVIATIONS MAY NOT APPEAR ON THE ACCOMPANYING DRAWINGS.

SYMBOL DESCRIPTION DOMESTIC COLD WATER (POTABLE) DOMESTIC HOT WATER DOMESTIC HOT WATER RECIRCULATION SANITARY ABOVE FLOOR SANITARY BELOW FLOOR VENT ----

PIPING SYSTEMS

COMPONENTS AND SPECIALTIES					
SYMBOL	DESCRIPTION				
CO	CLEAN OUT (WALL/PIPE)				
OCO	CLEAN OUT (FLOOR)				
——————————————————————————————————————	COLD WATER INTERIOR HOSE BIBB				
	FLOOR DRAIN				
	FLOOR DRAIN WITH TRAP PRIMING LINE				
——Ø——	SHOCK ARRESTER				

EQUIPMENT DESIGNATIONS

DESIGNATION	DESCRIPTION
FD-X	FLOOR DRAIN DESIGNATION
P-X	PLUMBING FIXTURE DESIGNATION

PIPING SYMBOLS

SYMBOL	DESCRIPTION
———Э	PIPE DROP
——O ——Ø	PIPE RISE
	PIPE CAP
	BRANCH TAKE OFF
	PIPE DROP TEE
	PIPE RISE TEE
───	SHUTOFF VALVE


<u>DESIGNATION</u>	DESCRIPTION DEMOLITION WORK EXISTING WORK NEW WORK
REFE! DESIGNATION	RENCE SYMBOLS DESCRIPTION
<u>DEGIGIA (HON</u>	
XX·	- FLOOR PLAN NUMBER PARTIAL FLOOR PLAN NUMBER ELEVATION = LETTER DETAIL = NUMBER - SHEET NUMBER ON WHICH THE PARTIAL PLAN, ELEVATION OR DETAIL IS DRAWN - SHEET NUMBER WHERE PARTIAL PLAN, ELEVATION OR DETAIL IS TAKEN FROM
	POINT OF CONNECTION TO EXISTING
	POINT OF DISCONNECTION

LINETYPE SYMBOLS

Α	COMPRESSED AIR	FOT	FUEL OIL TRANSFER	OED	OPEN ENDED DUCT
AAV	AUTOMATIC AIR VENT	FOV	FUEL OIL VENT	OS&Y	OUTSIDE STEM AND YOKE
ACV	AUTOMATIC CONTROL VALVE	FPM	FEET PER MINUTE		
AD	ACCESS DOOR, AREA DRAIN	FPS	FEET PER SECOND	P&ID	PROCESS AND INSTRUMENTATION DIAGRAM
AF	ANTIFREEZE	FS	FLOW SWITCH	PA	PLANT AIR
AFF	ABOVE FINISHED FLOOR	FT	FOOT. FEET	PC	PUMPED CONDENSATE
AR	ARGON GAS	FWR	FEED WATER RETURN	PCR	PUMPED CONDENSATE RECIRCULATION
ATC	AUTOMATIC TEMPERATURE CONTROL	FWS	FEED WATER SUPPLY	PCHR	PRIMARY CHILLED WATER RETURN
AIC	AUTOMATIC TEMPERATURE CONTROL	1 773	TEED WATER SOFFET	PCHS	PRIMARY CHILLED WATER SUPPLY
DAC	DUIL DING ALITOMATION SYSTEM	C	NATURAL CAS		
BAS	BUILDING AUTOMATION SYSTEM	G	NATURAL GAS	PCWR	PROCESS COOLING WATER CURRY
BBD	BOILER BLOWDOWN	GHR	GLYCOL HEATING RETURN	PCWS	PROCESS COOLING WATER SUPPLY
BCWR	BEARING COOLING WATER RETURN	GHS	GLYCOL HEATING SUPPLY	PD	PRESSURE DROP, PUMP DISCHARGE
BCWS	BEARING COOLING WATER SUPPLY	GPH	GALLONS PER HOUR	PGR	PROCESS GLYCOL WATER RETURN
BDD	BACKDRAFT DAMPER	GPM	GALLONS PER MINUTE	PGS	PROCESS GLYCOL WATER SUPPLY
BFP	BACKFLOW PREVENTER	GR	AUTOMOTIVE LUBRICATION PIPING	PH	PHASE
BHP	BRAKE HORSEPOWER			PHR	PRIMARY HEATING RETURN
BMS	BUILDING MANAGEMENT SYSTEM	Н	HIGH	PHS	PRIMARY HEATING SUPPLY
ВО	BLOW OFF	HB	HOSE BIBB	PIV	POST INDICATING VALVE
BTU	BRITISH THERMAL UNIT	HED	HOSE END DRAIN VALVE	PPH	POUNDS PER HOUR
BTUH	BRITISH THERMAL UNIT PER HOUR	HP	HORSEPOWER	PRV	PRESSURE REDUCING VALVE
		HPR	HIGH PRESSURE STEAM RETURN	PSI	POUNDS PER SQUARE INCH
°C	DEGREE(S) CELSIUS	HPS	HIGH PRESSURE STEAM SUPPLY	PSIG	POUNDS PER SQUARE INCH GAUGE
CA	CONTROL AIR	HR	HEATING WATER RETURN		
CBD	CONTINUOUS BLOWDOWN	HRR	HEAT RECOVERY RETURN	RA	RETURN AIR, RELIEF AIR
CC	CAMPUS CONDENSATE	HRS	HEAT RECOVERY SUPPLY	RD	REFRIGERANT DISCHARGE
CCMS	CENTRAL CONTROL AND MONITORING SYSTEM	HS	HEATING WATER SUPPLY	RH	RELATIVE HUMIDITY
CD	CONDENSATE DRAIN	HT	HEIGHT	RHR	REHEAT WATER RETURN
CF	CHEMICAL FEED	HTHR	HIGH TEMPERATURE HEATING WATER RETURN	RHS	REHEAT WATER SUPPLY
CFM	CUBIC FEET PER MINUTE	HTHS	HIGH TEMPERATURE HEATING WATER SUPPLY	RL	REFRIGERANT LIQUID
CHR	CHILLED WATER RETURN	HW	HOT WATER	ROR	REVERSE OSMOSIS WATER RETURN
CHS	CHILLED WATER SUPPLY	HWR	HOT WATER RECIRCULATION	ROS	REVERSE OSMOSIS WATER SUPPLY
CO	CLEANOUT	HZ	HERTZ	RPM	REVOLUTIONS PER MINUTE
CO2	CARBON DIOXIDE		112.112	RS	REFRIGERANT SUCTION
CS	CLEAN STEAM	IA	INSTRUMENT AIR	RV	RELIEF VENT, REFRIGERANT VENT
CW	COLD WATER, CITY WATER	ICW	INDUSTRIAL COLD WATER	RX	REMOVE EXISTING
CWR	CONDENSER WATER RETURN	IHW	INDUSTRIAL GOLD WATER	IVX	NEWOVE EXISTING
				C A	SUPPLY AIR
CWS	CONDENSER WATER SUPPLY	IHR	INDUSTRIAL HOT WATER RECIRCULATION	SA	
Б	DEED DDAINIMATED	IN IN / E1	INCH, INCHES	SAN	SANITARY, SOIL, WASTE
D	DEEP, DRAIN WATER	INV EL	INVERT ELEVATION	SCHR	SECONDARY CHILLED WATER RETURN
DB	DECIBEL, DRY BULB	12141	I/II OMATTO	SCHS	SECONDARY CHILLED WATER SUPPLY
DDC	DIRECT DIGITAL CONTROL	KW	KILOWATTS	SD	STORM DRAIN, SMOKE DETECTOR
DHR	DISTRIBUTION HEATING WATER RETURN			SF	SQUARE FOOT
DHS	DISTRIBUTION HEATING WATER SUPPLY	L	LONG, LENGTH	SHR	SECONDARY HEATING WATER RETURN
DIR	DEIONIZED WATER RETURN	LA	LABORATORY AIR	SHS	SECONDARY HEATING WATER SUPPLY
DIS	DEIONIZED WATER SUPPLY	LAT	LEAVING AIR TEMPERATURE	SL	SOUND LINING
DL	DOOR LOUVER	LBS	POUNDS	SP	STATIC PRESSURE
DN	DOWN	LBS/HR	POUNDS PER HOUR	SPR	SPRINKLER LINE
DSP	DRY SPRINKLER PIPE	LN	LIQUID NITROGEN	SS	STAINLESS STEEL
DTR	DUAL TEMPERATURE RETURN	LP	LIQUID PROPANE	SQ FT	SQUARE FOOT
DTS	DUAL TEMPERATURE SUPPLY	LPG	LIQUID PETROLEUM GAS	SW	SOFT WATER
DW	DISTILLED WATER	LPR	LOW PRESSURE STEAM RETURN		
		LPS	LOW PRESSURE STEAM SUPPLY	\triangleT	TEMPERATURE DIFFERENCE
EA	EXHAUST AIR	LV	LABORATORY VENT, LABORATORY VACUUM	TS	TAMPER SWITCH
EAT	ENTERING AIR TEMPERATURE	LW	LABORATORY WASTE	TSP	TOTAL STATIC PRESSURE
EJ	EXPANSION JOINT	LWT	LEAVING WATER TEMPERATURE	TWR	TEMPERED WATER RETURN
EMS	ENERGY MANAGEMENT SYSTEM			TWS	TEMPERED WATER SUPPLY
ESP	EXTERNAL STATIC PRESSURE	MA	MEDICAL AIR	TW	TREATED WATER
ETC	ETCETERA	MAV	MANUAL AIR VENT	TYP	TYPICAL
EVAC	GAS EVACUATION	MBH	THOUSAND BRITISH THERMAL UNITS PER HOUR		
EWT	ENTERING WATER TEMPERATURE	MCC	MOTOR CONTROL CENTER	UCD	UNDERCUT DOOR
EX	EXISTING	MO	MOTOR OIL PIPING	UL	UNDERWRITERS LABORATORIES
		MOD	MOTOR OPERATED DAMPER		
°F	DEGREE(S) FAHRENHEIT	MPR	MEDIUM PRESSURE STEAM RETURN	V	VACUUM, VOLTS
F	FIRE LINE	MPS	MEDIUM PRESSURE STEAM SUPPLY	VD	VOLUME DAMPER
FC	FLEXIBLE CONNECTION	MV	MEDICAL VACUUM	VFD	VARIABLE FREQUENCY DRIVE
FD	FIRE DAMPER, FOUNDATION DRAIN	•		VPD	VACUUM PUMP DISCHARGE
FDV	FIRE DEPARTMENT VALVE	N	NITROGEN	VSD	VARIABLE SPEED DRIVE
FF	FINISHED FLOOR	NA	NOT APPLICABLE	VTR	VENT THROUGH ROOF
FFE	FINISHED FLOOR ELEVATION	NC	NOISE CRITERIA, NORMALLY CLOSED	VIIX	
FIN/FT	FINS PER FEET	NFPA	NATIONAL FIRE PROTECTION ASSOCIATION	W	WATTS, WIDE
					·
FIN/INCH	FINS PER INCH	NO	NORMALLY OPEN, NITROUS OXIDE	WB	WET BULB
FM	FLOWMETER FITTING	NPSH	NET POSITIVE SUCTION HEAD	WC	WATER CALICE
FMF	FLOWMETER FITTING	2	OVVOEN	WG	WATER GAUGE
FOF	FUEL OIL FILL	0	OXYGEN	WH	WALL HYDRANT
FOO	FUEL OIL OVERFLOW	OA	OUTSIDE AIR	WWF	WELDED WIRE FABRIC
FOR	FUEL OIL RETURN	OD	OVERFLOW DRAIN	WWM	WELDED WIRE MESH
FOS	FUEL OIL SUPPLY				



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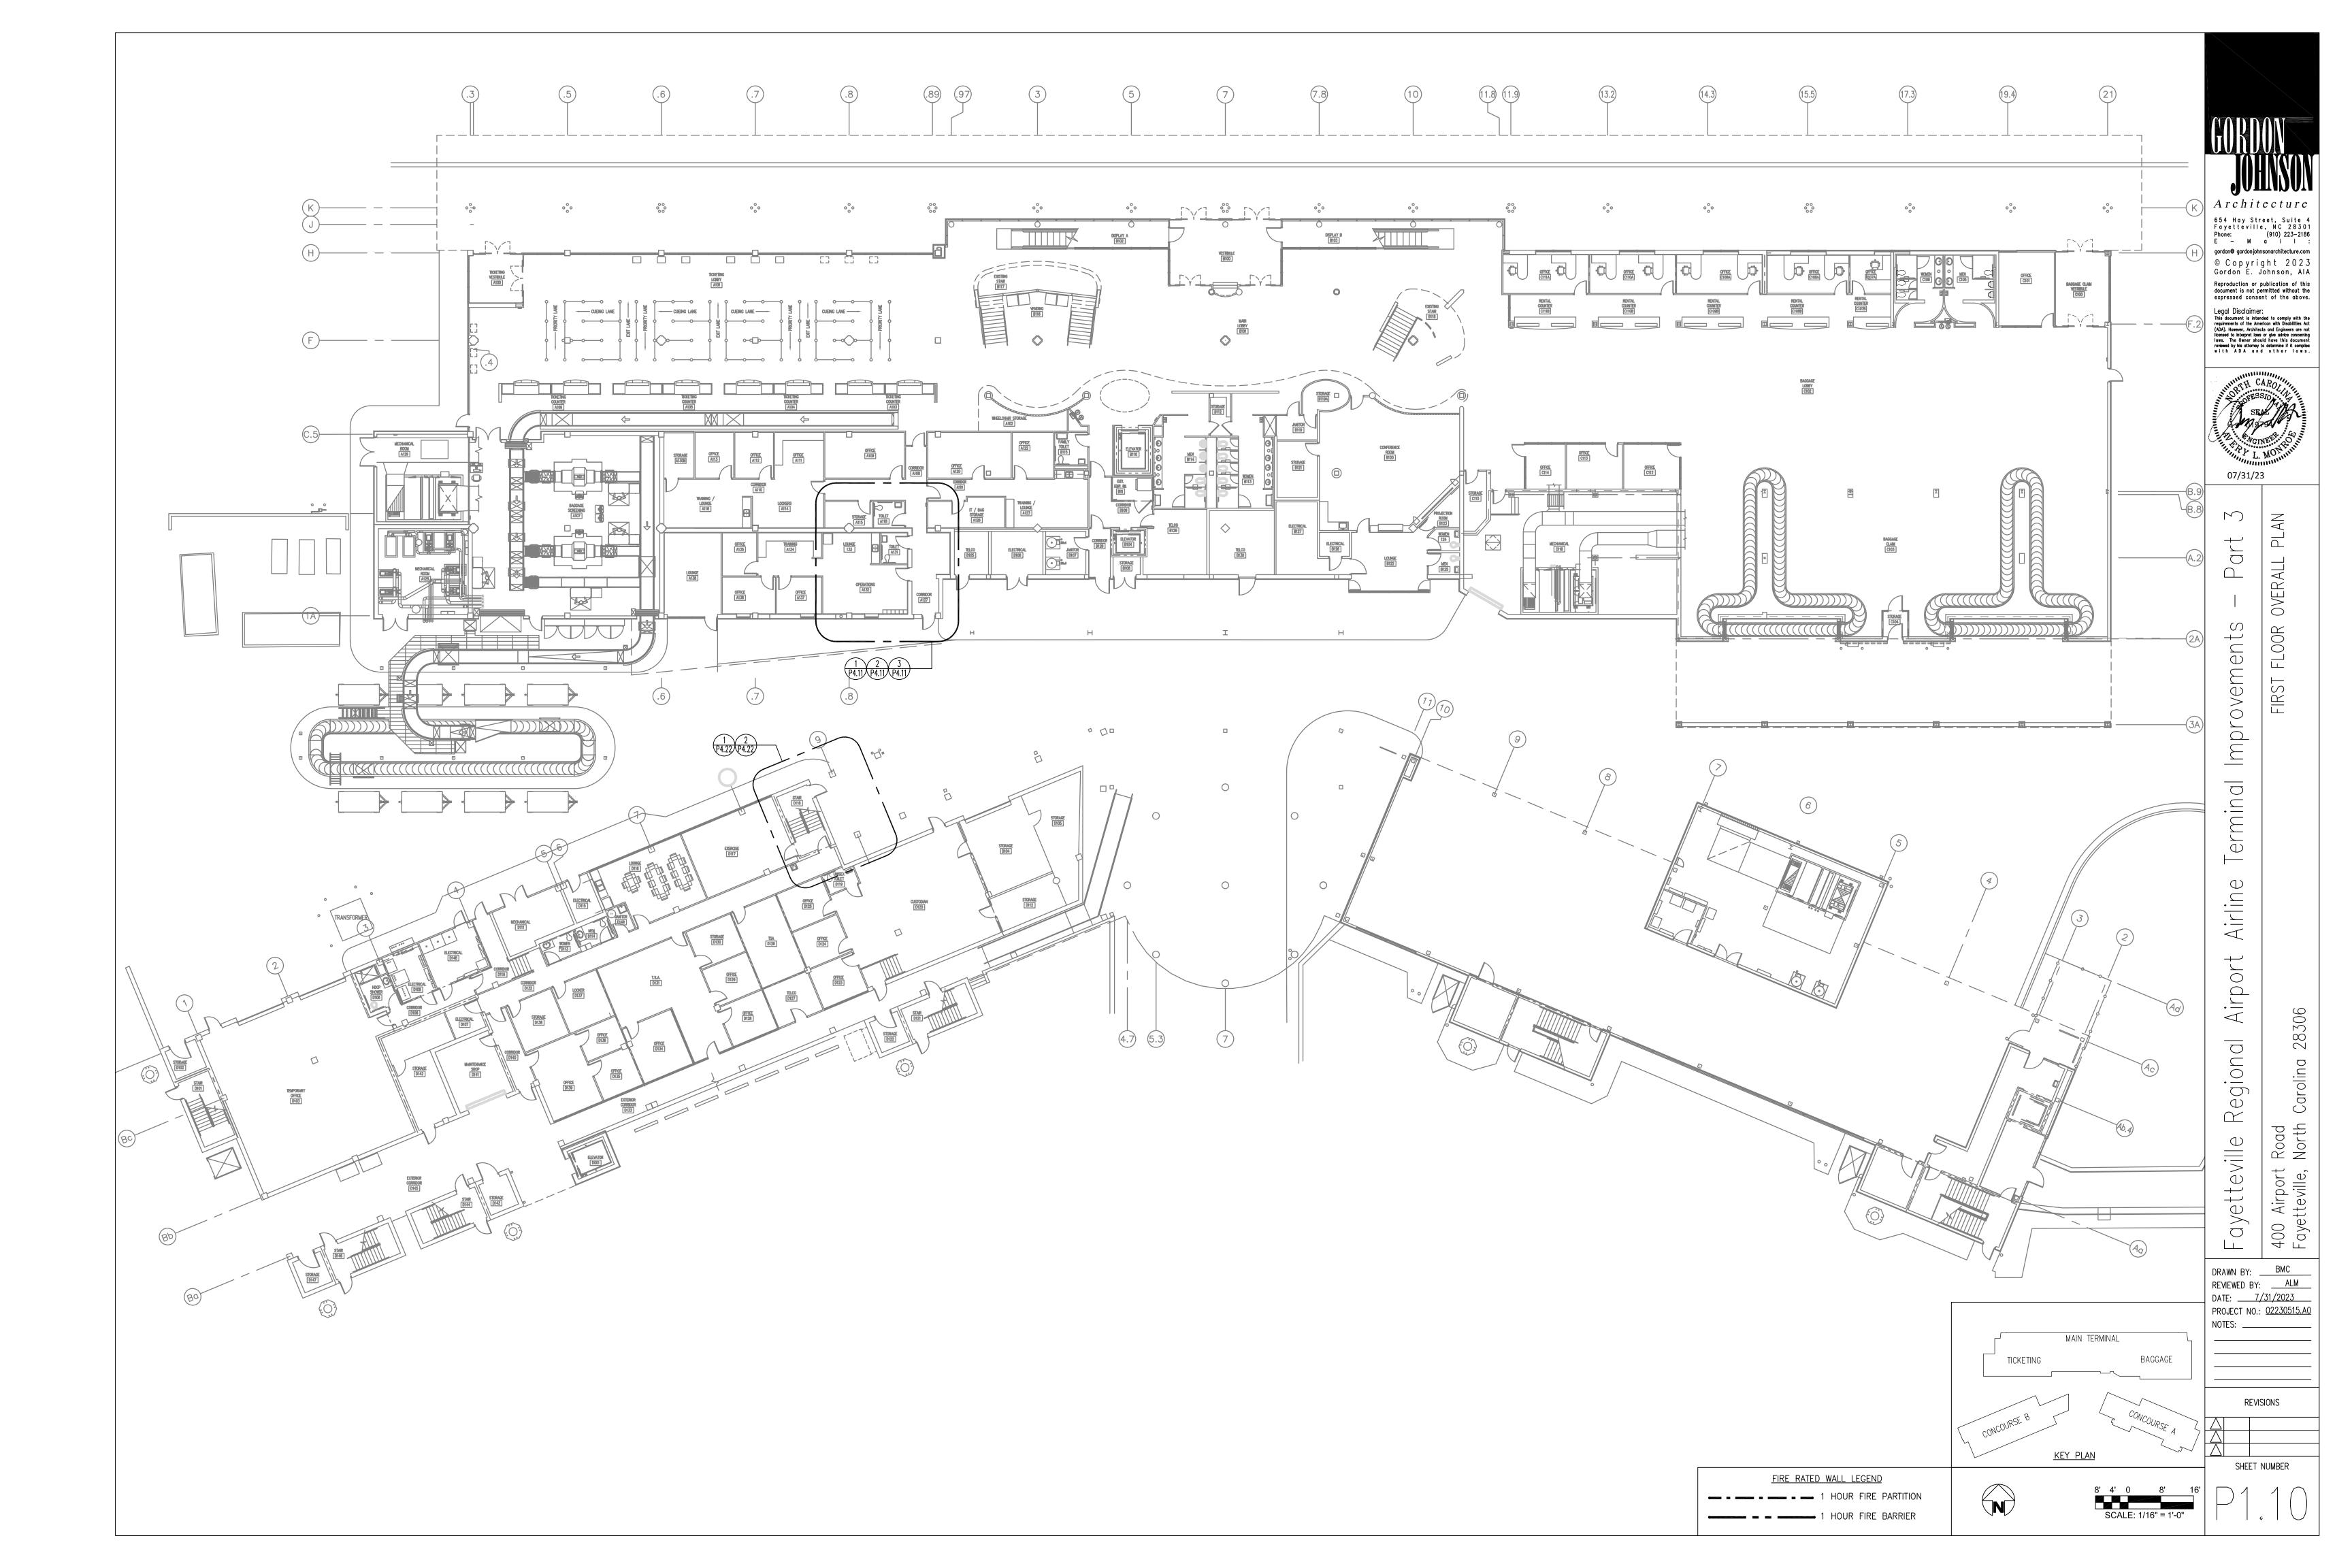
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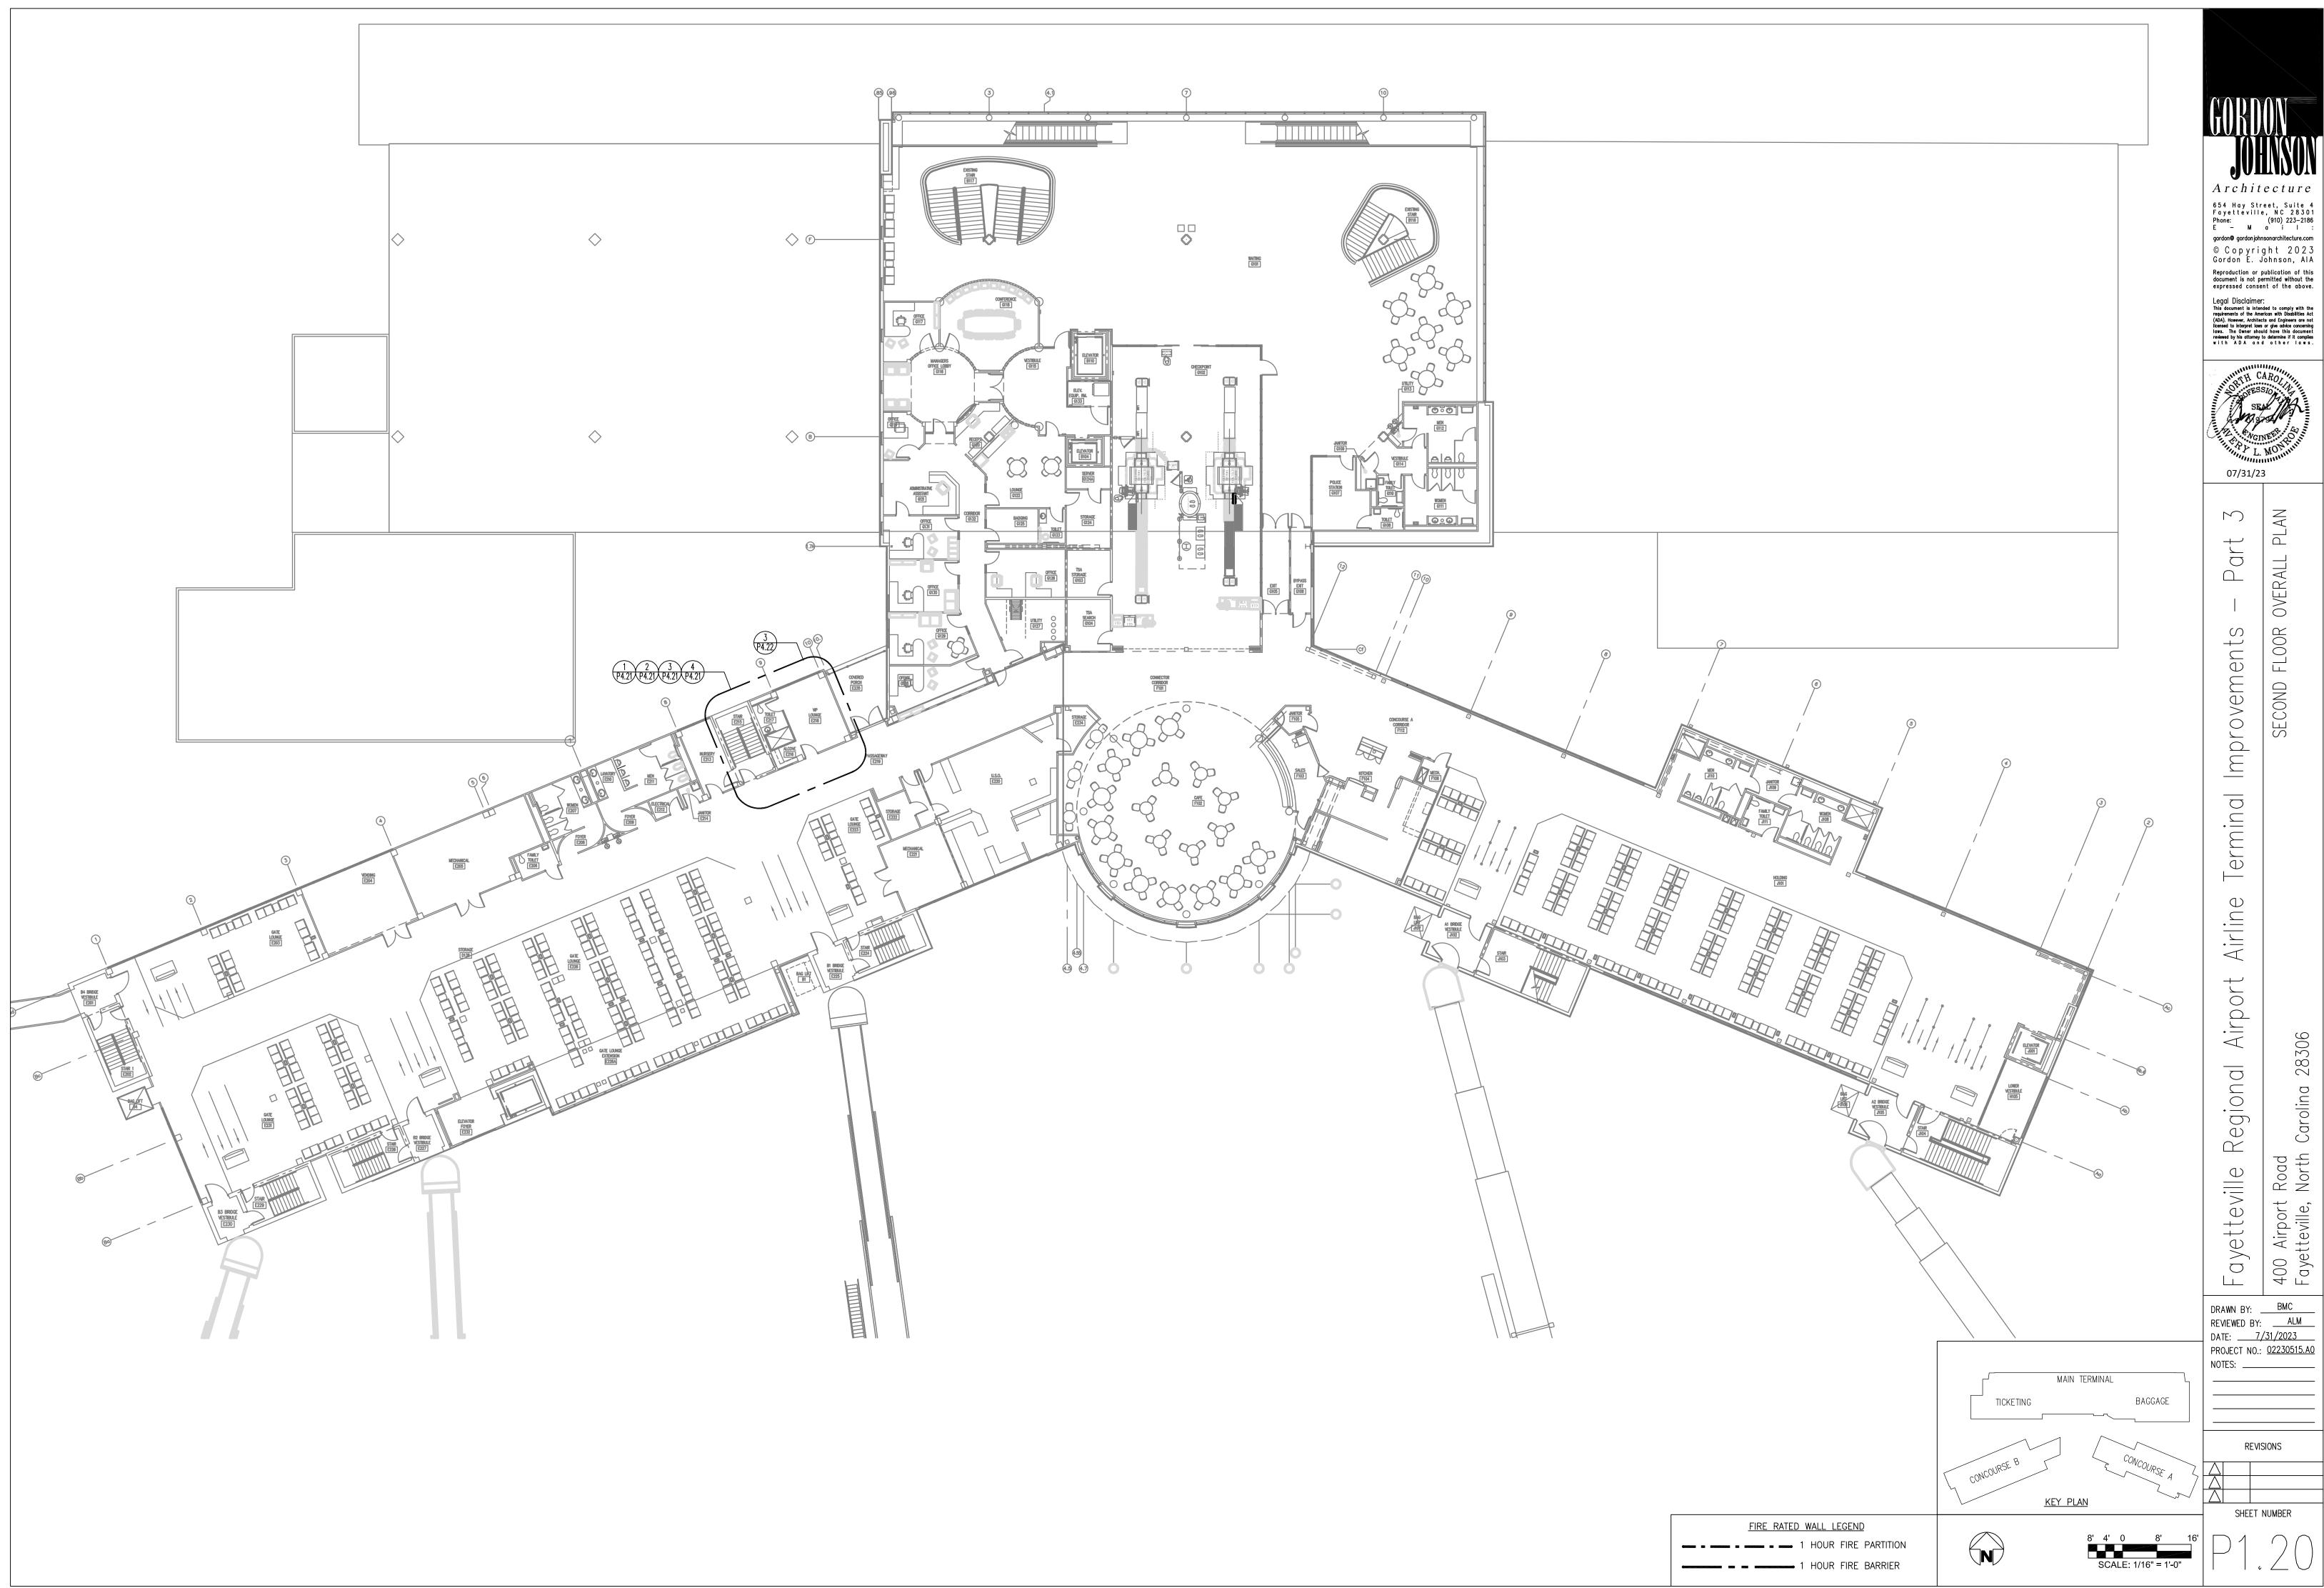
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DATE: ____7/31/2023

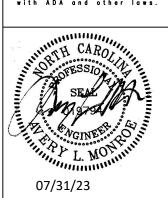
PROJECT NO.: 02230515.A0

REVISIONS





SCALE: 1/4" = 1'-0"

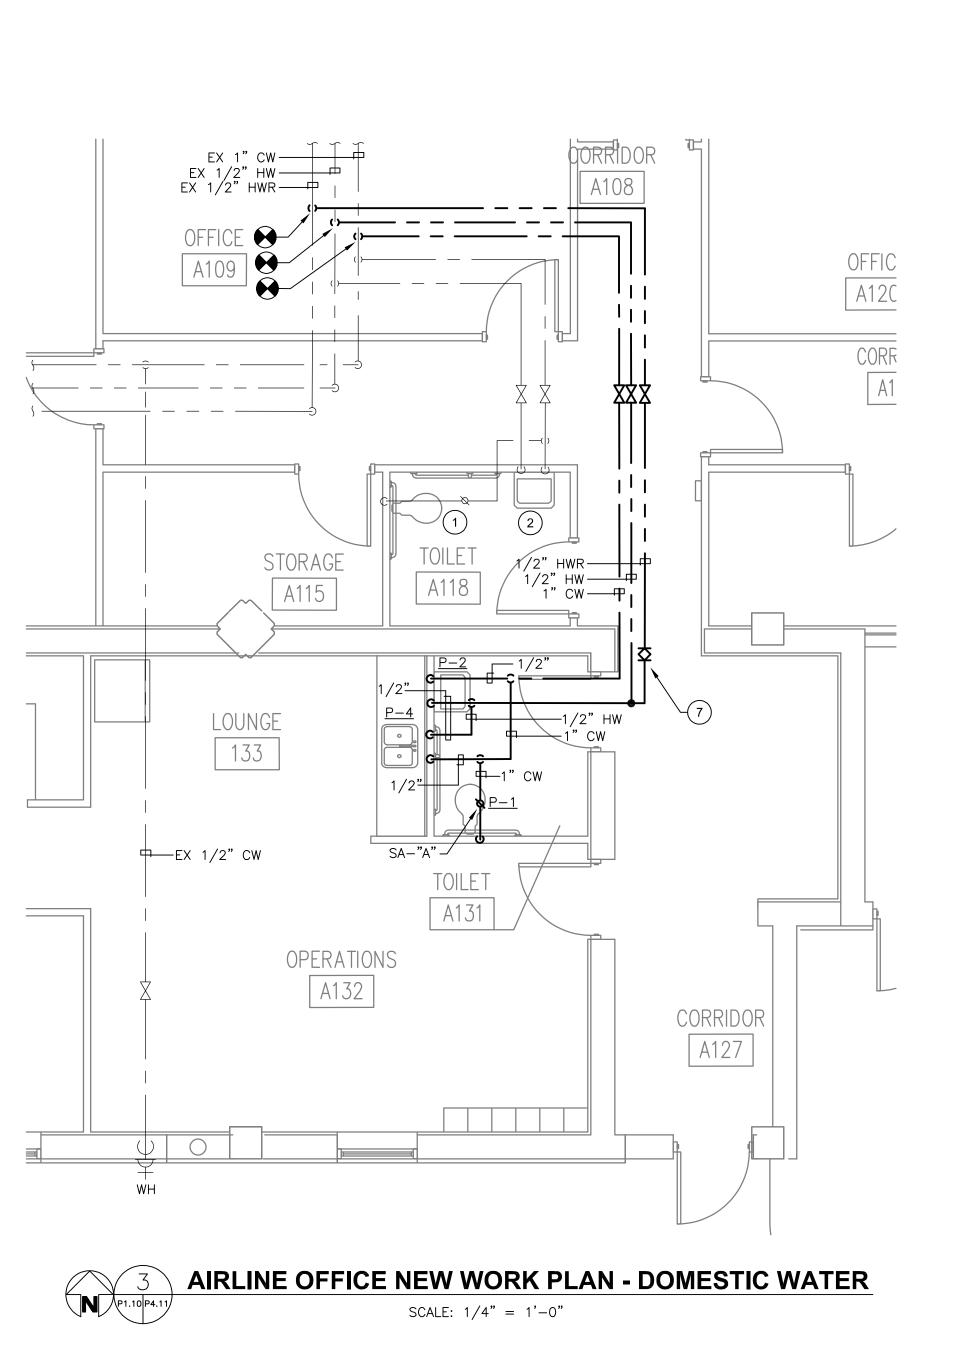


GENERAL NOTES:

- A. NOTIFY THE OWNER, IN WRITING, AT LEAST SEVEN (7) DAYS IN ADVANCE OF ALL REQUIRED SHUTDOWNS OF PLUMBING SERVICES, OR OTHER UTILITIES. UPON WRITTEN RECEIPT OF APPROVAL FROM OWNER, SHUTDOWNS SHALL BE ACCOMPLISHED AT NO ADDITIONAL CONTRACT COST. AT THE END OF EACH SHUT DOWN ALL SERVICES SHALL BE RESTORED.
- B. WHEN WORKING IN AND AROUND THE EXISTING BUILDING, EXTREME CARE SHALL BE EXERCISED WITH REGARD TO PROTECTION OF THE EXISTING STRUCTURE, FIRE PROTECTION, PLUMBING, MECHANICAL AND ELECTRICAL SERVICES WHICH WILL REMAIN. REPAIR, REPLACE, OR RESTORE TO THE SATISFACTION OF THE OWNER ALL EXISTING WORK DAMAGED IN THE PERFORMANCE OF DEMOLITION AND/OR NEW YORK
- C. ALL EXISTING FIXTURES, PIPING, AND MATERIALS NOT REQUIRED FOR RE-USE OR RE-INSTALLATION (SHOWN OR OTHERWISE) SHALL BE REMOVED. ALL EXISTING MATERIALS AND EQUIPMENT WHICH ARE REMOVED AND ARE DESIRED BY THE OWNER, OR ARE INDICATED TO THE PREMISES BY THE CONTRACTOR WHERE DIRECTED BY THE ENGINEER. ALL OTHER MATERIALS AND EQUIPMENT WHICH ARE REMOVED SHALL BECOME THE PROPERTY OF THE CONTRACTOR AND SHALL BE REMOVED BY THE CONTRACTOR FROM THE PREMISES.
- D. EXISTING CONDITIONS, I.E., PRESENCE AND LOCATION OF FIXTURES, PIPING, EQUIPMENT, AND MATERIALS, INDICATED ARE BASED ON INFORMATION OBTAINED FROM AVAILABLE RECORD DRAWINGS AND FIELD SURVEYS AND ARE NOT WARRANTED TO BE COMPLETE OR CORRECT. CONTRACTOR SHALL FIELD VERIFY EXACT LOCATION OF ALL CONDUITS, EQUIPMENT, AND MATERIALS IN THE FIELD PRIOR TO STARTING ALL WORK.
- E. EXISTING PIPE SIZES NOTED ARE FOR THE CONVENIENCE OF THE CONTRACTOR ONLY AND ARE NOT WARRANTED TO BE CORRECT. CONTRACTOR SHALL VERIFY ALL SIZES IN THE FIELD IF THEY EFFECT HIS WORK.
- F. WHEN EXISTING PLUMBING WORK IS REMOVED, ALL PIPING AND MATERIALS SHALL BE REMOVED TO A POINT BELOW THE FINISHED FLOORS OR BEHIND FINISHED WALLS AND CAPPED. SUCH POINTS SHALL BE FAR ENOUGH BEHIND FINISHED SURFACES TO ALLOW FOR THE INSTALLATION OF THE NORMAL THICKNESS OF FINISHED MATERIAL.
- G. EXISTING FIXTURES & PIPING NO LONGER REQUIRED TO REMAIN IN SERVICE (SHOWN OR OTHERWISE) SHALL BE DISCONNECTED AND REMOVED BACK THE MAIN UNLESS OTHERWISE INDICATED OR NOTED ON THE PLANS. REMOVE EXISTING PIPE HANGERS, SUPPORTS, ETC..
- H. EXISTING MECHANICAL AND ELECTRICAL EQUIPMENT. CONDUIT, WIRING, DEVICES, AND MATERIALS AFFECTED BY DEMOLITION OR NEW WORK INSTALLATION AND REQUIRED TO REMAIN IN SERVICE SHALL BE REINSTALLED OR SUPPORTED AS REQUIRED IN ACCORDANCE WITH NEW WORK SPECIFICATION. ALL WORK SHALL BE COMPLETED TO THE SATISFACTION OF THE ENGINEER AND AT NO ADDITIONAL CONTRACT COST.
- I. PATCH TO MATCH EXISTING ALL NEW AND EXISTING OPENING AND WALLS, CEILINGS, ROOF, AND FLOOR SURFACES DAMAGED OR CREATED BY DEMOLITION WORK. PATCHING WHERE POSSIBLE SHALL MATCH EXISTING ADJACENT SURFACES AS TO THICKNESS, TEXTURES, MATERIALS, AND COLOR. ALL PATCHING SHALL BE PERFORMED TO THE SATISFACTION OF THE ARCHITECT AND AT NO ADDITIONAL CONTRACT COST.
- J. IN GENERAL ALL EQUIPMENT AND MATERIALS SHOWN "LIGHT" IS EXISTING TO REMAIN. ALL EQUIPMENT AND MATERIALS SHOWN "HEAVY AND HATCHED" IS EXISTING AND SHALL BE DEMOLISHED.
- K. ALL WASTE AND VENT PIPING SHOWN IN VIEW P4.11/1 IS BELOW GRADE.
- L. EXISTING STORM PIPING IS SHOWN FOR COORDINATION.

DRAWING NOTES:

- 1) WATER CLOSET IS EXISTING TO REMAIN.
- (2) LAVATORY IS EXISTING TO REMAIN.
- (3) EXTEND 2" WASTE PIPING UP AND PROVIDE WALL CLEANOUT.
- (4) CONNECT NEW 4" WASTE PIPING TO EXISTING 4" WASTE PIPING.
- (5) EXTEND 4" WASTE PIPING UP AND PROVIDE WALL CLEANOUT.
- (6) CONNECT NEW 2" VENT BRANCH PIPING TO EXISTING 2" VENT MAIN.
- (7)1/2" BALANCING VALVE. SE TO 0.5 GPM.

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Fayetteville DRAWN BY: ____BMC REVIEWED BY: <u>ALM</u>
DATE: <u>7/31/2023</u> PROJECT NO.: 02230515.A0

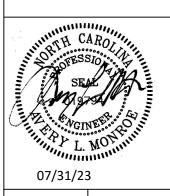REVISIONS

SHEET NUMBER


KEY PLAN

MAIN TERMINAL


FIRE RATED WALL LEGEND 1 HOUR FIRE PARTITION

1 HOUR FIRE BARRIER

TICKETING

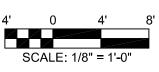



BAGGAGE

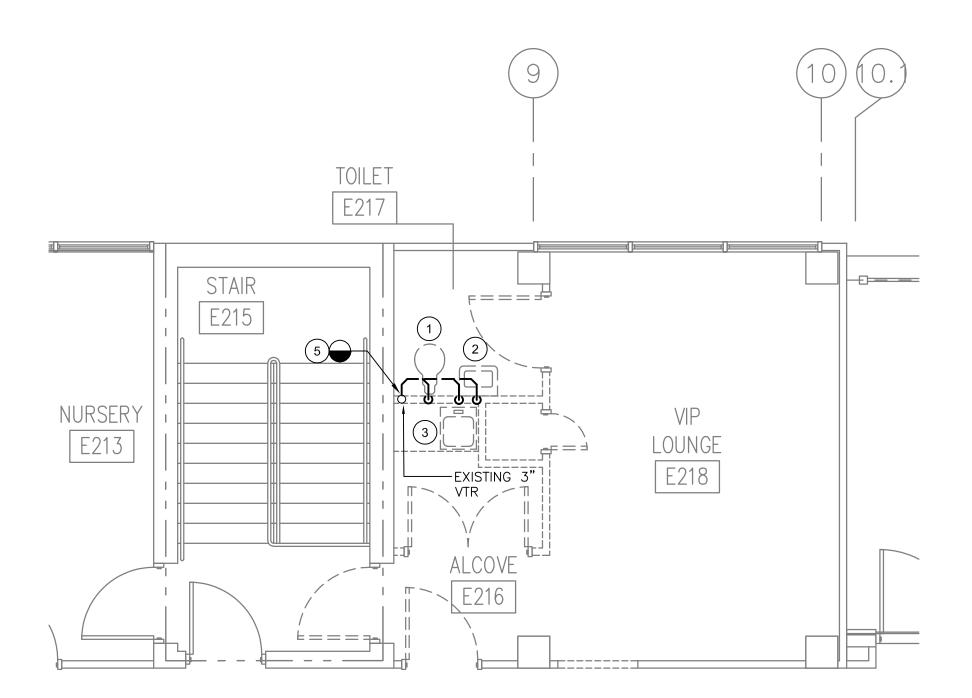





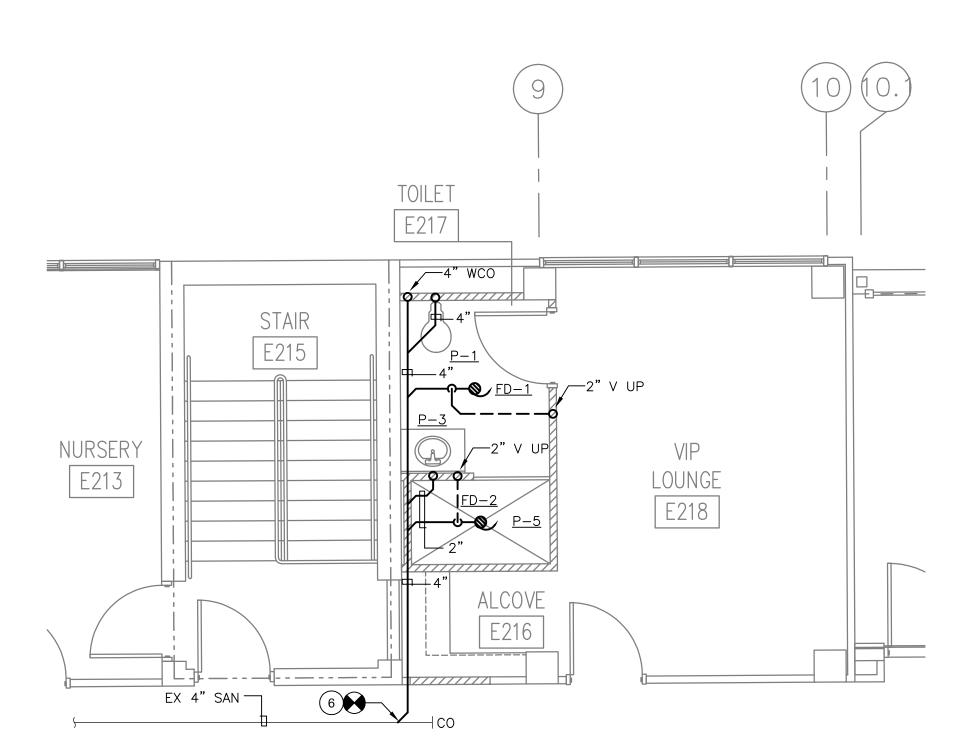

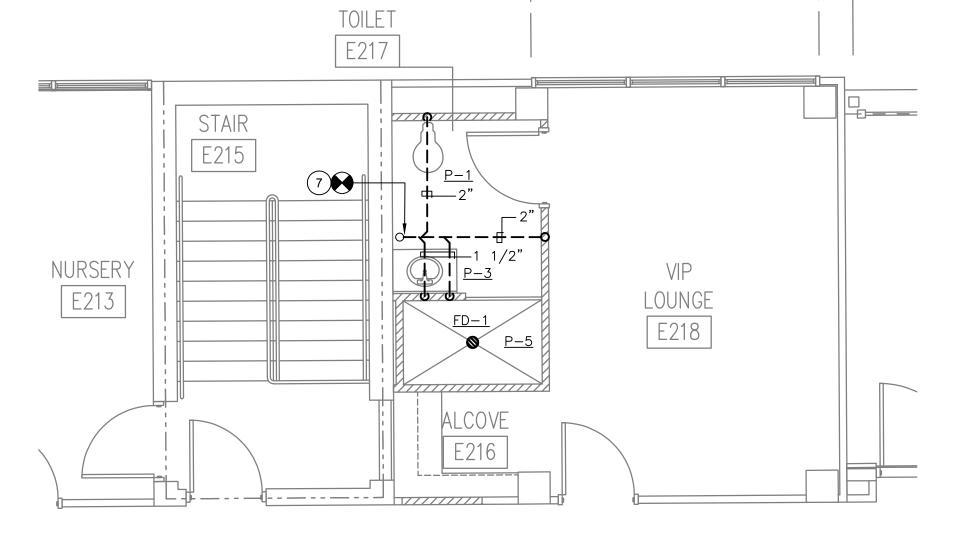





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- K. EXISTING AND NEW WASTE PIPING SHOWN IS LOCATED IN THE CEILING SPACE OF THE LEVEL BELOW.


DRAWING NOTES:

- (1) REMOVE EXISTING WATER CLOSET AND ALL ASSOCIATED WASTE & VENT PIPING BACK TO THE POINT OF DISCONNECTION SHOWN.
- 2 REMOVE EXISTING LAVATORY AND ALL ASSOCIATED WASTE & VENT PIPING BACK TO THE POINT OF DISCONNECTION SHOWN.
- REMOVE EXISTING SINK AND ALL ASSOCIATED WASTE & VENT PIPING BACK TO THE POINT OF DISCONNECTION SHOWN.
- (4) REMOVE ALL EXISTING 3" WASTE PIPING BACK TO THE EXISTING 4" MAIN WASTE PIPE.
- (5) REMOVE ALL VENT PIPING BACK TO THE POINT OF DISCONNECTION SHOW. MAINTAIN EXISTING 3" VENT THROUGH ROOF FOR NEW VENT CONNECTION.
- 6 CONNECT NEW 4" WASTE PIPE TO EXISTING 4" WASTE PIPE.
- (7) CONNECT NEW 2" VENT PIPING TO THE EXISTING 3" VTR.
- (8) 2" VENT DOWN TO FLOOR DRAIN WASTE PIPING.
- 9 PROVIDE FLOOR DRAIN WITH WITH TRAP PRIMER. CONNECT TRAP PRIMER TO NEAREST FLUSH VALVE.

MAIN TERMINAL BAGGAGE TICKETING <u>KEY PLAN</u>

FIRE RATED WALL LEGEND


1 HOUR FIRE PARTITION 1 HOUR FIRE BARRIER

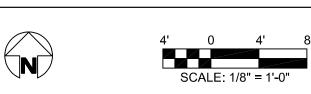

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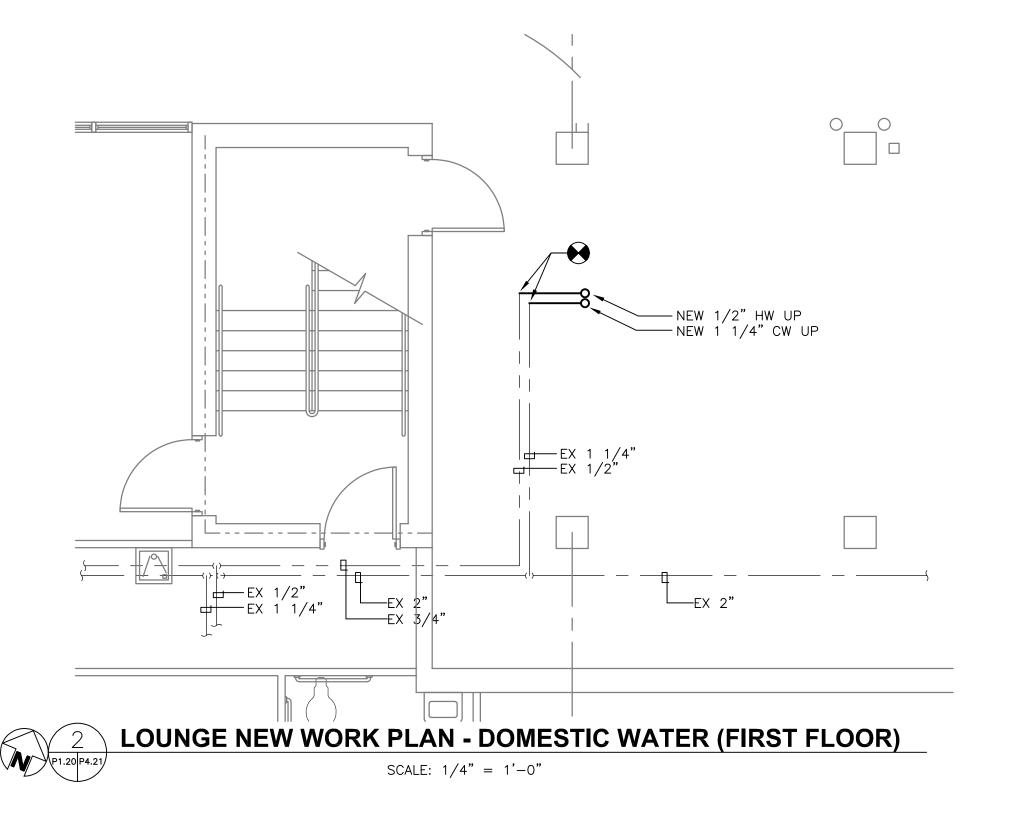
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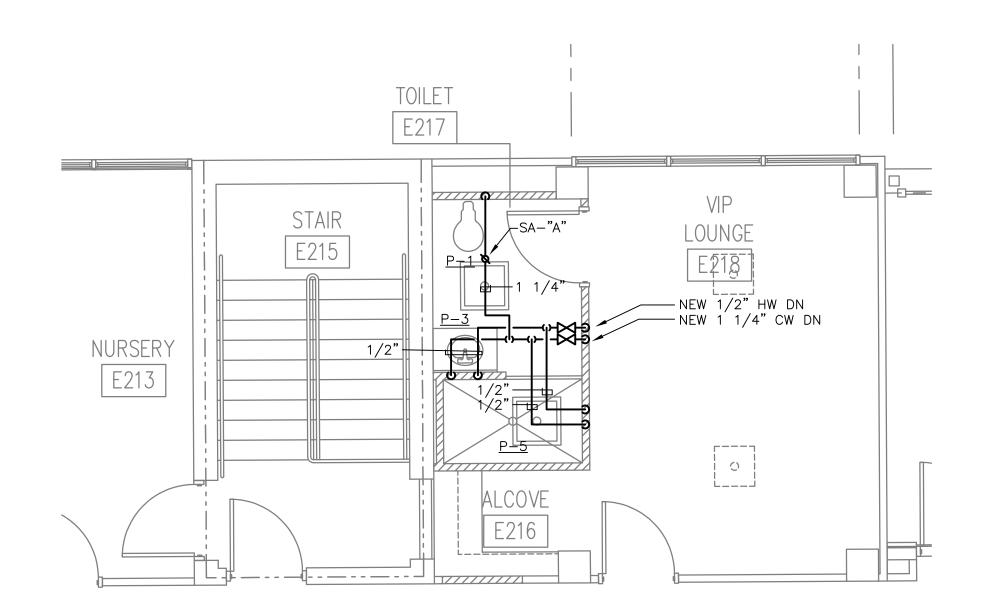
ayet DRAWN BY: ____BMC REVIEWED BY: ALM DATE: <u>7/31/2023</u> PROJECT NO.: 02230515.A0 NOTES: _____

REVISIONS

LOUNGE DEMOLITION PLAN - DOMESTIC WATER (FIRST FLOOR)

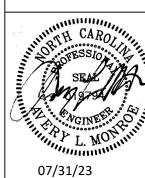SCALE: 1/4" = 1'-0"







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- E. EXISTING PIPE SIZES NOTED ARE FOR THE CONVENIENCE OF THE CONTRACTOR ONLY AND ARE NOT WARRANTED TO BE CORRECT. CONTRACTOR SHALL VERIFY ALL SIZES IN THE FIELD IF THEY EFFECT HIS WORK.
- F. WHEN EXISTING PLUMBING WORK IS REMOVED, ALL PIPING AND MATERIALS SHALL BE REMOVED TO A POINT BELOW THE FINISHED FLOORS OR BEHIND FINISHED WALLS AND CAPPED. SUCH POINTS SHALL BE FAR ENOUGH BEHIND FINISHED SURFACES TO ALLOW FOR THE INSTALLATION OF THE NORMAL THICKNESS OF FINISHED MATERIAL.
- G. EXISTING FIXTURES & PIPING NO LONGER REQUIRED TO REMAIN IN SERVICE (SHOWN OR OTHERWISE) SHALL BE DISCONNECTED AND REMOVED BACK THE MAIN UNLESS OTHERWISE INDICATED OR NOTED ON THE PLANS. REMOVE EXISTING PIPE HANGERS, SUPPORTS, ETC..
- H. EXISTING MECHANICAL AND ELECTRICAL EQUIPMENT. CONDUIT, WIRING, DEVICES, AND MATERIALS AFFECTED BY DEMOLITION OR NEW WORK INSTALLATION AND REQUIRED TO REMAIN IN SERVICE SHALL BE REINSTALLED OR SUPPORTED AS REQUIRED IN ACCORDANCE WITH NEW WORK SPECIFICATION. ALL WORK SHALL BE COMPLETED TO THE SATISFACTION OF THE ENGINEER AND AT NO ADDITIONAL CONTRACT COST.
- I. PATCH TO MATCH EXISTING ALL NEW AND EXISTING OPENING AND WALLS, CEILINGS, ROOF, AND FLOOR SURFACES DAMAGED OR CREATED BY DEMOLITION WORK. PATCHING WHERE POSSIBLE SHALL MATCH EXISTING ADJACENT SURFACES AS TO THICKNESS, TEXTURES, MATERIALS, AND COLOR. ALL PATCHING SHALL BE PERFORMED TO THE SATISFACTION OF THE ARCHITECT AND AT NO ADDITIONAL CONTRACT COST.
- J. IN GENERAL ALL EQUIPMENT AND MATERIALS SHOWN "LIGHT" IS EXISTING TO REMAIN. ALL EQUIPMENT AND MATERIALS SHOWN "HEAVY AND HATCHED" IS EXISTING AND SHALL BE DEMOLISHED.

DRAWING NOTES:

- (1)REMOVE EXISTING DOMESTIC WATER PIPING FROM THE EXISTING FIXTURE ABOVE, BACK TO THE POINT OF DISCONNECTION SHOWN.
- 2 CONNECT NEW DOMESTIC WATER PIPING AT THE POINT OF CONNECTION SHOWN AND ROUTE UP TO THE FLOOR ABOVE.



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ayetteville DRAWN BY: ____BMC REVIEWED BY: ALM DATE: <u>7/31/2023</u> PROJECT NO.: 02230515.A0 NOTES: _____

REVISIONS

SHEET NUMBER

BAGGAGE


MAIN TERMINAL

FIRE RATED WALL LEGEND 1 HOUR FIRE PARTITION

1 HOUR FIRE BARRIER



TICKETING

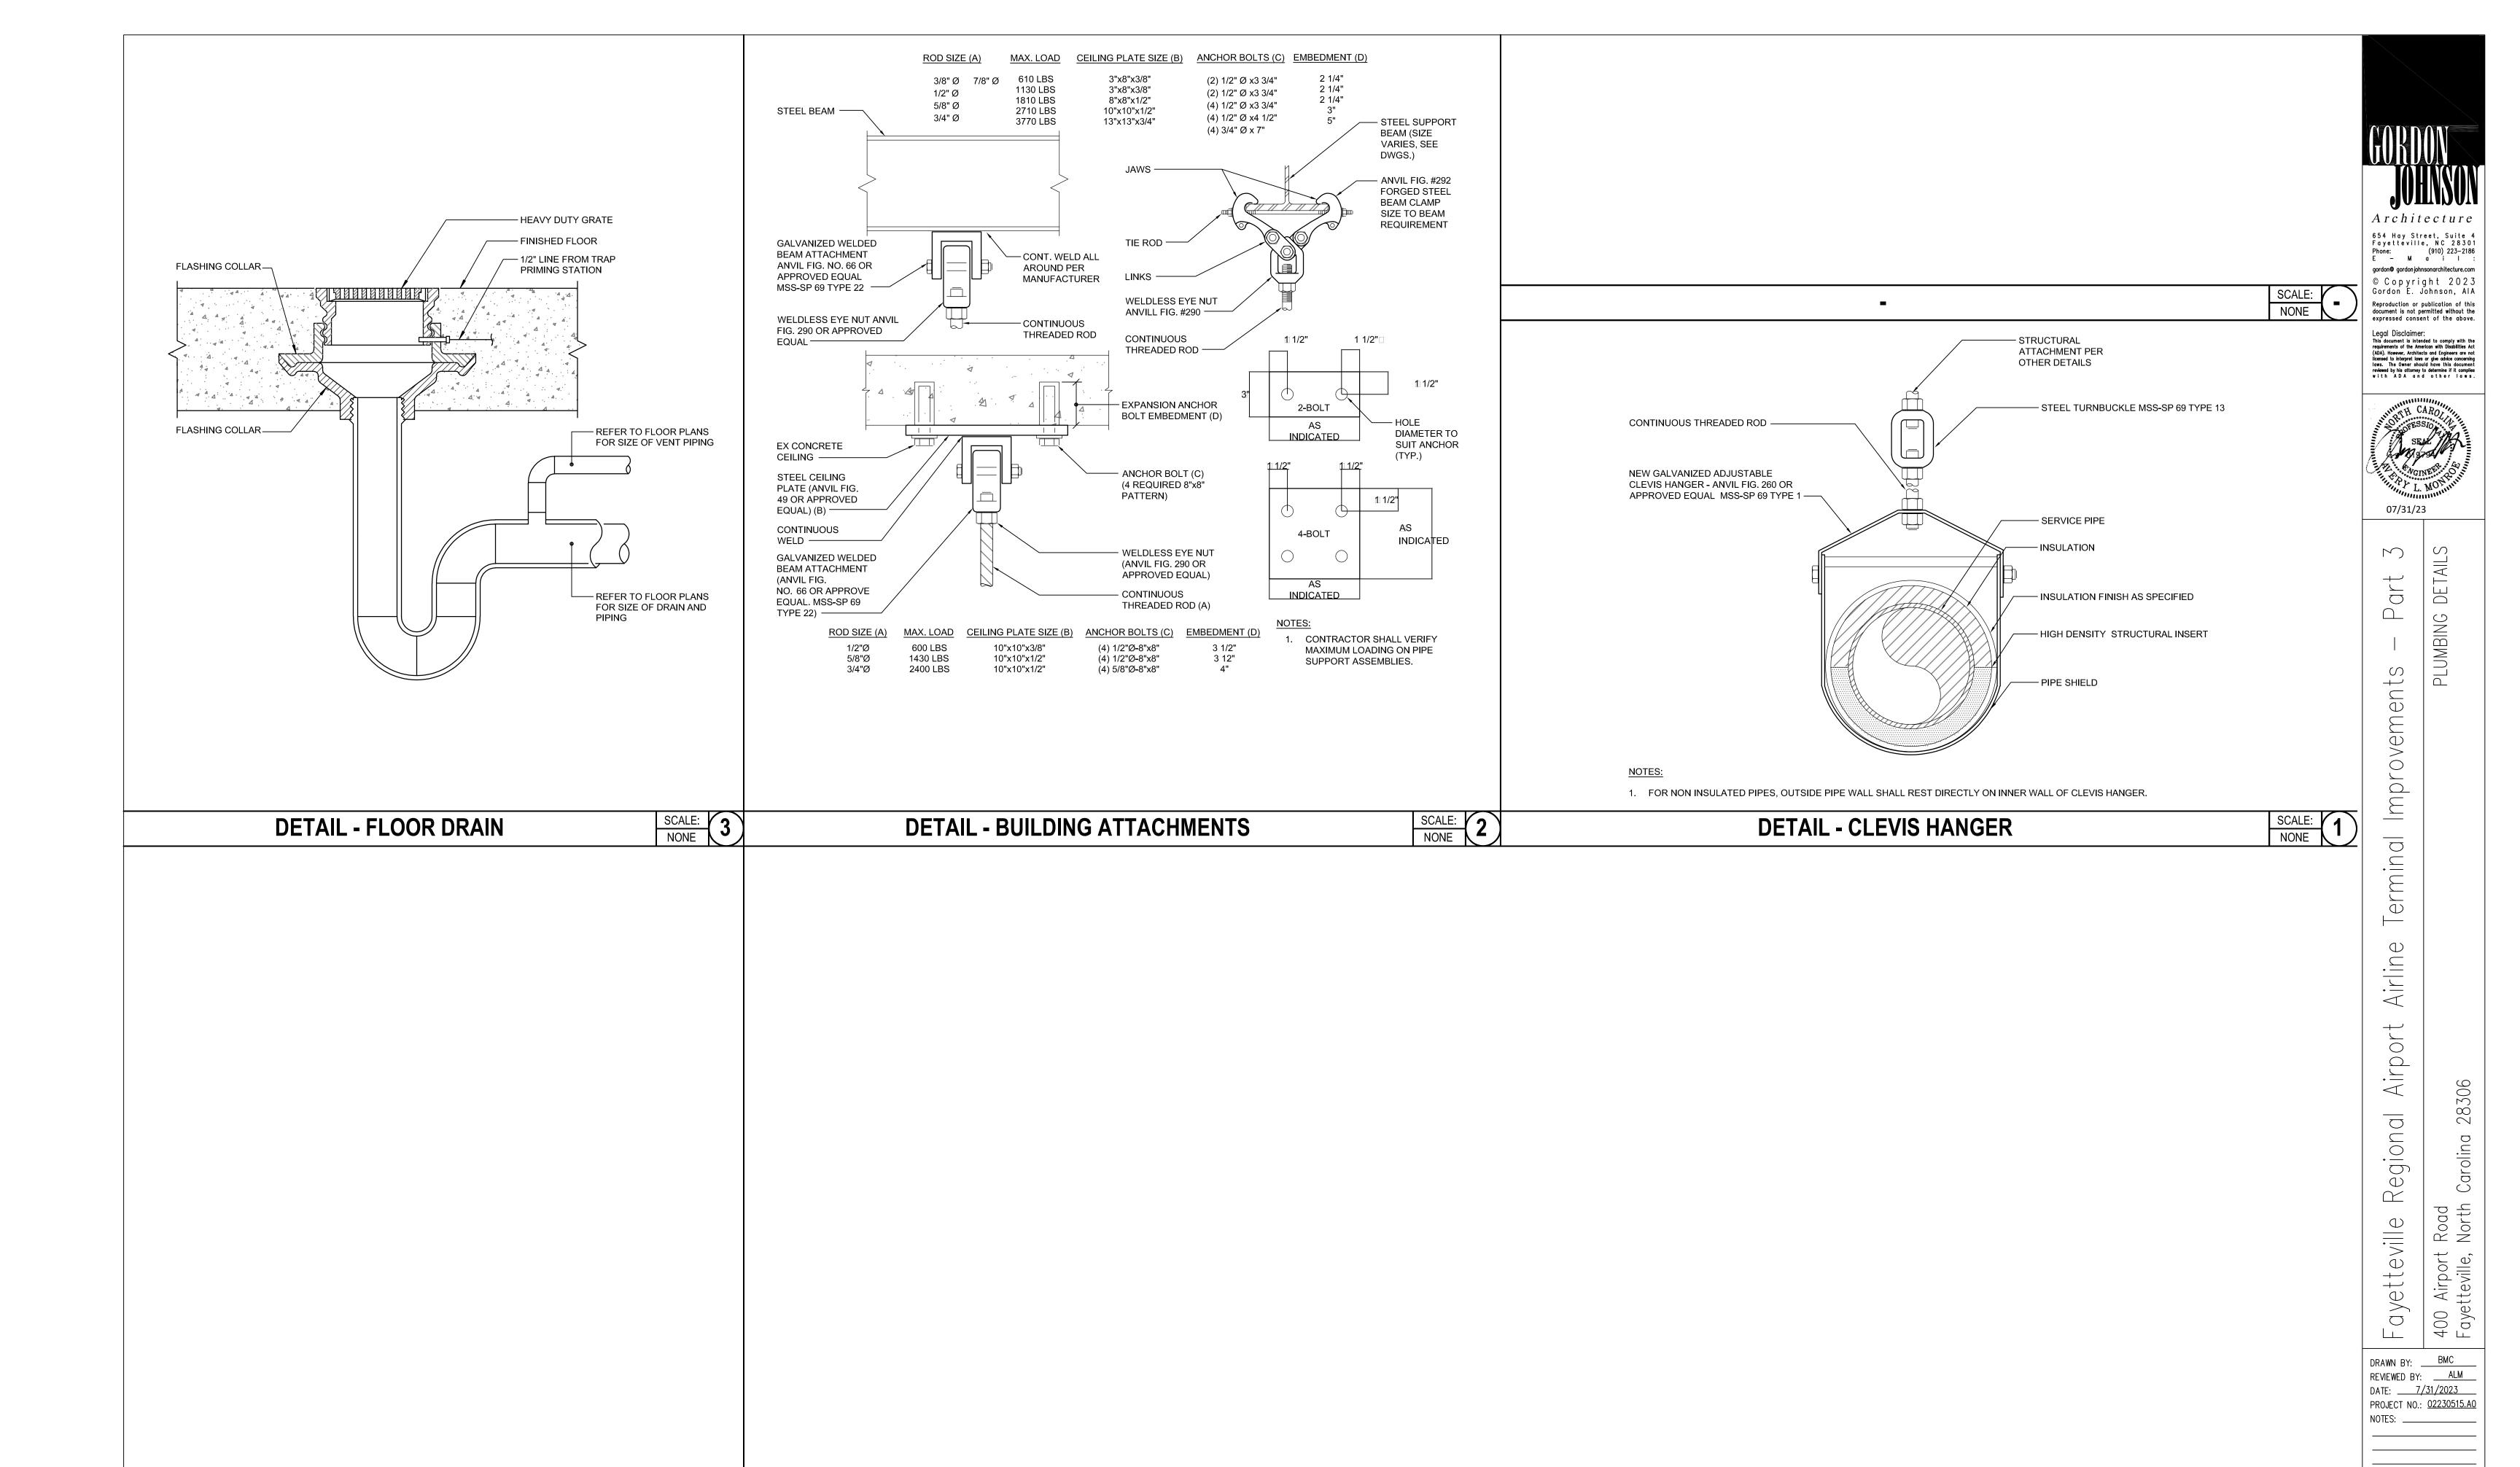

SCALE: NONE

REVISIONS

PLUMBING FIXTURE SCHEDULE											
DESIGNATION FIXTURE FLOW ROUGH—IN CONNECTION FIXTURE UNITS					DEMARKS	NOTES					
DESIGNATION	FIXTURE	GPM	CW	HW	SAN	VENT	CW	HW	SAN	REMARKS N	
P-1	WATER CLOSET	1.28 (GPF)	1"	_	4"	2"	6	_	3	WALL MOUNTED, MANUAL FLUSH VALVE, ADA	1, 6
P-2	LAVATORY	0.5	1/2"	1/2"	2"	1 1/2"	0.5	0.5	1	WALL MOUNTED. BATTERY, AUTOMATIC FAUCET.	2, 6
P-3	LAVATORY	0.5	1/2"	1/2"	2"	1 1/2"	0.5	0.5	1	LAVATORY PROVIDED WITH CASEWORK. BATTERY, AUTOMATIC FAUCET.	3, 6
P-4	BREAK ROOM SINK	1.5	1/2"	1/2"	2"	1 1/2"	1	1	2	STAINLESS STEEL, TWO COMPARTMENT SINK	4, 6
P-5	SHOWER	1.5	1/2"	1/2"	2"	1 1/2"	1	1	2	ADA, BUILT IN CERAMIC TILE BASE BY ARCHITECT	5, 6

NOTES:

- BASIS OF DESIGN: WATER CLOSET: KOHLER, K-4325 FLUSH VALVE: SLOAN, 111-1.28 DFB
- BASIS OF DESIGN: LAVATORY: PROVIDED WITH CASEWORK FAUCET: SLOAN, SF-2350
- 3. BASIS OF DESIGN: LAVATORY: KOHLER, K-2005 FAUCET: SLOAN, SÉ-2350

- 4. BASIS OF DESIGN: SINK: ELKAY, LR3322 FAUCET: DELTA, 400-DST
- 5. BASIS OF DESIGN: SHOWER: BUILT IN CERAMIC TILE BASE BY ARCHIECT FAUCET: SYMMONS SAFETYMIX, 1-117-FS
- 6. SEE SPEC SECTION 224000 FOR EQUIVALENT MANUFACTURERS

SHOCK ARRE	ESTOR SCHEDULE		
DESIGNATION	FIXTURE UNITS SERVED		
SA-"A"	1-11		
SA-"B"	12-32		

FLOOR DRAIN SCHEDULE						
DESIGNATION	TYPE	BASIS OF DESIGN				
FD-1	3" DRAIN, ROUND GRATE	ZURN – Z415B				
FD-2	2" DRAIN, ROUND GRATE	ZURN - Z415-BZ1				


NOTES:

1. SEE SPEC SECTION 221319 FOR EQUIVALENT MANUFACTURERS



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28306

Fayetteville DRAWN BY: _____BMC

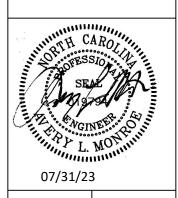REVIEWED BY: ____ALM

DATE: ____7/31/2023

PROJECT NO.: 02230515.A0

REVISIONS